ABBREVIATIONS

&	AND	GV	GAS VALVE	STRG	STRINGER
@	ANOLIOD POLT	GWB	GYPSUM WALL BOARD	STRUCT	STRUCTURE OR STRUCTURAL
AB AC	ANCHOR BOLT AIR CONDITIONING	GYP H	GYPSUM HIGH/HEIGHT	SUBCAT	SUBCATEGORY
ACC	ACCESSIBLE	HB	HOSE BIB	SUSP	SUSPENDED
ACOUST	ACOUSTICAL	HC	HANDICAPPED	SV	SHEET VINYL
ACT	ACOUSTIC CEILING	HDW	HARDWARE	SW	SOUTHWEST
AD	TILE ACCESS DOOR	HDWD	HARDWOOD	SYM	SYMMETRICAL SYSTEM
ADD	ADDENDUM	HNDRL	HOLLOW METAL HANDRAIL	T	TREAD
ADJ	ADJACENT	HO	HOLD OPEN	T&B	TOP AND BOTTOM
AFF	ABOVE FINISHED	HORIZ	HORIZONTAL	T&G	TONGUE AND
AFG	FLOOR ABOVE FINISHED	HP	HIGH POINT	TD	GROOVE TOWEL BAR
AFG	GRADE	HR	HOUR	TB TEL	TELEPHONE/TELEC
AGGR	AGGREGATE	HRC	HOSE REEL CABINET HEIGHT	TELE	TELEPHONE
ALT	ALTERNATE	HTR	HEATER	TEMP	TEMPERATURE
ALUM	ALUMINUM	HVAC	HEATING	TEMP	TEMPORARY
ANOD APC	ANODIZED ACOUSTICAL PANEL		VENTILATION AND AIR	TH	THICKNESS
\ \ \ \ \ \ \ \ \ \ \ \ \ \ \ \ \ \ \	CEILING	HW	CONDITIONING HOT WATER	THRU	THRESHOLD THROUGH
APPROX	APPROXIMATE	ID	INSIDE DIAMETER	TKBD	TACK BOARD
ARCH	ARCHITECTURAL	IGU	INSULATED GLASS	TLT	TOILET
ASPH ATTN	ASPHALT ATTENTION		UNIT	TMPD	TEMPERED
AUTO	AUTOMATIC	IN	INCH/INCHES	ТО	TOP OF
AV	AUDIOVISUAL	INCAND	INCANDESCENT INCLUDED/INCLUDING	TOB	TOP OF BEAM
BD	BOARD	INFO	INFORMATION	TOC	TOP OF CONCRETE TOP OF STEEL
BET, BTW	BETWEEN	INSUL	INSULATION OR	TPD	TOILET PAPER
BIT	BITUMINOUS		INSULATED	"	DISPENSER
BLDG	BUILDING	INT	INTERIOR	TS	TUBE STEEL
BLK	BLOCK	INTERM	INTERMEDIATE	TV	TELEVISION
BLKG	BLOCKING	INV	INVERT	TYP	TYPICAL
BO	BEAM BOTTOM OF	JAN JC	JANITOR JANITOR'S CLOSET	UL	UNDERWRITERS LABORATORIES
BOT	BOTTOM OF	JST	JOIST	UNFIN	UNFINISHED
BRG	BEARING	JT	JOINT	UNO	UNLESS NOTED
BRK	BRICK	KIT	KITCHEN		OTHERWISE
BRKT	BRACKET	КО	KNOCK OUT	UON	UNLESS OTHERWIS NOTED
BSMNT	BASEMENT	LAM	LAMINATED	URNL	URINAL
CAB	CHANNEL CABINET	LAV LB	LAVATORY POUNDS	VAC	VENTILATION AND A
CAT	CATEGORY	LF	LINEAR FEET		CONDITIONING
СВ	CATCH BASIN	LLH	LONG LEG	VAR	VARIES
СВ	CEMENT BOARD		HORIZONTAL	VAT	VINYL ASBESTOS TI
CBU	CEMENTITIOUS	LLV	LONG LEG VERTICAL	VB VCT	VAPOR BARRIER VINYL COMPOSITIO
00	BACKER UNIT	LT	LIGHT	VOI	TILE
CCTV	CENTER TO CENTER CLOSED CIRCUIT	MANUF	LIGHTWEIGHT MANUFACTURER	VERT	VERTICAL
0017	TELEVISION	MAS	MASONRY	VEST	VESTIBULE
CEM	CEMENT	MATL	MATERIAL	VIF	VERIFY IN FIELD
CER	CERAMIC	MAX	MAXIMUM	VP VR	VISION PANEL VAPOR RETARDER
CG	CORNER GUARD	MECH	MECHANICAL	VT	VINYL TILE
CH	CHILLER CAST IRON	MED	MEDIUM	VTR	VENT THROUGH RO
CI	CAST INON CAST-IN-PLACE	MEMBR MH	MEMBRANE	VWC	VINYL WALL
CJ	CONTROL JOINT	MIN	MAN HOLE MINIMUM		COVERING
CK	CORK	MISC	MISCELLANEOUS	W	WIDE/WEST
CL	CENTERLINE	MO	MASONRY OPENING	W/ W/O	WITH
CLG	CEILING	MR	MOISTURE RESISTANT	WC	WATER CLOSET
CLR	CLEAR	MTD	MOUNTED	WD	WOOD
CLT	CLOSET CERAMIC MOSAIC TILE	MTG	MOUNTING	WIN	WINDOW
CMU	CONCRETE MASONRY	MTL MULL	METAL MULLION	WM	WIRE MESH
ONIO	UNIT	N	NORTH	WP	WATERPROOF/WAT
CNTR	COUNTER	NA	NOT APPLICABLE	WPM	PROOFING WATERPROOF
co	CLEANOUT	NC	NOISE CRITERIA	VVI 101	MEMBRANE
COL	COLUMN	NIC	NOT IN CONTRACT	WS	WEATHER-STRIPPIN
CONC	CONCRETE CONDITION	NO	NUMBER	WSCT	WAINSCOT
COND	CONDITION	NOM	NOMINAL	WT	WEIGHT
CONST	CONSTRUCTION	NON COMB	NON COMBUSTIBLE	WV	WATER VALVE
CONT	CONTINUOUS	NTS NW	NOT TO SCALE NORTHWEST	WWF	WELDED WIRE FABI
CONTR	CONTRACTOR	OA	OUTSIDE AIR	AA AAIAI	WELDED WIRE MES
COORD	COORDINATE	OC	ON CENTER		
CORR	CORRIDOR	OD	OUTSIDE DIAMETER		
CPT	CARPET CERAMIC TILE	OD	OVERFLOW DRAIN		
CTR	CENTER	OFCI	OWNER FURNISHED, CONTRACTOR		
CTSK	COUNTERSLINK		INSTALLED		

POWER DRIVEN FASTENER

PERFORATED

PLASTIC LAMINATE

POUNDS PER LINEAR

PAINT OR PAINTED

PREFABRICATED

POUNDS PER SQUARE

PRESSURE TREATED

POLYVINYL CHLORIDI

QUANTITY

RETURN AIR

ROOF DRAIN

RECEPTACLE

REFRIGERATOR

REINFORCED/REINFO

REFERENCE

RELOCATE

REMOVABLE

RECOMMENDED

REVISION/REVISED

ROUGH OPENING

RAIN WATER LEADER

RIGHT OF WAY

SUPPLY AIR

SELF ADHERED

SOLID CORE

STORM DRAIN

SOUTHEAST

SHOWER

SHEET METAL SURFACE MOUNTED

SANITARY NAPKIN DISPOSAL SEALANT

SPECIFICATION

SPRINKLER OR SPEAKER

STAINLESS STEE

SERVICE SINK

STATION

SEATING

SPEAKER

SCHEDULE

RESILIENT BASE

REFLECTED CEILING PLAN

PLASTER

PLYWOOD

DIMENSIONS

DISPENSER DIVISION DAMP PROOFING

DOOR OPENING

DOWNSPOUT

DRAWING DRAWER EAST

EXPANSION BOLT

EXPANSION JOINT

ELECTRICAL PANEL

PROPYLENE DIENE

ELECTRICAL

ELEVATOR

EMERGENC

ENCLOSURE

ENGINEER

EQUAL EQUIPMENT

EXHAUST

EXISTING EXPANSION

EXPOSED

FIRE ALARM

FACE BRICK

FLOOR DRAIN

(WALL MOUNT

FIRE DEPARTMENT

FIRE EXTINGUISHER

FLUSH FLOOR BOX

FIRE HOSE CABINET

ELEVATION

FLAT HEAD

FLUORESCENT

FOUNDATION

FIBER REINFORCE CONCRETE

FIRE RETARDANT

FEET/FOOT

FABRIC WALL

GAUGE GALVANIZED

GRAB BAR

GENERAL

CONTRACT(OR

GLASS FIBER

REINFORCED CONCRETE

GLAZING

GROUND

GRANULAR

GLASS FIBER REINFORCED GYPSUM

GALVANIZED SHEET METAL


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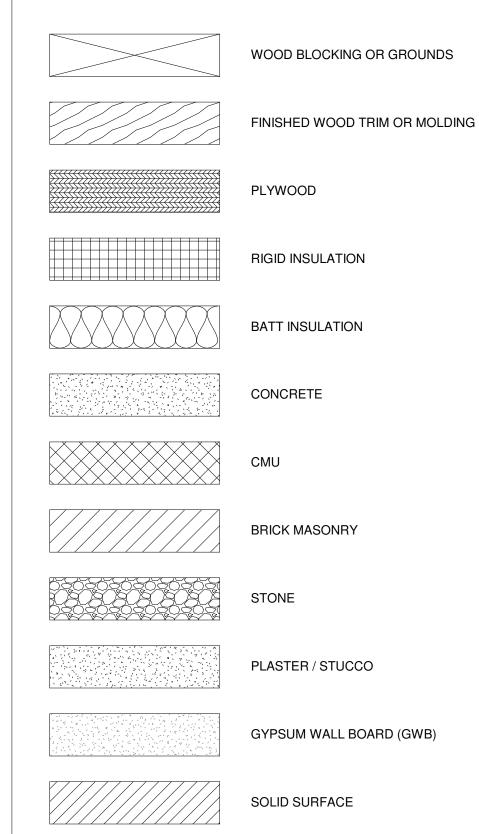
FREDONIA

STATE UNIVERSITY OF NEW YORK



KEY TO MATERIALS

1 Campus Map

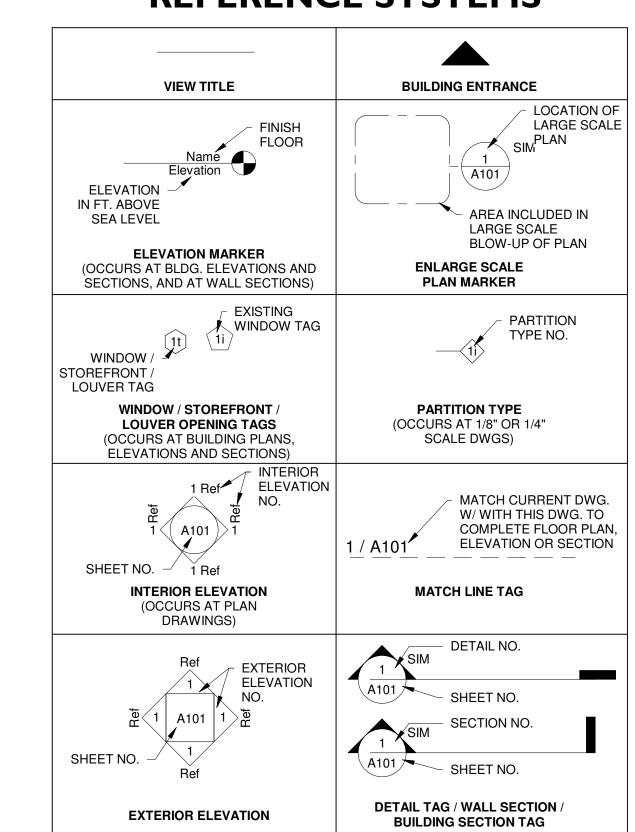

LANFORD REHAB PHASE II EXTERIOR

194 CENTRAL AVENUE FREDONIA, NY 14063

STATE UNIVERSITY OF NEW YORK AT FREDONIA PROJECT NO. 051037 FBA PROJECT NO. 00388

DATE: OCTOBER 1, 2024

STRUCTURAL ENGINEERING ARCHITECTURE

FLYNN BATTAGLIA ARCHITECTS, DPC

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MEP/FP

FOIT-ALBERT

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ELECTRICAL SYMBOLS, NOTES, AND ABBREVIATIONS

ELECTRICAL GARAGE PLAN

ELECTRICAL SCHEDULES AND DETAILS

ASSOCIATES, PC

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ENGINEERING

ENVIRONMENTAL

95 Perry St, Suite 300 Cheektowaga, NY 14203 Telephone (716) 206-5100

EDR, DPC

274 North Goodman Street Rochester, NY 14607 Telephone (585) 271-0040

DRAWING LIST

EXISTING SITE SURVEY

ES-01 EXISTING SITE SURVEY

NOTES, ABBREVIATIONS AND LOCATION MAPS G0-01 DEMOLITION, SEDIMENT AND EROSION CONTROL PLAN MATERIALS AND LAYOUT PLAN GRADING, UTILITIES AND EROSION & SEDIMENT CONTROL

PLANTING PLAN C6-01 DETAILS DETAILS C6-02

SYMBOLS, ABBREVIATIONS, GENERAL NOTES, AND DESIGN

TYPICAL DETAILS FOUNDATION / FIRST FLOOR PLAN SECOND FLOOR FRAMING PLAN ROOF FRAMING PLAN CONCRETE SECTIONS S3-01 FRAMING SECTIONS

FRAMING SECTIONS

S3-02

HAZARDOUS MATERIALS EAST ELEVATION REMOVAL PLAN HAZARDOUS MATERIALS SOUTH ELEVATION REMOVAL

HAZARDOUS MATERIALS WEST ELEVATION REMOVAL PLAN HAZARDOUS MATERIALS NORTH ELEVATION REMOVAL HAZARDOUS MATERIALS REMOVAL GARAGE ELEVATIONS

DEMOLITION

PROJECT DEMO SITE PLAN GARAGE DEMO PLANS GARAGE DEMO ELEVATIONS

HOUSE DEMO EAST AND SOUTH ELEVATIONS HOUSE DEMO WEST AND NORTH ELEVATIONS

HOUSE DEMO ROOF PLAN

CC-01 CODE CONFORMANCE PLANS

SITE PLAN A1-00 GARAGE PLANS A1-01 HOUSE ROOF PLAN

GARAGE ELEVATIONS HOUSE EAST AND SOUTH ELEVATIONS

HOUSE WEST AND NORTH ELEVATIONS HOUSE EXTERIOR DETAILS HOUSE EXTERIOR DETAILS

GARAGE AND HOUSE WINDOW AND DOOR SCHEDULES

FLYNN BATTAGLIA ARCHITECTS, D.P.C.

WITH: THE BUILDING CODE OF NEW YORK STATE AND THE NEW YORK STATE AND APPLICABL FEDERAL LAWS AND REGULATIONS AND TO THE BEST OF MY KNOWLEDGE AND BELIEF, THESE CONSTRUCTION DOCUMENTS AR IN CONFORMANCE THEREWITH

MY SUPERVISION, IN ACCORDANCE

617 Main Street, Suite 401

DATE OF SUCH ALTERATION, AND A SPECIFIC DESCRIPTION OF THE ALTERATION. COPYRIGHT 2024 FLYNN BATTAGLIA ARCHITECTS, D.P.C., ALI

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PROJECT NO. 051037 LANFORD REHAB

PHASE II EXTERIOR 194 CENTRAL AVENUE FREDONIA, NEW YORK 14063


100% CONSTRUCTION DOCUMENT SET

Revision Schedule Revision Number Description

DRAWING ISSUED: 10/01/2024 **Project Number:** Scale: As indicated FBA PROJECT #00345.00 Drawn By: Checked By:

Drawing Title

COVER SHEET

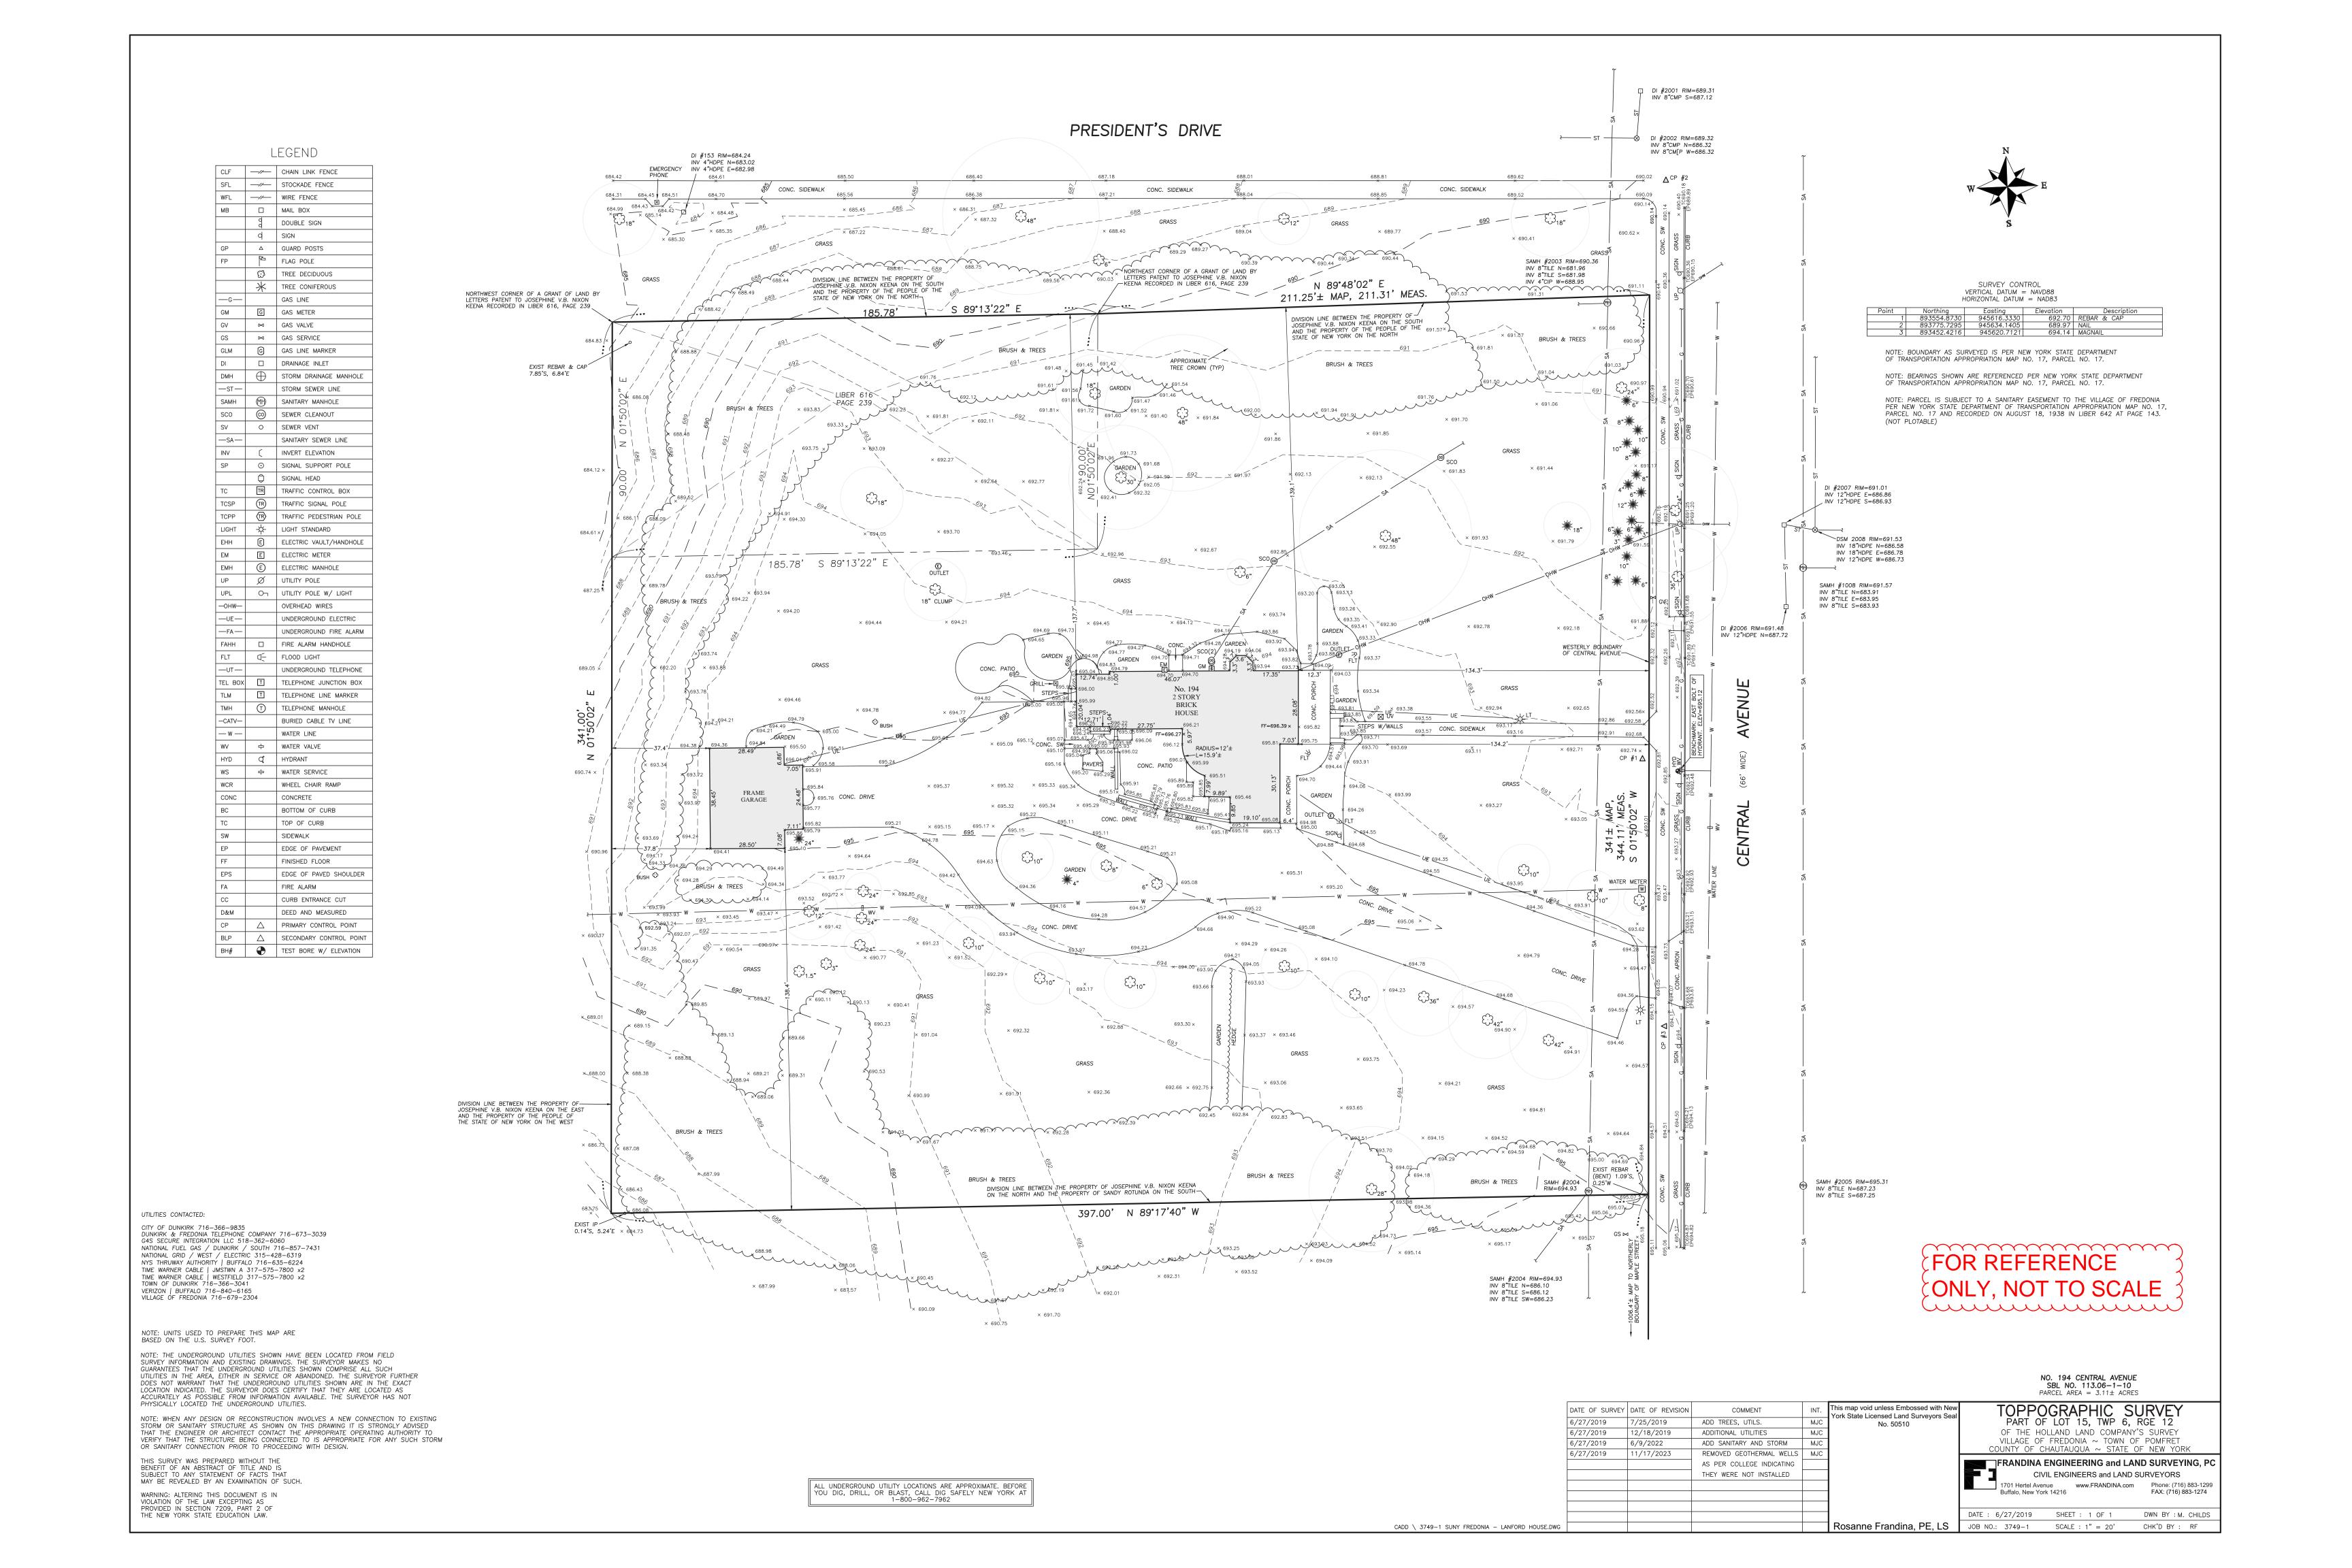

GENERAL NOTES:

- 1. REFER TO PROJECT SPECIFICATIONS FOR ADDITIONAL PROJECT REQUIREMENTS AND COORDINATE WITH PROJECT DRAWINGS.
- 2. THE CONTRACTOR SHALL USE THE WRITTEN DIMENSIONS PROVIDED WITHIN THE CONTRACT DRAWINGS. SCALED DIMENSIONS SHALL NOT BE USED FOR CONSTRUCTION PURPOSES.
- 3. THE CONTRACTOR SHALL CONTACT OWNER'S REPRESENTATIVE IMMEDIATELY IF CLARIFICATION OR INTERPRETATION OF THE CONTRACT DOCUMENTS, OR ANY
- OTHER ASPECTS OF THE PROJECT, IS REQUIRED. 4. LEGEND REPRESENTS STANDARD LINE TYPES AND HATCHING UNLESS INDICATED ON SPECIFIC DRAWINGS.
- 5. THE ABBREVIATIONS AND SYMBOLS HEREIN ARE STANDARD OF THIS OFFICE AND APPLY TO A VARIETY OF PROJECTS. ONLY A PORTION OF THEM WILL NECESSARILY APPLY TO ANY GIVEN PROJECT. SEE THE LISTINGS IN OTHER SECTIONS OF THIS PROJECT FOR ADDITIONAL SYMBOLS AND ABBREVIATIONS.
- 6. EDR IS NOT RESPONSIBLE FOR SITE SECURITY AND SAFETY, OR CONSTRUCTION
- 7. EDR IS NOT RESPONSIBLE FOR THE SEQUENCING OF CONSTRUCTION UNLESS A SEQUENCE OF CONSTRUCTION IS PROVIDED IN THE CONTRACT DOCUMENTS.

SITE CIVIL NOTES:

MEANS AND METHODS.

- 1. THE CONTRACTOR SHALL OBTAIN ALL REQUIRED PERMITS, PAY ALL FEES REQUIRED BY GOVERNING AGENCIES HAVING JURISDICTION OVER THE FACILITIES AND NATURAL FEATURES FOUND ON SITE, AND FURNISH COPIES TO THE OWNER PRIOR TO COMMENCING WORK.
- 2. SITE ACCESS IS RESTRICTED TO THE LOCATIONS SPECIFICALLY DESIGNATED ON
- 3. THE CONTRACTOR SHALL ADHERE TO ALL OCCUPATIONAL SAFETY AND HEALTH ADMINISTRATION (OSHA), STATE AND LOCAL SAFETY REGULATIONS.
- 4. CONTRACTOR SHALL PROMPTLY REPORT TO THE OWNER'S REPRESENTATIVE ANY DISCREPANCIES FOUND ON THE SITE OR IN THE CONTRACT DOCUMENTS FOR REVIEW AND RESOLUTION BEFORE PROCEEDING WITH THE WORK IN THE AREA IN QUESTION. PROVIDE FIELD INFORMATION SPECIFIC TO THE DISCREPANCY TO EXPEDITE RESOLUTION.
- 10. THE BOUNDARY AND TOPOGRAPHIC SURVEY INFORMATION SHOWN ON THIS PLAN WAS PREPARED BY FRANDINA ENGINEERING AND LAND SURVEYING, PC AND DATED
- 06/27/2019 AN REVISED ON 07/25/2019, 12/18/2019, 06/09/2022, AND 11/17/2023. 11. NO SUBSURFACE SOIL INFORMATION WAS OBTAINED ON THIS SITE FOR THIS CONSTRUCTION.
- 12. THE START OF ANY ON-SITE CONSTRUCTION INCLUDING STRIPPING TOPSOIL REMOVING CUT OR PLACING FILL MATERIAL ESTABLISHES THAT THE CONTRACTOR ACCEPTS THE CONTRACT DOCUMENTS AS ACCURATELY REPRESENTING THE EXISTING SITE CONDITIONS.
- 13. DURING SALVAGE OPERATIONS FOR MATERIAL INTENDED FOR REUSE ON SITE, MATERIAL MAY BE DAMAGED AND OR NOT SUITABLE FOR REUSE. THE CONTRACTOR SHALL VERIFY QUANTITY AND QUALITY OF SALVAGED MATERIAL AND NOTIFY THE OWNER'S REPRESENTATIVE OF ANY DEFICIENCIES.
- 14. ALL FACILITIES TO BE CONSTRUCTED OR INSTALLED SHALL COMPLY WITH ALL SECTIONS AND LATEST REVISIONS OF THE REQUIREMENTS OF ALL AGENCIES OF GOVERNMENT HAVING JURISDICTION.
- 15. LONG LEAD AND SCARCE MATERIALS SHALL BE ORDERED IN A TIMELY MANNER TO PREVENT AVOIDABLE CONSTRUCTION DELAYS.
- 16. THE CONTRACTOR IS RESPONSIBLE FOR ALL DAMAGE CAUSED BY CONSTRUCTION TO EXISTING UTILITIES AND FACILITIES WHICH ARE NOT INCLUDED AS PART OF THE INTENDED WORK. THE CONTRACTOR SHALL REPAIR, RESTORE AND/OR REPLACE ALL DAMAGE TO THE SATISFACTION OF OWNER'S REPRESENTATIVE AT NO
- ADDITIONAL COST TO THE OWNER. 17. ALL AREAS DISTURBED DURING CONSTRUCTION SHALL BE RESTORED TO A CONDITION EQUAL TO THAT WHICH EXISTED PRIOR TO CONSTRUCTION IN
- ACCORDANCE WITH SPECIFICATIONS. 18. THE CONTRACTOR SHALL RESTORE ALL DISTURBED SURFACES TO ORIGINAL OR BETTER CONDITION INCLUDING 6 INCHES OF TOPSOIL, SEED, FERTILIZER, AND MULCH. OTHER SURFACES SHALL BE RESTORED AS SHOWN ON THE DETAILS.
- 19. CONTRACTOR SHALL PROVIDE POSITIVE SITE DRAINAGE DURING CONSTRUCTION OPERATIONS. ALL FINAL LINES AND GRADES SHALL BE CONSTRUCTED TO MAINTAIN POSITIVE SITE DRAINAGE TO EXISTING DRAINAGE STRUCTURES.
- 20. ALL PAVEMENT SHALL BE SAW CUT PRIOR TO RESTORATION.
- 21. CONTRACTOR SHALL COORDINATE STAGING AREAS WITH OWNER. 22. WHILE EVERY EFFORT HAS BEEN MADE TO IDENTIFY THE ITEMS TO BE
- DEMOLISHED, IT IS CONTRACTOR'S RESPONSIBILITY TO REVIEW THE SCOPE OF WORK IN THE FIELD, REVIEW THESE CONTRACT DRAWINGS, ALL PREVIOUS CONSTRUCTION DRAWINGS & DOCUMENTS AND THE DEVELOPMENT SPECIFICATIONS, THE EXISTING FACILITY PLANS, AND DEMOLISH ALL ITEMS NECESSARY TO ACCOMMODATE THE PROPOSED WORK. THE CONTRACTOR SHALL ALSO REPAIR ALL SURFACES AND PLUG ABANDONED PENETRATIONS UPON REMOVAL OF THE DEMOLISHED ITEMS PER THE SPECIFICATIONS.
- 23. CONTRACTOR SHALL VISIT AND EXAMINE THE SITE TO FULLY UNDERSTAND ALL THE CONDITIONS PERTAINING TO THE SCOPE OF WORK, UNDERSTAND DIFFICULTIES TO BE ENCOUNTERED AND MATERIALS REQUIRED FOR THE COMPLETE INSTALLATION OF THE WORK SHOWN ON THE DRAWINGS AND OR SPECIFIED AT NO ADDITIONAL COST TO THE OWNER. THE EXACT LOCATION OF THE EXISTING PIPING, EQUIPMENT, SERVICES, CONDITIONS, ETC. SHALL BE FIELD VERIFIED. THE EXISTING SIZE OF PIPING, EQUIPMENT, ETC. SHALL BE FIELD VERIFIED. ALL PIPING, AND EQUIPMENT ELEVATIONS SHOWN OR SPECIFIED SHALL BE FIELD VERIFIED. CONTRACTOR SHALL MODIFY LAYOUT WITH THE APPROVAL OF THE ENGINEER WHERE REQUIRED TO CLEAR OBSTRUCTIONS AT NO ADDITIONAL COST TO THE OWNER.
- 24. THE CONTRACTOR SHALL TAKE ALL NECESSARY PRECAUTIONS AND MAKE ALL NECESSARY PROVISIONS FOR PROTECTION OF THE PUBLIC, THE WORKMEN AND THE WORK, AND FOR MAINTENANCE AND PROTECTION OF PEDESTRIAN AND VEHICULAR TRAFFIC AS REQUIRED BY THE AGENCIES OF GOVERNMENT HAVING JURISDICTION.
- 25. PROMPTLY REPORT TO THE OWNER'S REPRESENTATIVE ANY DISCREPANCIES FOUND ON THE SITE OR IN THE CONTRACT DOCUMENTS FOR REVIEW AND RESOLUTION BEFORE PROCEEDING WITH THE WORK IN THE AREA IN QUESTION. PROVIDE FIELD INFORMATION SPECIFIC TO THE DISCREPANCY TO EXPEDITE RESOLUTION.
- 26. LOCATE, PROTECT, AND MAINTAIN BENCHMARKS, MONUMENTS, CONTROL POINTS AND PROJECT ENGINEERING REFERENCE POINTS.
- 27. COMPLY WITH ALL LOCAL, STATE AND FEDERAL REQUIREMENTS REGARDING MATERIALS, METHODS OF WORK AND DISPOSAL OF EXCESS AND WASTE **MATERIALS**
- 28. BURNING OF MATERIALS OF ANY DESCRIPTION ON THE SITE IS PROHIBITED. 29. PRIOR TO PERFORMING ANY EXCAVATION WITHIN THE CONSTRUCTION AREA, CONFIRM WITH DIG SAFELY NEW YORK AT 1-800-962-7962 THAT ALL EXISTING UNDERGROUND UTILITY LOCATIONS ARE CURRENTLY VERIFIED, OR ARRANGE FOR VERIFICATION.

UTILITIES NOTES

1. EXISTING UTILITIES (PIPE/STRUCTURE LOCATIONS, SIZES, AND INVERT ELEVATIONS) SHOWN ON THESE PLANS HAVE BEEN PLOTTED FROM FIELD SURVEYS AND RECORDED MAPS AND SHALL BE INTERPRETED AS APPROXIMATE ONLY. THE CONTRACTOR IS RESPONSIBLE FOR DETERMINING AND FIELD VERIFYING ALL EXISTING INFORMATION AT ALL LOCATIONS IN CLOSE PROXIMITY TO THE UTILITIES AND WORK UNDER CONSTRUCTION. THIS INFORMATION INCLUDES BUT IS NOT LIMITED TO EXISTING PIPE AND STRUCTURE SIZES, PIPE AND STRUCTURE LOCATIONS, PIPE SLOPES, STRUCTURE RIM AND INVERT ELEVATIONS, PIPE MATERIALS AND PIPE CONDITIONS. THIS SHALL INCLUDE PIPE INVERTS, MATERIALS AND SIZES FOR UTILITIES CONNECTING TO DOWNSTREAM STRUCTURES. THIS VERIFICATION SHALL BE COMPLETED PRIOR TO THE COMMENCEMENT OF SHOP DRAWING SUBMITTALS, ORDERING OF MATERIALS, AND THE START OF ANY REMOVALS FOR THIS PROJECT. ANY PROPOSED MODIFICATIONS TO THE DESIGN SHALL BE SUBMITTED AS SHOP DRAWINGS INCLUDING BUT NOT LIMITED TO DESIGN DRAWINGS AND UTILITY PROFILES INCLUDING PIPE AND STRUCTURE LAYOUT STRUCTURE RIM AND INVERT ELEVATIONS, AND PIPE SIZES, MATERIALS AND SLOPES.

- 2. THE OWNER'S REPRESENTATIVE SHALL REVIEW THE LAYOUT OF ALL PAVEMENTS, UTILITIES, AND PLANTINGS IN THE FIELD BEFORE INSTALLATION. THE CONTRACTOR SHALL SCHEDULE ADVANCED NOTIFICATION TO THE OWNER'S REPRESENTATIVE TO FACILITATE TIMELY REVIEW.
- 3. THE OWNER ONLY SHALL OPERATE EXISTING VALVES AND FIRE HYDRANTS, INCLUDING NEWLY INSTALLED VALVES AND FIRE HYDRANTS THAT HAVE BEEN PLACED INTO SERVICE. THE CONTRACTOR IS ADVISED THAT WATERTIGHT CONDITIONS MAY NOT EXIST WHEN EXISTING VALVES ARE CLOSED.
- 4. THE CONTRACTOR SHALL NOTIFY THE OWNER OF ANY UTILITY POLE IN ADVANCE OF ANY EXCAVATION WORK THAT WILL TAKE PLACE WITHIN 5' OF THE UTILITY POLE. THE CONTRACTOR SHALL INCLUDE THE COST OF TEMPORARY POLE SUPPORT IN THE APPROPRIATE BID ITEM. WHERE UTILITY POLES ARE REQUIRED TO BE SUPPORTED DURING CONSTRUCTION, THE CONTRACTOR SHALL MAKE ALL NECESSARY ARRANGEMENTS WITH THE UTILITY COMPANY.
- 5. THE CONTRACTOR SHALL BE RESPONSIBLE FOR DEWATERING AND MAINTENANCE OF SURFACE WATER AND/OR GROUNDWATER ENCOUNTERED DURING THE COURSE OF WORK.
- 6. PRIOR TO START OF WORK, THE CONTRACTOR SHALL PROVIDE EXPLORATORY EXCAVATIONS AND COORDINATE ALL PIPING LAYOUTS WITH THE OWNER'S REPRESENTATIVE TO ELIMINATE ALL CONFLICTS WITH EXISTING UTILITIES.
- 7. THE USE OF EXPLOSIVES OF ANY DESCRIPTION ON THE SITE IS PROHIBITED. 8. CONSTRUCTION DEBRIS AND DEMOLISHED MATERIALS SHALL BE REMOVED FROM THE SITE AT REGULAR INTERVALS AS DETERMINED BY THE OWNER'S
- REPRESENTATIVE AND SHALL NOT BE ALLOWED TO ACCUMULATE. EMPLOY APPROPRIATE MEASURES TO PREVENT LOOSE DEBRIS FROM LEAVING THE CONSTRUCTION AREA. 9. THE CONTRACTOR IS RESPONSIBLE FOR ALL DAMAGE CAUSED BY CONSTRUCTION
- TO EXISTING UTILITIES AND FACILITIES WHICH ARE NOT INCLUDED AS PART OF THE INTENDED WORK. THE CONTRACTOR SHALL REPAIR, RESTORE AND/OR REPLACE ALL DAMAGE TO THE SATISFACTION OF UTILITY'S REPRESENTATIVE AT NO ADDITIONAL COST TO THE OWNER.
- 10. PERFORM WORK AND PROVIDE ALL MATERIALS NECESSARY TO DISCONNECT OR RELOCATE EXISTING UTILITIES. COORDINATE WITH THE RESPECTIVE UTILITY COMPANIES FOR SHUTOFF AND RECONNECTION OF ACTIVE SERVICES. RECORD EXISTING UTILITY TERMINATION POINTS BEFORE DISCONNECTION.
- 11. ADJUST THE RIM ELEVATIONS OF EXISTING UTILITY STRUCTURES SCHEDULED TO REMAIN WITH THE FINISHED GRADE ELEVATIONS.
- 12. THE CONTRACTOR SHALL MAINTAIN EXISTING SANITARY SEWER AND WATER SERVICES AT ALL TIMES, EXCEPT DURING APPROVED AND SCHEDULED INTERRUPTIONS. THE CONTRACTOR SHALL SUBMIT A PROPOSED WORK SCHEDULE AND A DETAILED SANITARY SEWER BY-PASS PROCEDURE TO THE OWNER'S REPRESENTATIVE FOR APPROVAL. THE CONTRACTOR SHALL RESTORE GRAVITY SANITARY SEWER SERVICE AT THE END OF EACH WORKDAY. SHOULD THIS NOT BE POSSIBLE, THE CONTRACTOR SHALL PROVIDE AND MAINTAIN TEMPORARY BY-PASS PUMPING OPERATIONS UNTIL NORMAL GRAVITY FLOWS CAN BE RE-ESTABLISHED AT NO ADDITIONAL COST TO THE OWNER.
- 13. ALL STRUCTURES SHALL MEET THE AMERICAN ASSOCIATION OF STATE HIGHWAY & TRANSPORTATION OFFICIALS (AASHTO) H20 LOADING REQUIREMENTS.
- 14. ALL NEW UTILITY LATERALS SHALL BE INSTALLED WITH A MINIMUM 1/4" PER FOOT SLOPE.
- 15. ALL CATCH BASIN GRATES SHALL INCLUDE THE LETTERING, "NO DUMPING".
- 16. ALL EXISTING DRAINAGE FACILITIES SHALL BE MAINTAINED FREE OF DEBRIS AND FOREIGN MATTER AND BE IN OPERATION THROUGHOUT CONSTRUCTION.
- 17. ALL PROPOSED WATER MAIN PIPING SHALL BE INSTALLED WITH A MINIMUM OF 5-FOOT OF COVER.
- 18. THE CONTRACTOR SHALL COORDINATE DIRECTLY WITH THE OWNER FOR THE WYE DIRECTION (UPSTREAM OR DOWNSTREAM), FOR STORM AND SANITARY SYSTEMS BASED ON THE OWNER'S INFRASTRUCTURE REQUIREMENTS.
- 19. DISTANCES SHOWN ON PIPING ARE HORIZONTAL DISTANCES FROM CENTER OF STRUCTURE TO CENTER OF STRUCTURE, UNLESS OTHERWISE NOTED.
- 20. THE CONTRACTOR IS RESPONSIBLE FOR HANDLING, CUTTING AND DISPOSAL OF ALL ASBESTOS CEMENT (AC) PIPE TO BE REMOVED OR CUT IN ACCORDANCE WITH ALL APPLICABLE REGULATIONS.

EROSION & SEDIMENT CONTROL & POLLUTION PREVENTION NOTES

SUCH AS UNEXPECTED HEAVY RAINFALL

- 1. AVOID ANY DISTURBANCE OF EXISTING VEGETATION ON THE SITE EXCEPT THE VEGETATION SPECIFICALLY DESIGNATED TO BE REMOVED.
- 2. TAKE ALL PRECAUTIONS NECESSARY TO PREVENT EROSION AND CONTROL SEDIMENTATION AS REQUIRED BY THE AGENCIES OF GOVERNMENT HAVING

4. TOP DRESS, SEED, AND MULCH ALL LAWN AREAS DISTURBED BY THE

- 3. THIS PROJECT DOES NOT REQUIRE COVERAGE UNDER THE NEW YORK STATE DEPARTMENT OF ENVIRONMENTAL CONSERVATION (NYSDEC) STATE POLLUTANT DISCHARGE ELIMINATION SYSTEM (SPDES) GENERAL PERMIT FOR STORMWATER DISCHARGES FROM CONSTRUCTION ACTIVITIES, PERMIT NO. GP-0-20-001 (GENERAL PERMIT). THE GENERAL PERMIT AUTHORIZES STORMWATER DISCHARGES TO SURFACE WATERS OF THE STATE FROM CONSTRUCTION RELATED ACTIVITIES.
- CONSTRUCTION AS SOON AS THE FINISHED GRADING OPERATION IS COMPLETED. 5. MAINTAIN AN ADEQUATE SUPPLY OF EROSION AND SEDIMENT CONTROL MATERIALS AT THE CONSTRUCTION SITE AT ALL TIMES TO BE USED FOR URGENT SITUATIONS.
- 6. MAINTENANCE AND REPAIR OF ALL EQUIPMENT AND VEHICLES INVOLVING OIL CHANGES, HYDRAULIC SYSTEM AND FUEL TANK DRAIN DOWN, DEGREASING OPERATIONS AND OTHER ACTIVITIES THAT MAY RESULT IN THE ACCIDENTAL RELEASE OF CONTAMINANTS MUST BE CONDUCTED OFF-SITE. ACCIDENTAL SPILLS MUST BE CLEANED UP IMMEDIATELY AND CONTAMINANTS DISPOSED OF PROPERLY.
- 7. THE CONTRACTOR SHALL ULTIMATELY BE RESPONSIBLE FOR LOCATING SOIL AND EXCESS EXCAVATED EARTH STOCKPILES AT A STABLE LOCATION. STOCKPILES SHALL BE STABILIZED PER THE DETAIL.
- 8. CONSTRUCTION ROUTES SHALL BE STABILIZED PER THE NYS STANDARDS FOR EROSION AND SEDIMENT CONTROL, AS NECESSARY BASED ON SITE CONDITIONS.
- 9. THE CONTRACTOR IS RESPONSIBLE FOR THE PLACEMENT, DESIGN, APPROVAL, AND OPERATION OF THE CONCRETE WASHOUTS. THE CONCRETE WASHOUTS SHALL BE INSTALLED A MINIMUM OF 50' FROM STORM DRAINAGE OR SURFACE WATER. CONCRETE WASTE MATERIAL SHALL NOT BE ALLOWED TO ESCAPE FROM THE CONCRETE WASHOUT.
- 10. SOLID WASTE SHALL BE STORED IN COVERED DUMPSTERS OR OTHER APPROPRIATE CONTAINERS. WASTE IS TO BE DISPOSED OF REGULARLY AND PROPERLY IN ACCORDANCE WITH LOCAL, STATE, AND/OR FEDERAL REGULATIONS.
- 11. THE EROSION AND SEDIMENT CONTROLS ARE SHOWN FOR A CONDITION WHEN ALL WORK IS OCCURRING SIMULTANEOUSLY. ACTUAL INSTALLATIONS SHALL BE ADJUSTED BASED ON CURRENT CONSTRUCTION ACTIVITY AND SITE CONDITIONS.

ABBREVIATIONS

AL	ALUMINUM	DIM	DIMENSION					T	TANGENT
ACT	ACTUAL	DIA	DIAMETER	ID	INSIDE DIAMETER	PA	PLANTING AREA	TB	TEST BORING
APPR	APPROXIMATE/	DMH	DROP MANHOLE	IN	INCH/INCHES	PC	POINT OF CURVATURE	TC	TOP OF CURB
	APPROXIMATELY	DWG	DRAWING	INL	INLET	PL	PROPERTY LINE	TOS	TOP OF SLOPE
				INV	INVERT	PT	POINT OF TANGENT/	TS	TOP OF STAIR
BC	BOTTOM OF CURB	E	EAST	IP	IRON PIPE		PERCOLATION TEST	TW	TOP OF WALL
BLDG	BUILDING	EA	EACH				LOCATION	TYP	TYPICAL
BM	BENCHMARK	EJ	EXPANSION JOINT	JB	JUNCTION BOX	PVC	POLYVINYL CHLORIDE	T&G	TONGUE AND GROOVE
BOS	BOTTOM OF SLOPE	EL	ELEVATION						
BS	BOTTOM OF STAIR	EQ	EQUAL	L	LENGTH/LONG	R	RADIUS		
BW	BOTTOM OF WALL	ES	END SECTION	LA	LANDSCAPE ARCHITECT	RCP	REINFORCED CONCRETE	UD	UNDERDRAIN
B&B	BALLED AND BURLAPPED	EX	EXISTING	LAT	LATITUDE		PIPE	USGS	UNITED STATES
		EXP	EXPANSION	LF	LINEAR FEET	REINF	REINFORCING		GEOLOGICAL SURVEY
CAL	CALIPER			LFT	LEFT	REQD	REQUIRED		
CB	CATCH BASIN	FFE	FINISHED FLOOR ELEVATION	LIN	LINEAR	REV	REVISION	VAR	VARIES/VARIABLE
CF	CUBIC FEET	FG	FINISHED GRADE	LP	LOW POINT	ROW	RIGHT OF WAY	VCP	VITRIFIED CLAY PIPE
CI	CAST IRON	FIN	FINISH			RT	RIGHT	VERT	VERTICAL
CIP	CAST IN PLACE	FL	FLOOR	M	METER				
CIR	CIRCLE/CIRCULAR	FTG	FOOTING	MAX	MAXIMUM	S	SOUTH	W	WEST
CJ	CONTROL JOINT	FT	FOOT/FEET	MH	MANHOLE	SAN	SANITARY	WE	WATER ELEVATION
CLF	CHAIN-LINK FENCE			MIN	MINIMUM	SECT	SECTION	WL	WALK LIGHT
CLL	CONTRACT LIMIT LINE	GA	GAUGE	MISC	MISCELLANEOUS	SF	SQUARE FOOT	WV	WATER VALVE
CLR	CLEAR	GAL	GALLON	MON	MONUMENT	SG	SUB GRADE	WWM	WOVEN WIRE MESH
CMP	CORRUGATED METAL PIPE	GALV	GALVANIZED	1	NODTH	SH	SHEET	W/	WITH
CO	CLEANOUT	GC	GENERAL CONTRACTOR	N	NORTH	SI	STORM INLET	W/O	WITHOUT
COL	COLUMN	GR	GUARDRAIL	NIC	NOT IN CONTRACT	SL	STREET LIGHT		
CONC	CONCRETE	GV	GAS VALVE	NOM	NOMINAL	SPEC	SPECIFICATIONS/	YD	YARD DRAIN
CONT	CONTAINER	1		NTS	NOT TO SCALE		SPECIFIED		
CONTR	CONTRACTOR	HOR	HORIZONTAL	NUM	NUMBER	SQ	SQUARE	€.	CENTER LINE
CPVC	CHLORINATED POLYVINYL	HP	HIGH POINT		ON OFNITED	SS	STAINLESS STEEL	±	PLUS OR MINUS
	CHLORIDE	HT	HEIGHT	OC	ON CENTER	STA	STATION	Δ	CHANGE IN VALUE
CY	CUBIC YARDS	HW	HEAD WALL	OCEW	ON CENTER EACH WAY	STL	STEEL	<	LESS THAN
		HWY	HIGHWAY	OD	OUTSIDE DIAMETER	SY	SQUARE YARD	>	GREATER THAN
DET	DETAIL	HYD	HYDRANT	OP	OUTLET PROTECTION	I			


PROJECT LOCATION




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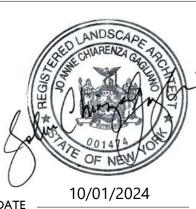


PROJECT SITE

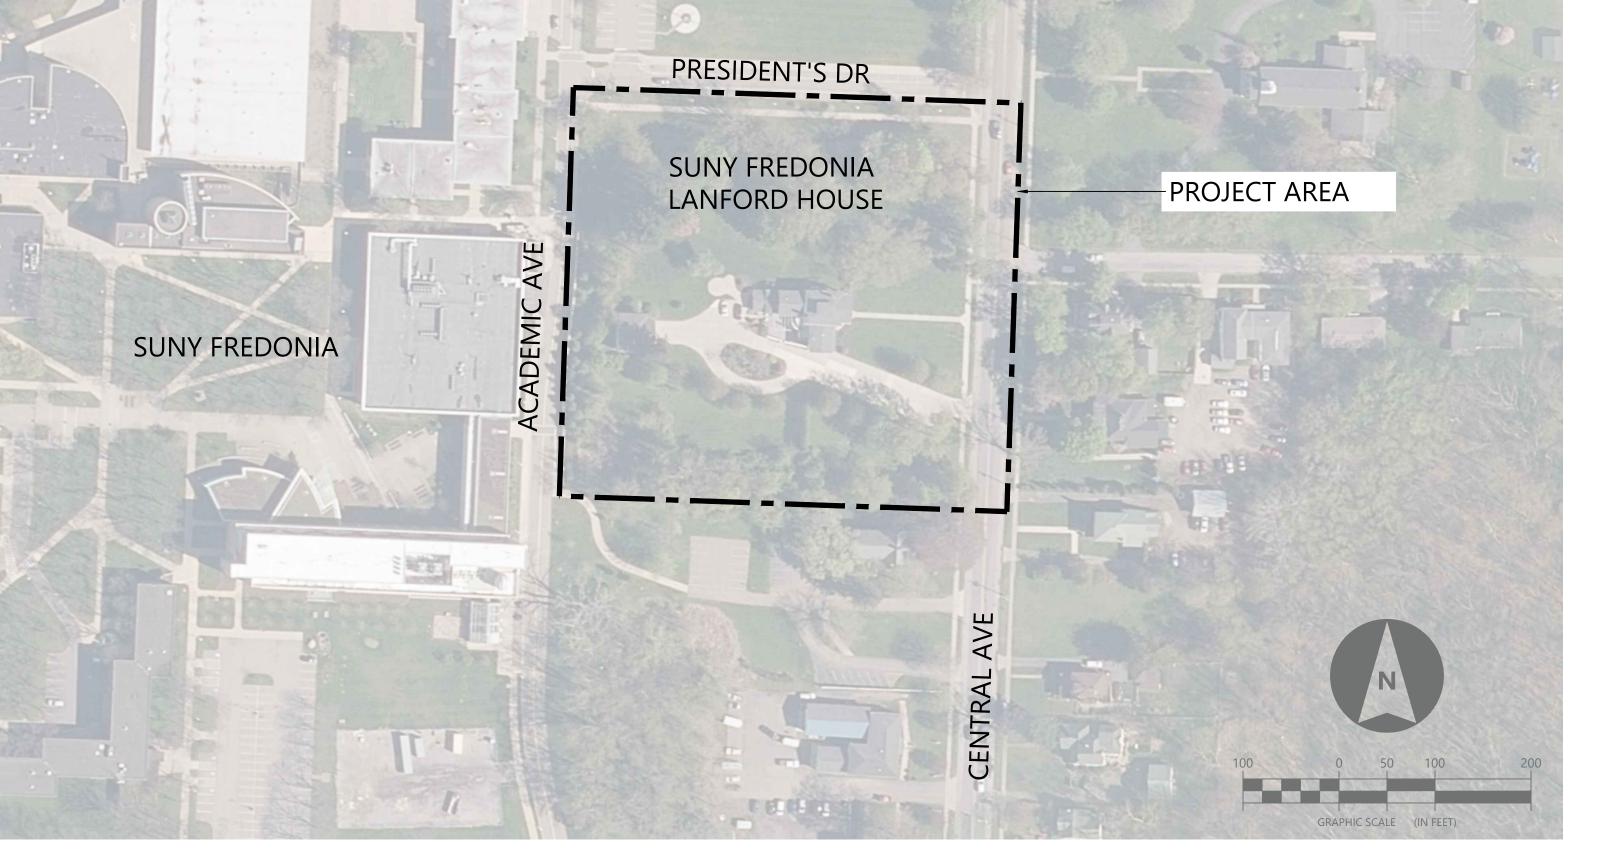

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PROJECT NO. 051037 LANFORD REHAB PHASE II EXTERIOR

194 CENTRAL AVENUE FREDONIA, NEW YORK 14063

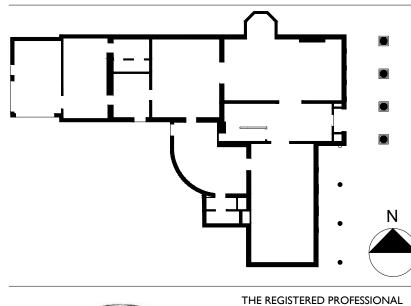
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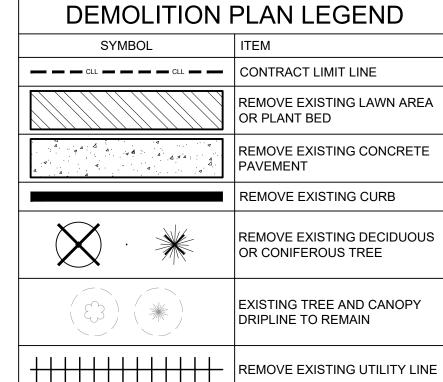
	Revision Sch	ieduie
Revision Number	Date	Description

DRAWING ISSUED: 10/01/2024 Scale: Project Number: AS SHOWN FBA PROJECT #00388.00 Drawn By: Checked By: AML, JRS MOM,DGP, JCG

Drawing Title

NOTES, ABBREVIATIONS AND **LOCATION MAPS**



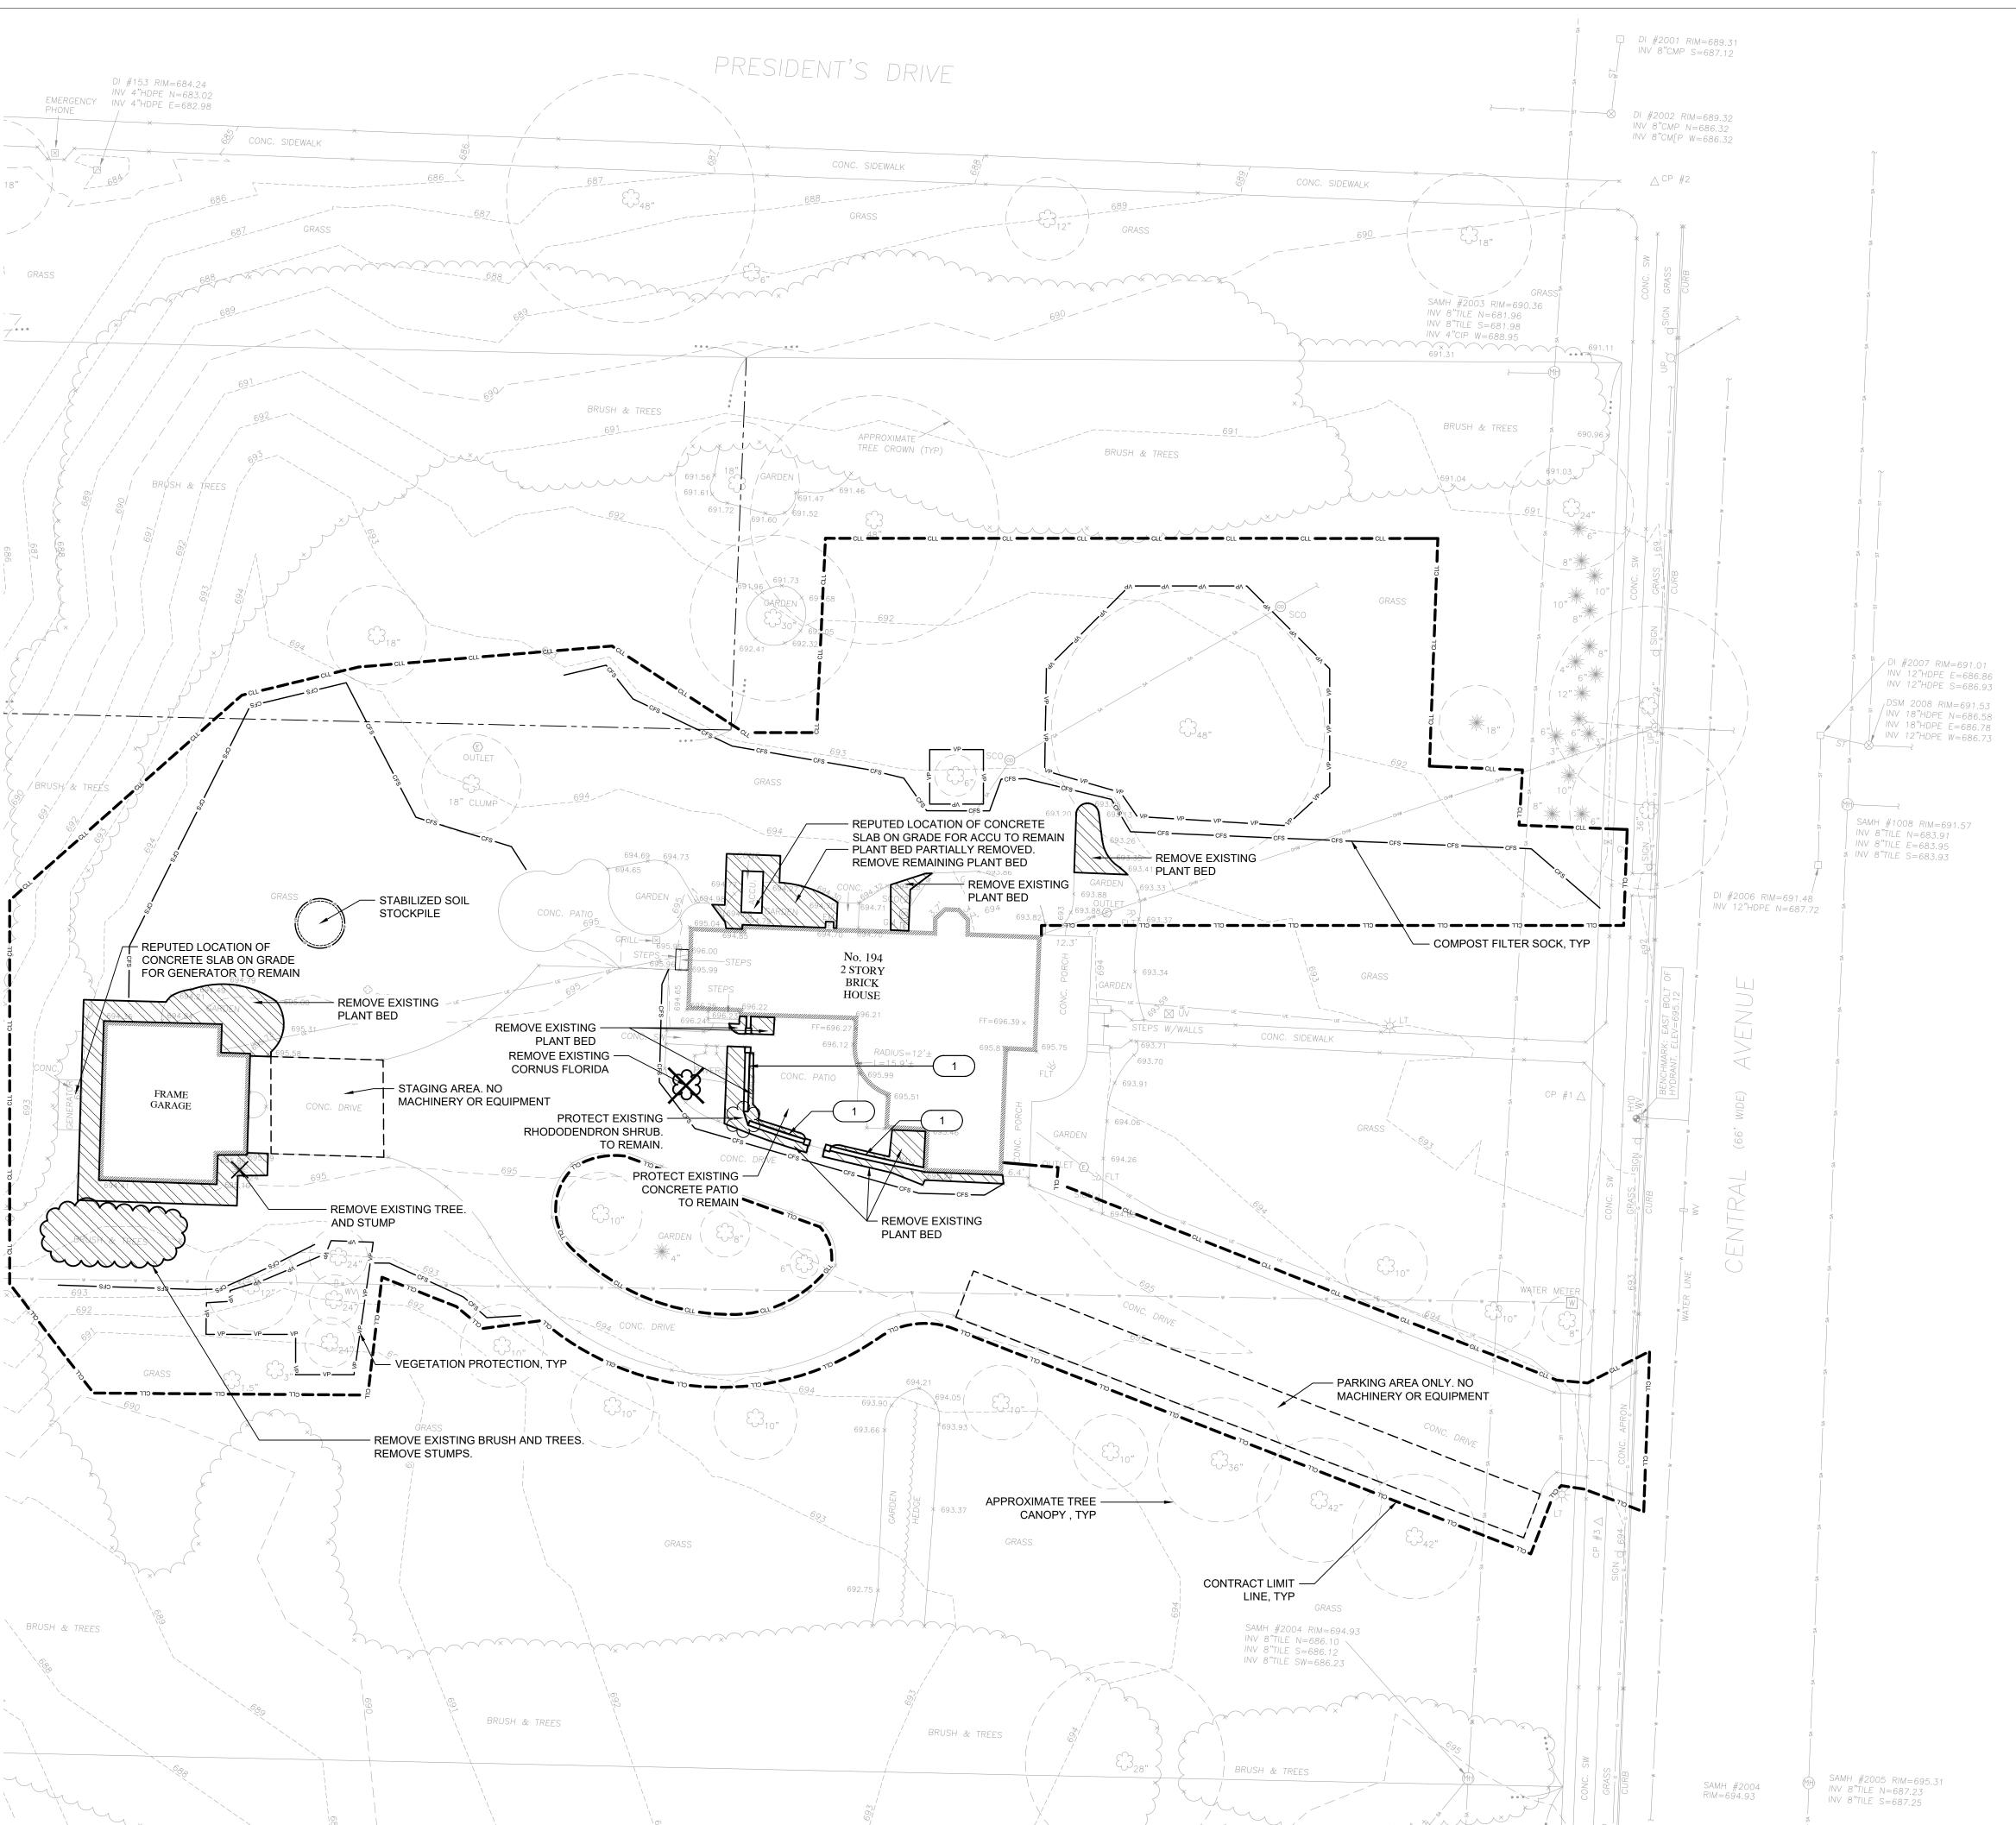

DEMOLITION PLAN NOTE:

SYMBOL

1. CONTRACTOR SHALL TAKE ALL NECESSARY PRECAUTIONS TO PREVENT DAMAGE TO EXISTING PAVEMENT. PREVENTATIVE MEASURES SHALL PROTECT EXISTING STAMPED CONCRETE SURFACE FROM DEGRADATION OR DISCOLORATION.

EROSION CONTROL LINE LEGEND

CLL	— CLL — —	CONTRACT LIMIT LINE		
	— CFS ————	COMPOST FILTER SOCK		
VP VP	VP	VEGETATION PROTECTION		
EROSIC	EROSION CONTROL SYMBOL			
	END			
SYMBOL	SYMBOL ITEM			
CWA	CONCRETE W	ASHOUT AREA		

SEE G0-01 NOTES FOR PLACEMENT


STABILIZED SOIL STOCKPILE

DEMOLITION REFERENCE NOTE

1 REFER TO ARCHITECTURE DRAWINGS AND SPECIFICATIONS FOR WALL RESTORATION AND REFINISHING.

GRAPHIC SCALE (IN FEET)

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194 CENTRAL AVENUE FREDONIA, NEW YORK 14063
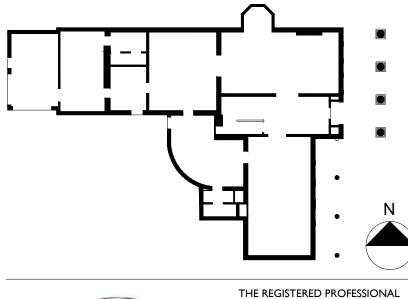
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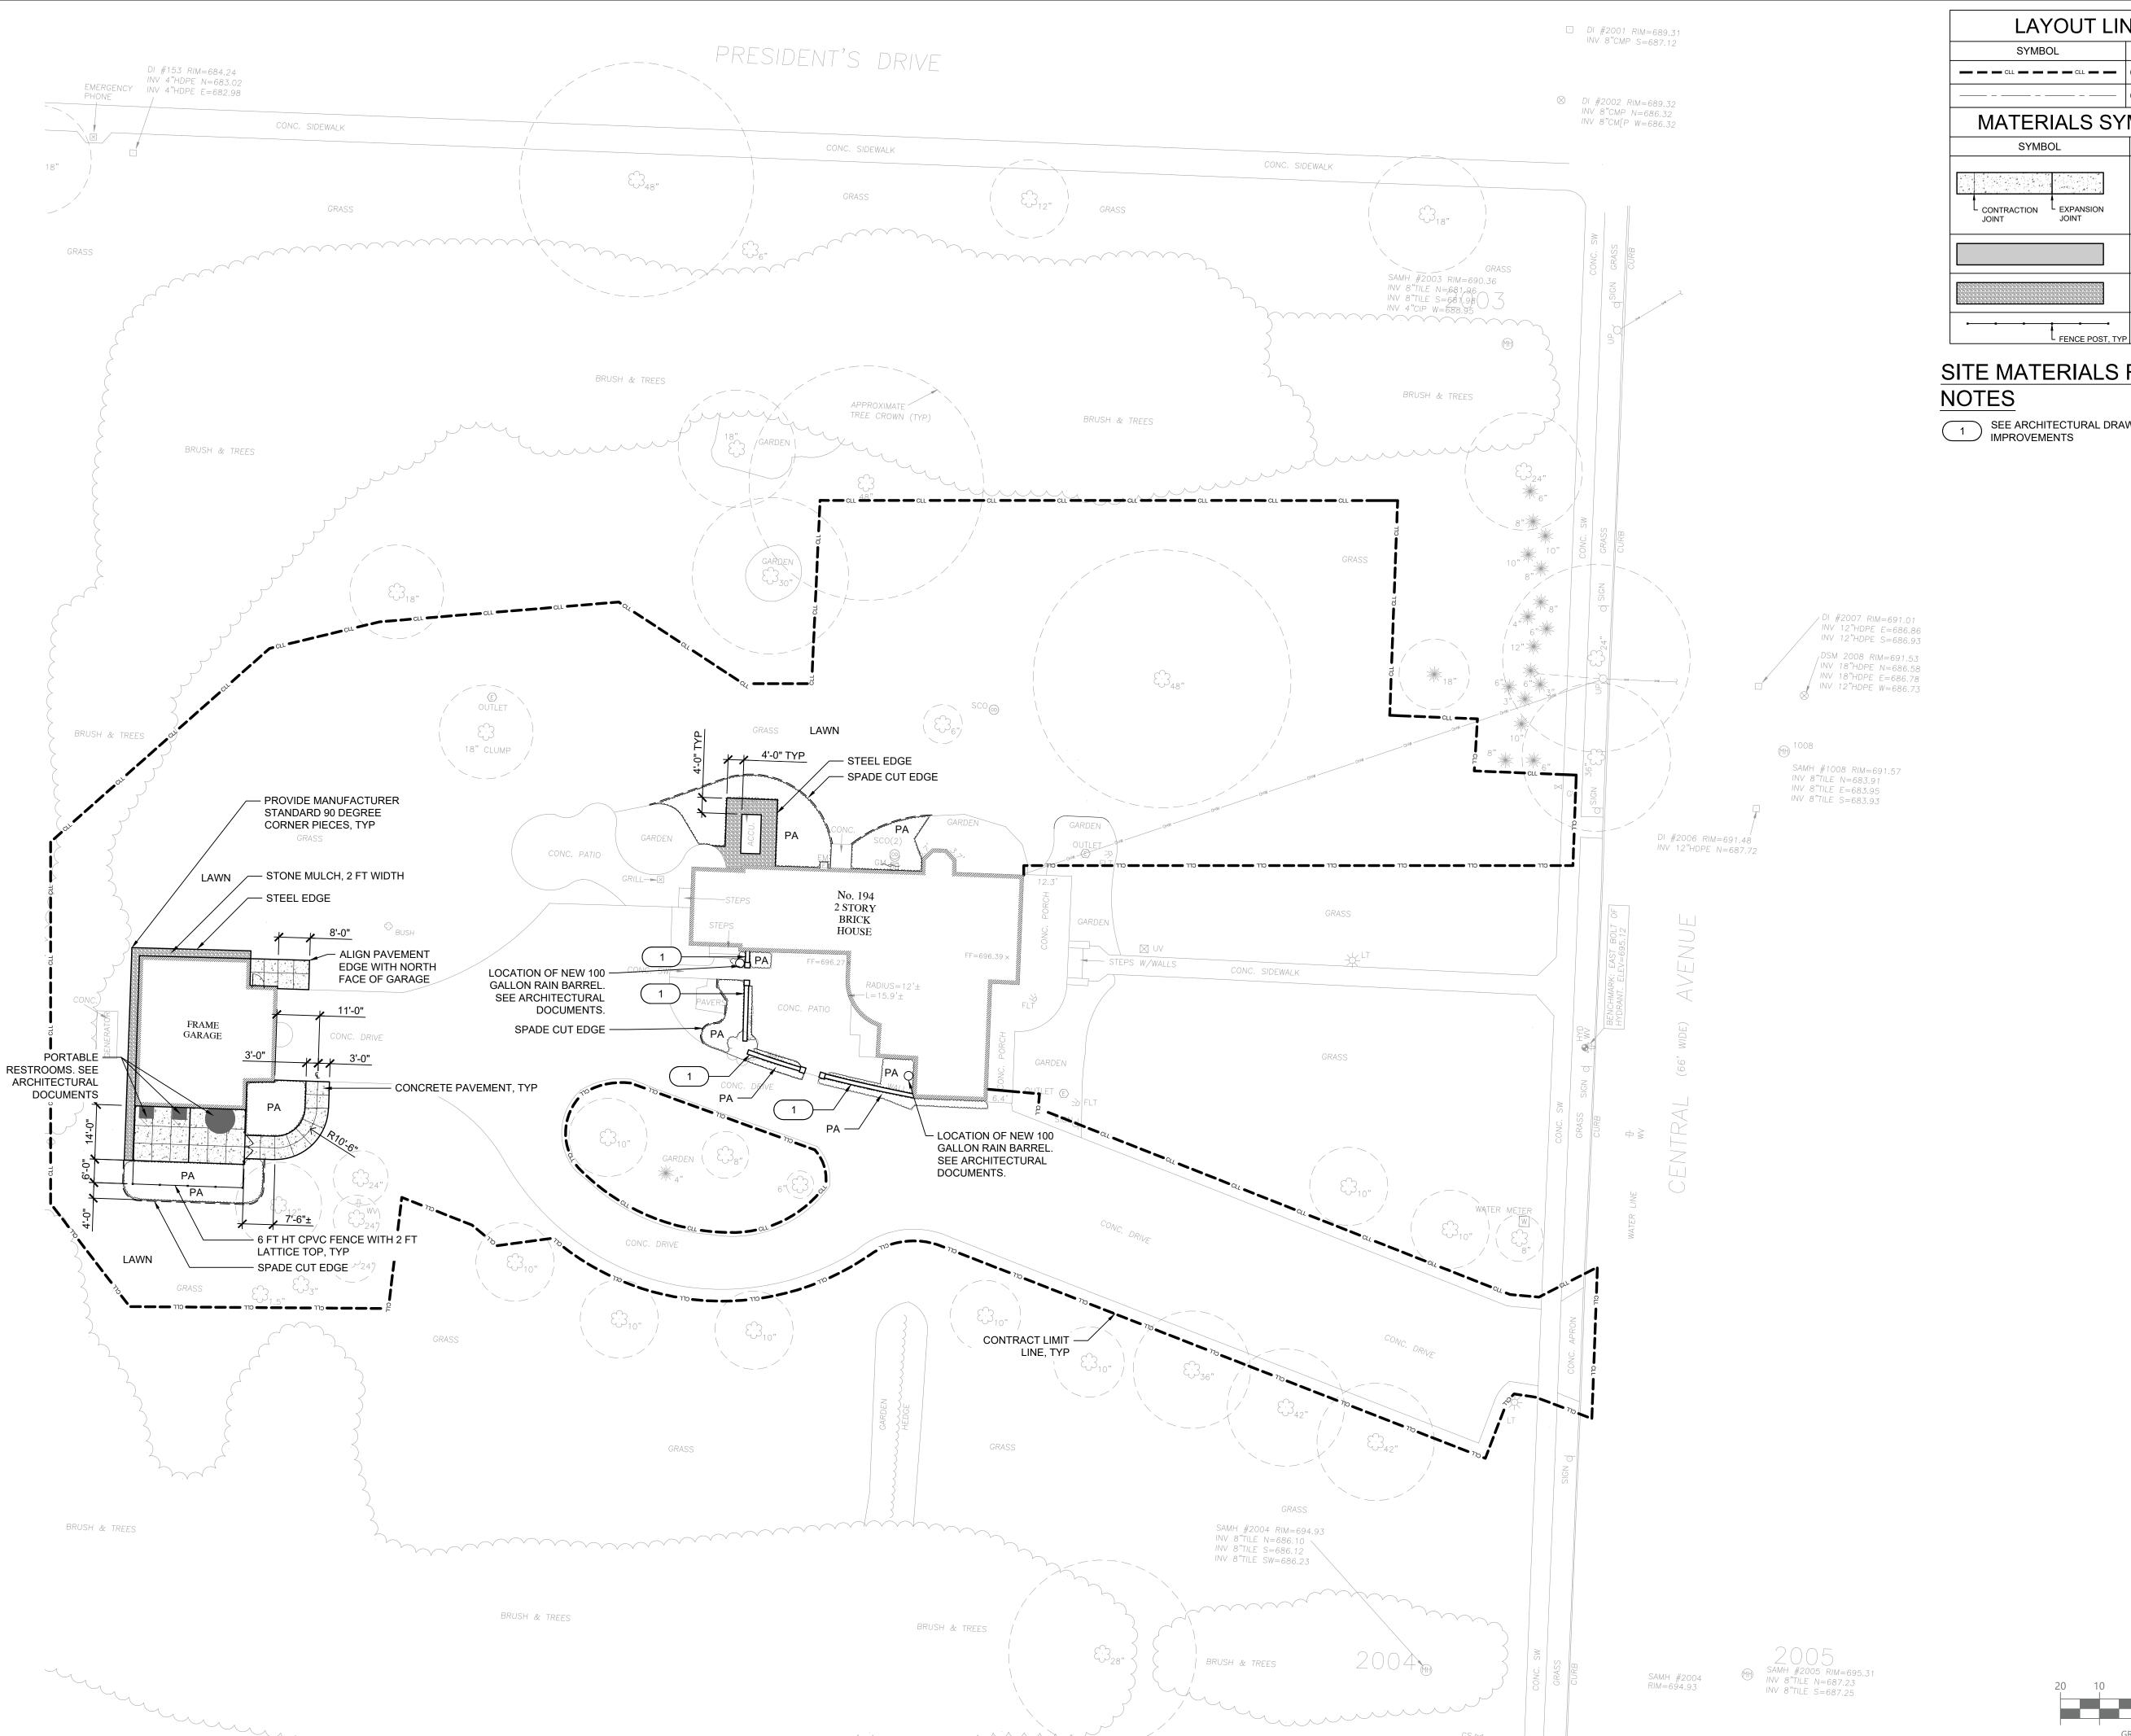
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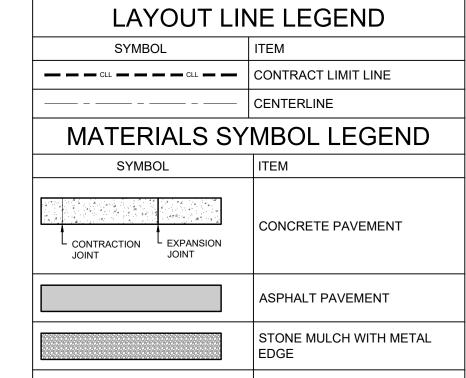
Drawing Title

DEMOLITION, SEDIMENT AND EROSION CONTROL PLAN

Drawing Number

C0-01






SITE MATERIALS REFERENCE

SEE ARCHITECTURAL DRAWINGS FOR SITE WALL IMPROVEMENTS

CPVC FENCE

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PROJECT NO. 051037 LANFORD REHAB
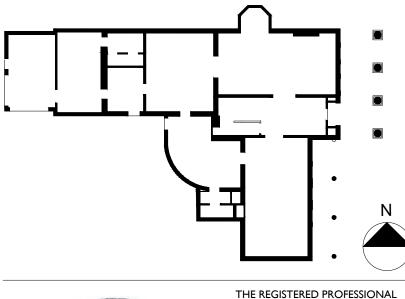
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PHASE II EXTERIOR

FREDONIA, NEW YORK 14063

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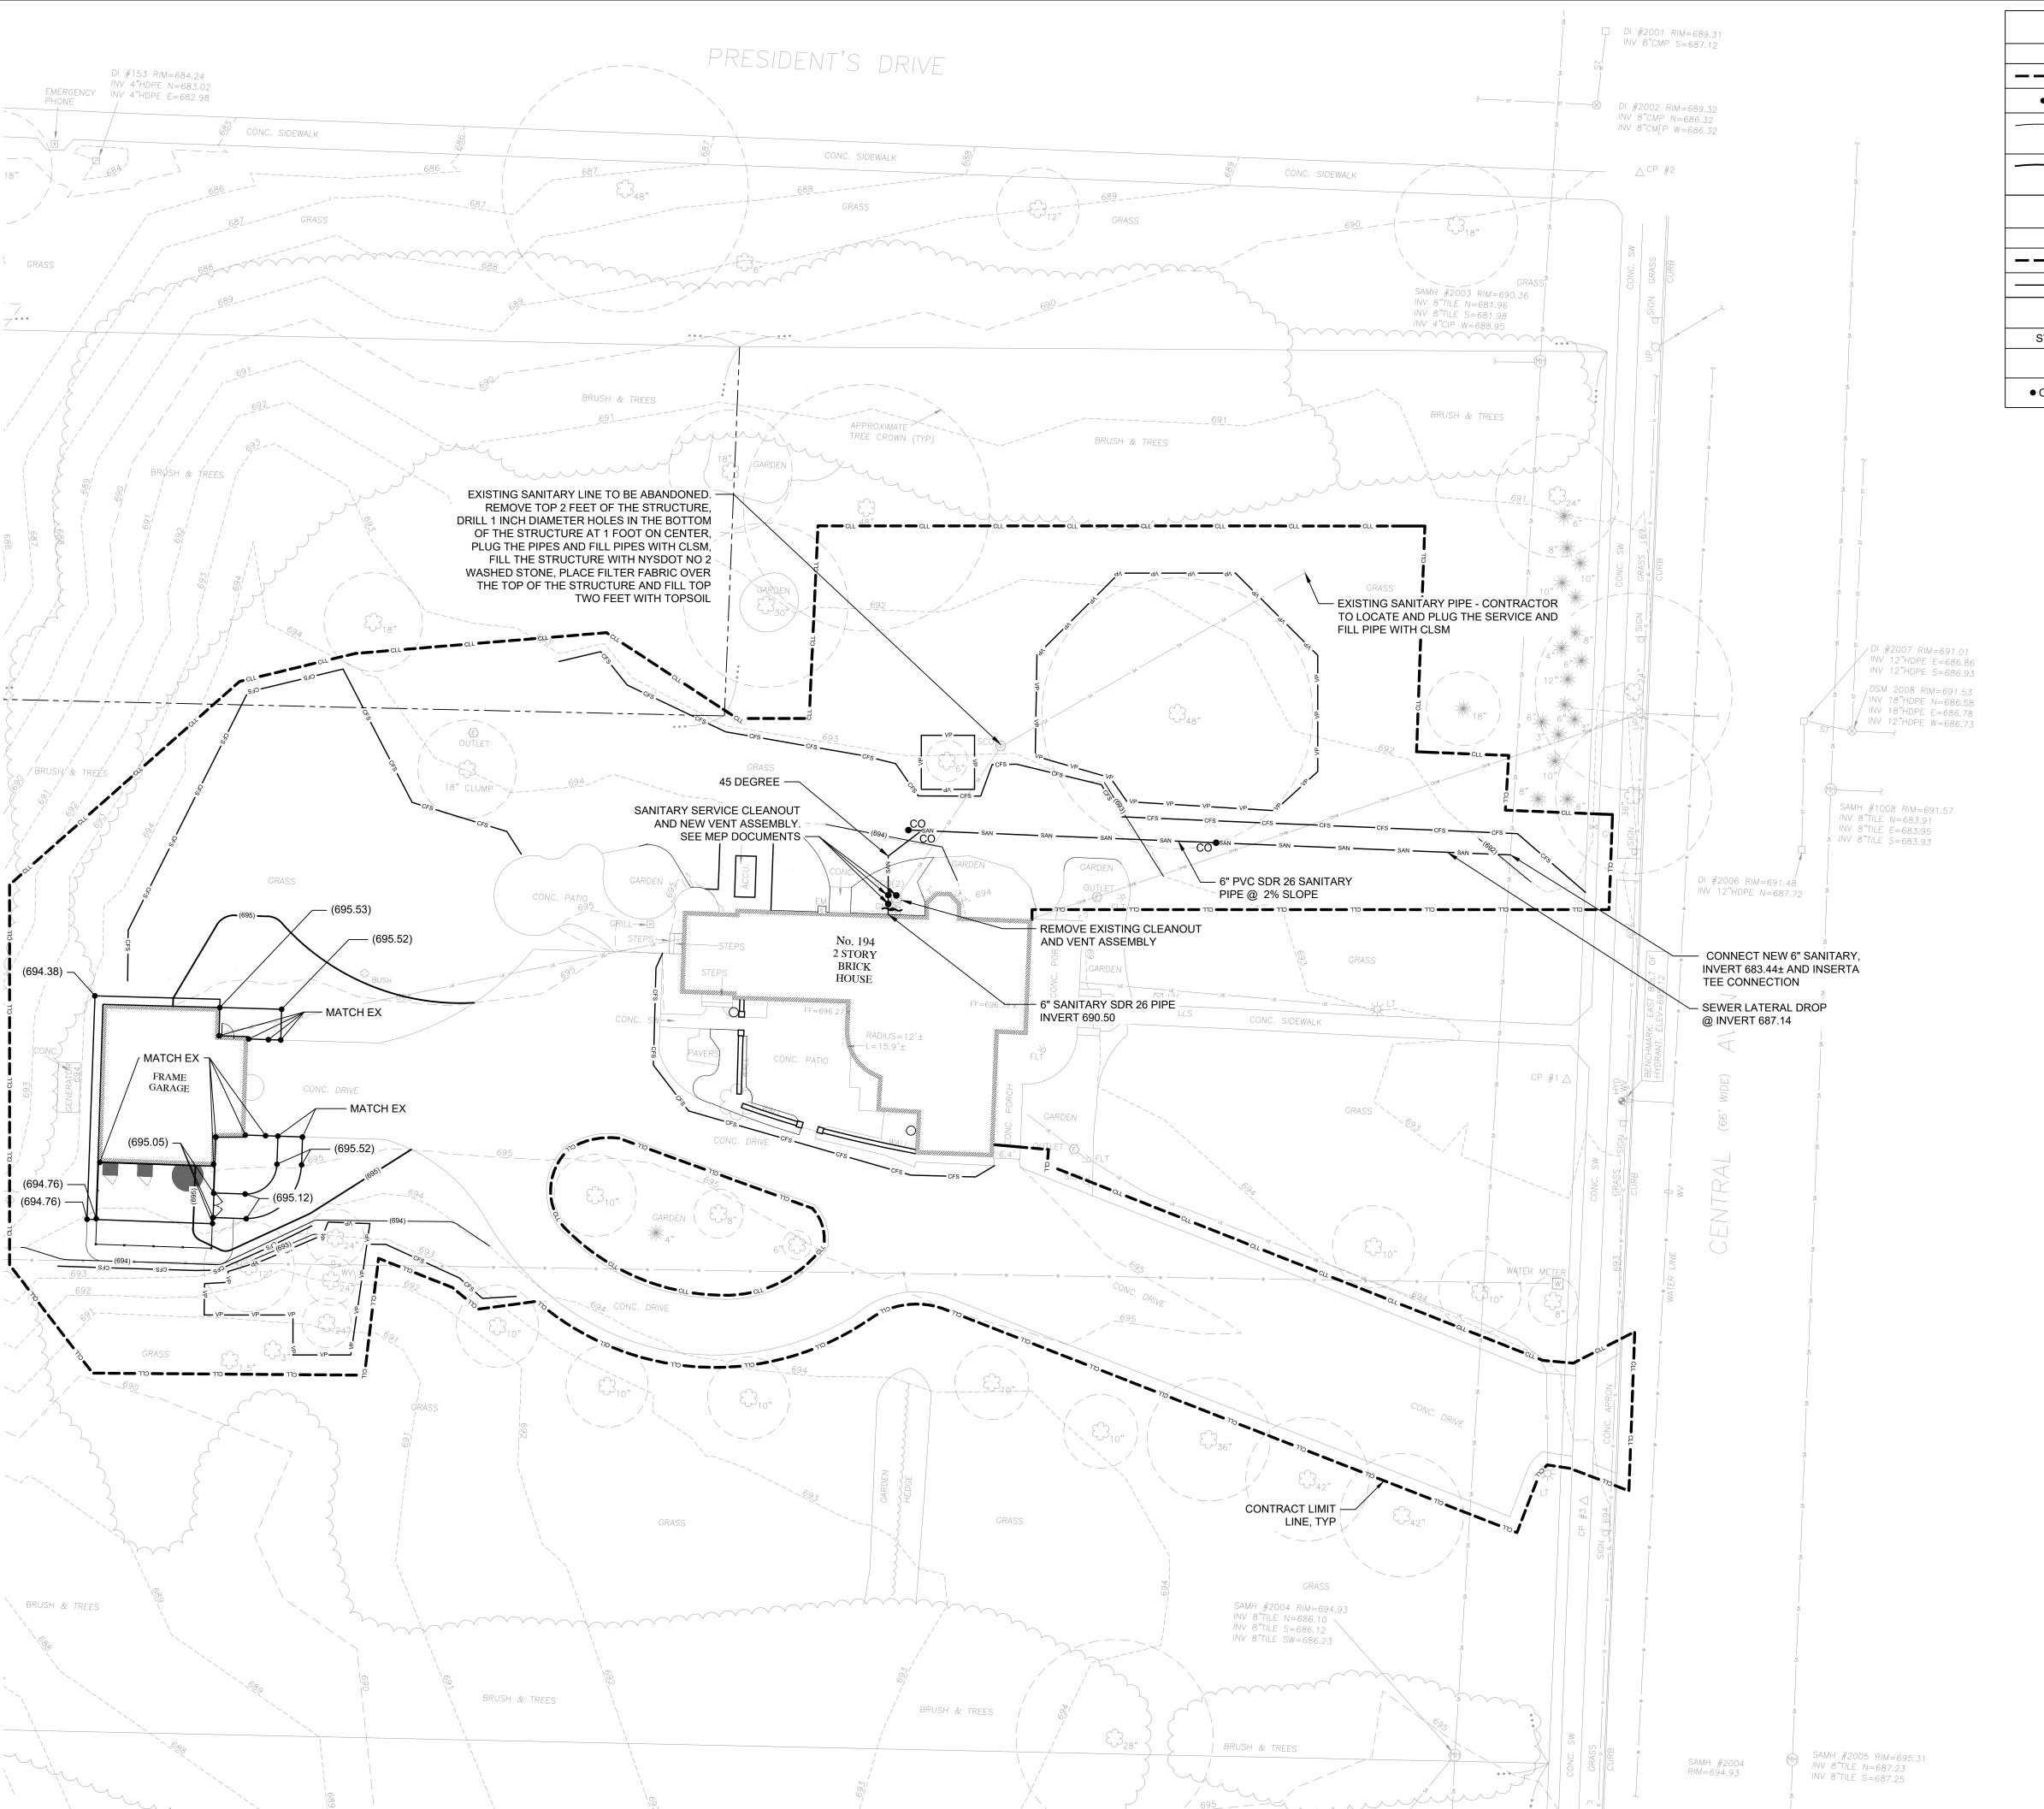
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MATERIALS AND LAYOUT PLAN


Drawing Number

GRAPHIC SCALE (IN FEET)

C1-01



	GRADING	ELEGEND		
SYM	BOL	ITEM		
CLL	CLL	CONTRACT LIMIT LINE		
•	(123.45)	SPOT ELEVATION - FINISHED		
(49	7)	CONTOUR - FINISHED		
(49	0)	CONTOUR - FINISHED - INDEX		
UT	ILITY LIN	NE LEGEND		
SYM	BOL	ITEM		
— — — CLL — —	CLL	CONTRACT LIMIT LINE		
SAN	SAN	SANITARY		
UTIL	ITY SYM	BOL LEGEND		
SYMBOL	ITEM			
\	UTILITY - LIMI	TS OF WORK AT BUILDING		
• CO	UTILITY - CLE	ANOUT		

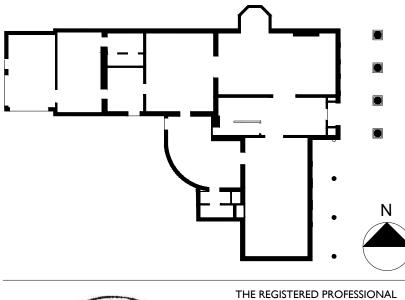

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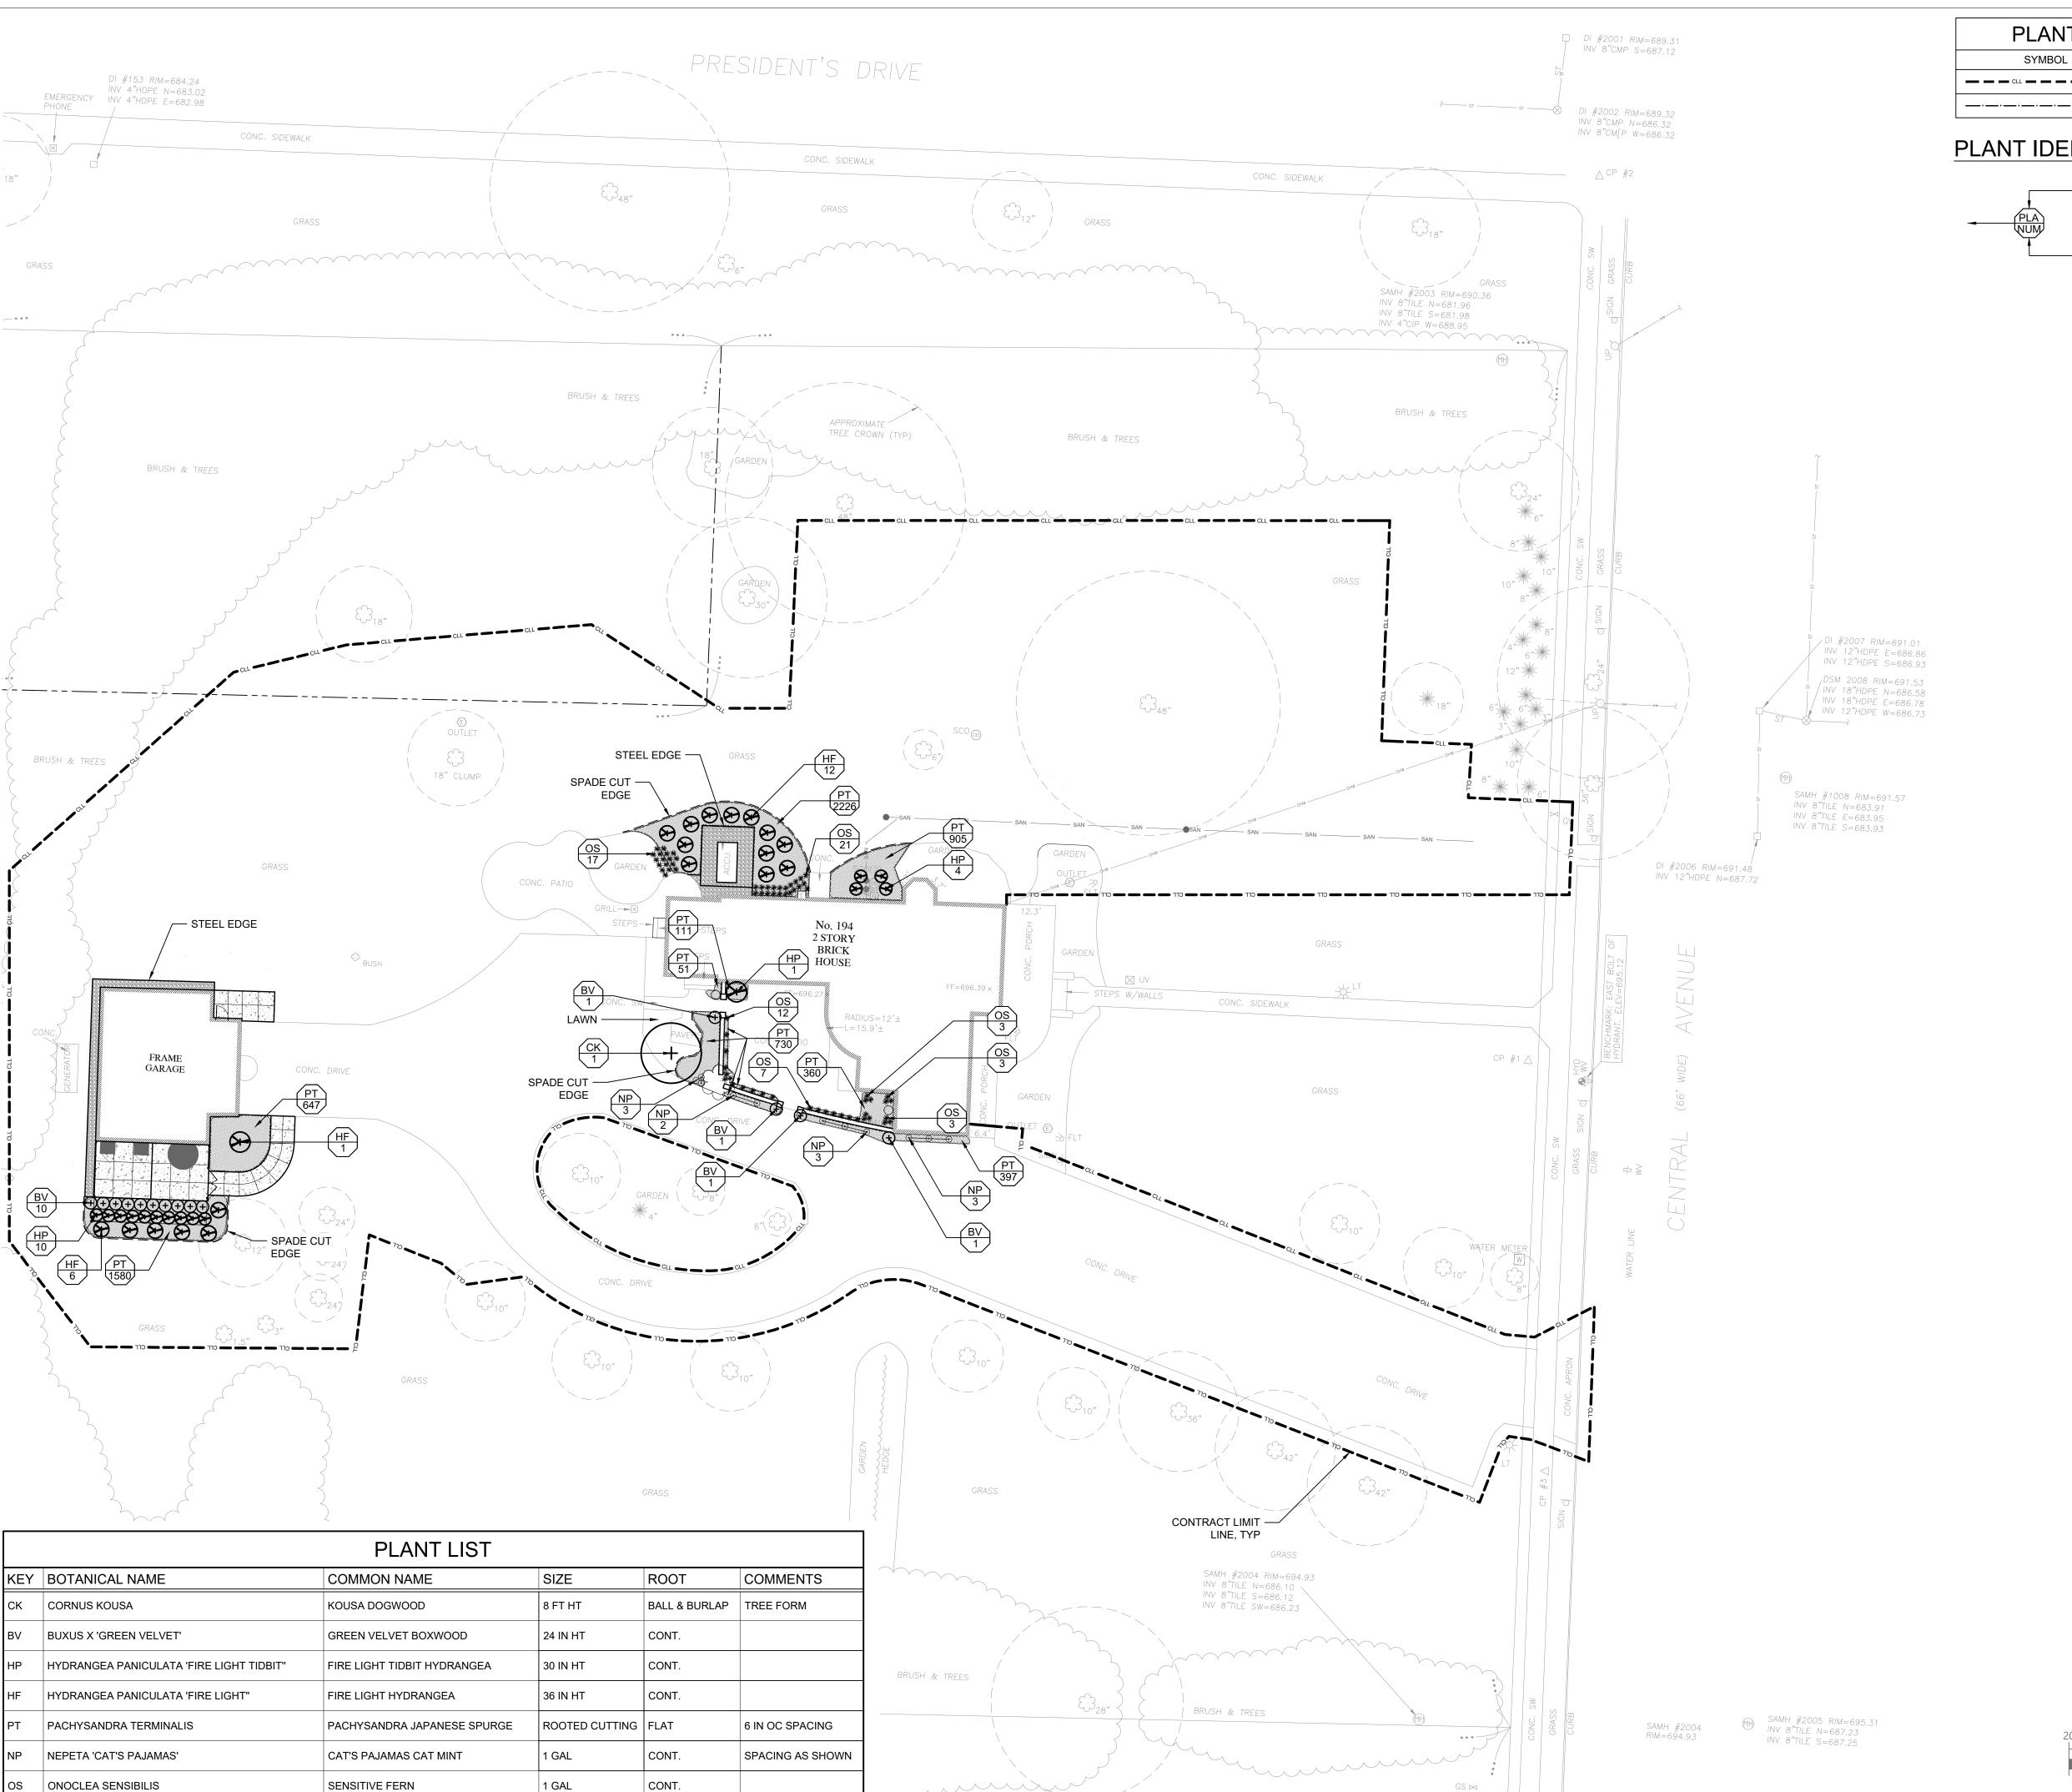
Drawing Title

GRADING, UTILITIES AND EROSION & SEDIMENT CONTROL PLAN

Drawing Number

GRAPHIC SCALE (IN FEET)

C3-01






— — — CLL — — CONTRACT LIMIT LINE —·—·—·—·— | SPADE CUT EDGE

PLANT IDENTIFICATION KEY

- PLANT ABBREVIATION - QUANTITY

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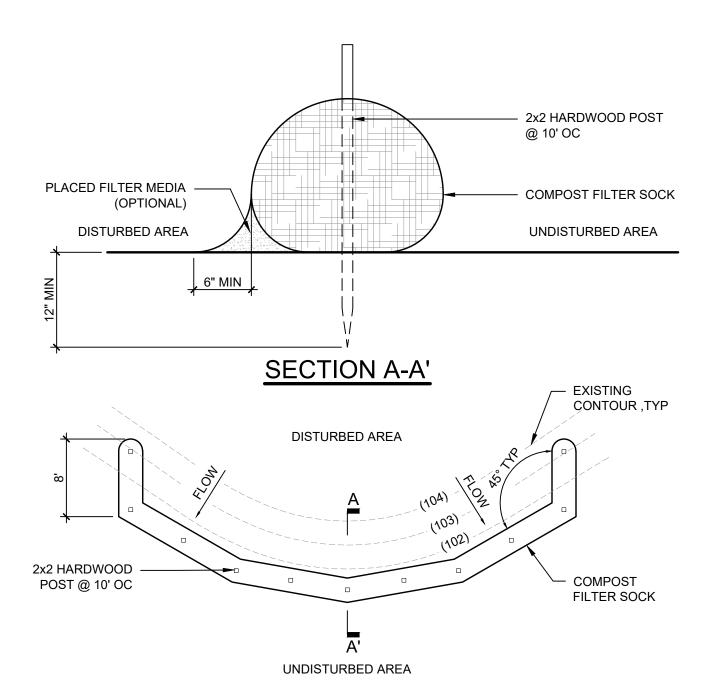
Drawing Title

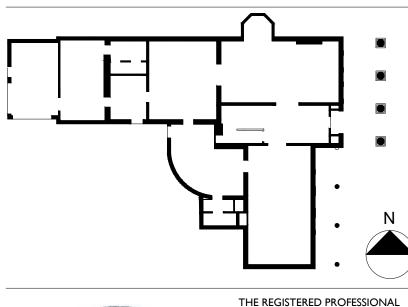PLANTING PLAN

Drawing Number

GRAPHIC SCALE (IN FEET)

C4-01



COMPOST FILTER SOCKS SHALL BE PLACED ON THE CONTOUR WITH BOTH TERMINAL ENDS OF THE SOCK EXTENDED 8 FEET UPSLOPE AT A 45° ANGLE TO PREVENT BYPASS FLOW.

PLAN

- DIAMETERS DESIGNED FOR USE SHALL BE 12"-32".
- THE FLAT DIMENSION OF THE SOCK SHALL BE AT LEAST 1.5 TIMES THE NOMINAL DIAMETER. 4. THE MAXIMUM SLOPE LENGTH (IN FEET) ABOVE A COMPOST FILTER SOCK SHALL NOT EXCEED THE FOLLOWING LIMITS:

TABLE 1	- MAXIMU	MAXIMUM SLOPE LENGTH ABOVE COMPOST FILTER SOCK (FEET)							
DIA (IN)			SLOPE %						
	2	5	10	20	25	33	50		
8	225	200	100	5	20	-	-		
12	250	225	125	65	50	40	25		
18	275	250	150	70	55	45	30		
24	350	275	200	130	100	60	35		
32	450	325	275	150	120	75	50		

TABLE 2 - COMPOST FILTER MEDIA STANDARDS						
	ORGANIC MATTER CONTENT	25% - 100% DRY WEIGHT				
	ORGANIC PORTION	FIBROUS AND ELONGATED				
	рН	6.0 - 8.0				
	MOISTURE CONTENT	30% - 60%				
	PARTICLE SIZE	100% PASSING A 1" SCREEN AND 10-50% PASSING A 3/8" SCREEN				
	SOLUBLE SALT CONCENTRATION	5.0 dS/m (mmhos/cm) MAXIMUM				


TABLE 3 - COMPOST SOCK FABRIC MINIMUM SPECIFICATIONS						
MATERIAL TYPE	3 MIL HDPE	5 MIL HDPE	5 MIL HDPE	MILTI-FILAMENT POLYPROPYLENE	HEAVY DUTY MILTI-FILAMENT POLYPROPYLENE	
MATERIAL CHARACTERISTICS	PHOTODEGR AD-ABLE	PHOTODEGR AD-ABLE	BIODEGR AD-ABLE	PHOTODEGRAD- ABLE	PHOTODEGRAD- ABLE	
SOCK DIAMETERS	12", 18"	12", 18", 24", 32"	12", 18", 24", 32"	12", 18", 24", 32"	12", 18", 24", 32"	
MESH OPENING	3/8"	3/8"	3/8"	3/8"	1/8"	
TENSILE STRENGTH		26 PSI	26 PSI	44 PSI	202 PSI	
ULTRAVIOLET STABILITY % ORIGINAL STRENGTH (ASTM G-155)	23% AT 1000 HR.	23% AT 1000 HR.		100% AT 1000 HR.	100% AT 1000 HR.	
MINIMUM FUNCTIONAL LONGEVITY	6 MONTHS	9 MONTHS	6 MONTHS	1 YEAR	2 YEARS	

- THE COMPOST INFILL SHALL BE WELL DECOMPOSED (MATURED AT LEAST 3 MONTHS), WEED-FREE, ORGANIC MATTER. IT SHALL BE AEROBICALLY COMPOSTED, POSSESS NO OBJECTIONABLE ODORS, AND CONTAIN LESS THAN 1%, BY DRY WEIGHT, OF MAN-MADE FOREIGN MATTER. THE PHYSICAL PARAMETERS OF THE COMPOST SHALL MEET THE STANDARDS LISTED IN TABLE 5.2-COMPOST FILTER MEDIA STANDARDS TABLE*. NOTE ALL BIOSOLIDS COMPOST PRODUCED IN NEW YORK STATE (OR APPROVED FOR IMPORTATION) MUST MEET NYS DEC'S 6 NYCRR PART 360 (SOLIDS WASTE MANAGEMENT FACILITIES) REQUIREMENTS. THE PART 360 REQUIREMENTS ARE EQUAL TO OR MORE STRINGENT THAN 40 CFR PART 503 WHICH ENSURE SAFE STANDARDS FOR PATHOGEN REDUCTION AND HEAVY METALS CONTENT. WHEN USING COMPOST FILTER SOCKS ADJACENT TO SURFACE WATER, THE COMPOST SHOULD HAVE A LOW NUTRIENT VALUE.
- 6. THE COMPOST FILTER SOCK FABRIC MATERIAL SHALL MEET THE MINIMUM SPECIFICATIONS GIVEN IN TABLE 5.3-COMPOST SOCK FABRIC MINIMUM SPECIFICATIONS TABLE*.
- COMPOST FILTER SOCKS SHALL BE ANCHORED IN EARTH WITH 2x2 WOODEN STAKES DRIVEN 12" INTO THE SOIL ON 10 FOOT CENTER ON THE CENTERLINE OF THE SOCK. ON UNEVEN TERRAIN, EFFECTIVE GROUND CONTACT CAN BE ENHANCED BY THE PLACEMENT OF A FILLET OR FILTER MEDIA ON THE DISTURBED AREA SIDE OF THE COMPOST SOCK.
- 8. ALL SPECIFIC CONSTRUCTION DETAILS AND MATERIAL SPECIFICATIONS SHALL APPEAR ON THE EROSION AND SEDIMENT CONTROL CONSTRUCTIONS DRAWINGS WHEN COMPOST FILTER SOCKS ARE INCLUDED IN THE PLAN.

*TABLE FROM THE 2016 NYS STANDARDS AND SPECIFICATIONS FOR EROSION AND SEDIMENT CONTROL.



TEMPORARY

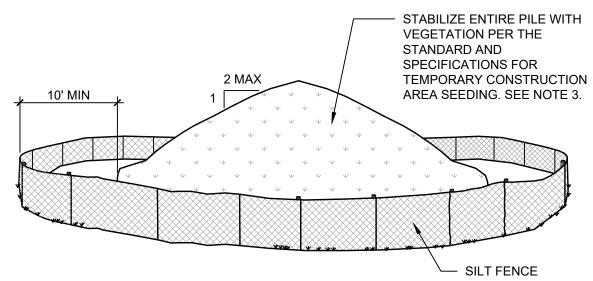

- 1. AREA CHOSEN FOR STOCKPILING OPERATIONS SHALL BE DRY, STABILIZED AND LOCATED AWAY FROM KNOWN WORK AREAS TO PREVENT RELOCATION.
- MAXIMUM STOCKPILE HEIGHT SHALL BE 12 FEET. 3. EACH PILE SHALL BE SURROUNDED WITH SILT FENCING, INSTALLED PER SILT FENCE DETAIL, THEN STABILIZED IN ACCORDANCE WITH THE NYSDEC STANDARD AND SPECIFICATIONS FOR TEMPORARY CONSTRUCTION AREA SEEDING WITHIN 7 DAYS OF
- COMPLETION. 4. A PERIMETER DIKE/SWALE SHALL BE LOCATED UP-SLOPE OF THE TOPSOIL STOCKPILE TO DIVERT STORMWATER AROUND THE STOCKPILE.

STABILIZED SOIL STOCKPLIE

LOCATE FENCING AT DRIP LINE

OR 12' MINIMUM

VEGETATION PROTECTION

8'-0" - SEE NOTES

TEMPORARY


PROTECTIVE ORANGE


METAL STAKES @ 6' OC

EXISTING GRADE


CONSTRUCTION FENCING

- NYSDOT ITEM 607-41010010

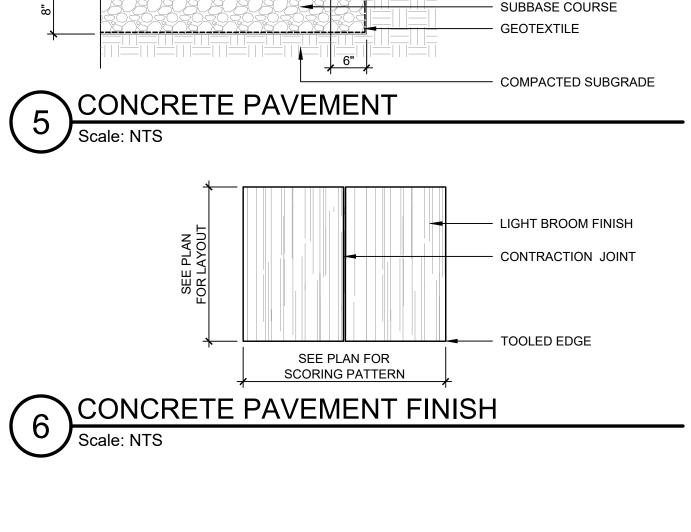

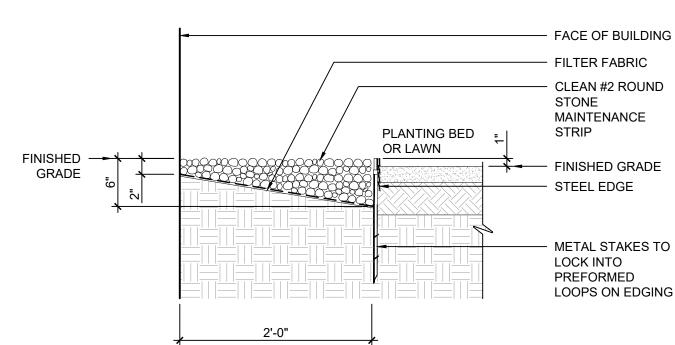




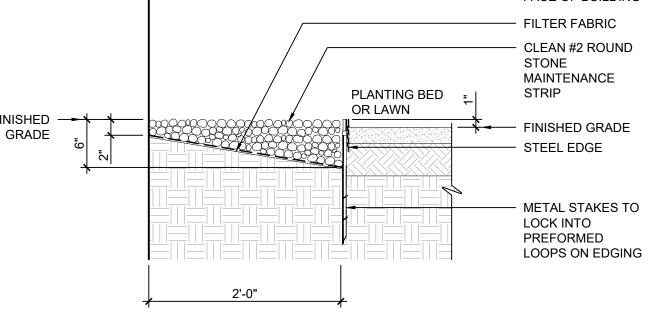


- #4 REBAR @12" OCEW.

CONCRETE PAVING


YYYYYYYYY FINISHED GRADE

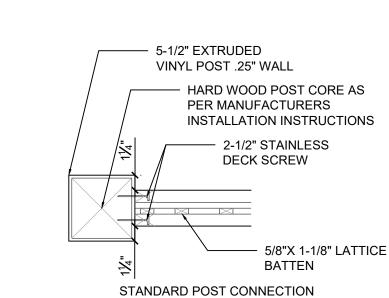


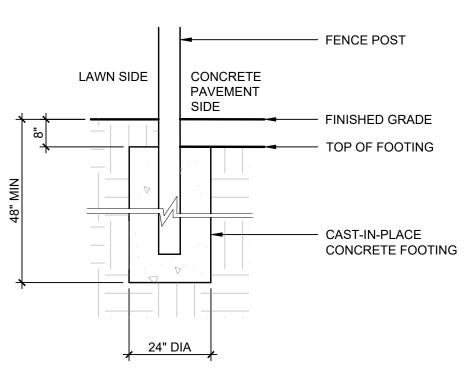

STANDARD FENCE FOOTING


STRAIGHT TOP

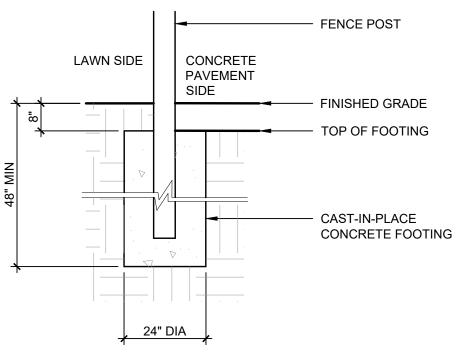

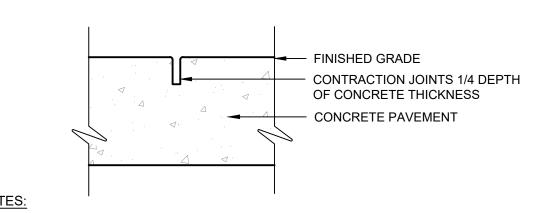


TOOLED CONTRACTION JOINTS. 2. CONTRACTION JOINTS SHALL BE EVERY 5 FFET OC..

CONTRACTION JOINT

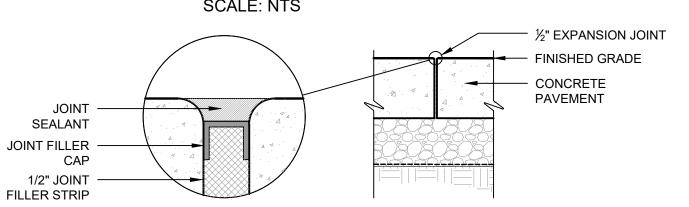

EXPANSION JOINT

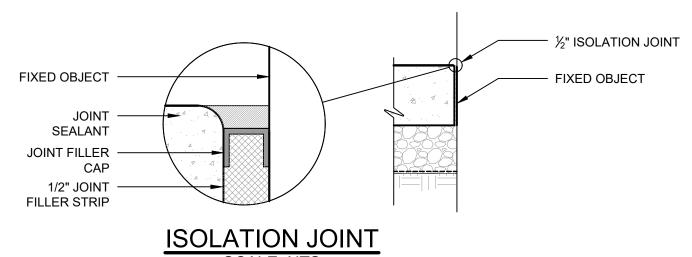

1. FORM ISOLATION JOINTS OF PRE-FORMED JOINT-FILLER STRIPS ABUTTING CONCRETE CURBS, CATCH BASINS, MANHOLES, INLETS, STRUCTURES, OTHER FIXED OBJECTS, AND WHERE INDICATED.

CONCRETE - PAVEMENT JOINTS

PROJECT NO. 051037 LANFORD REHAB PHASE II EXTERIOR

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THE NOTATION "ALTERED BY" FOLLOWED BY HIS/HER SIGNATURE AND THE

THE REGISTERED PROFESSIONAL

CERTIFIES THAT THIS PROJECT HAS

BEEN DESIGNED BY ME, OR UNDER

MY SUPERVISION, IN ACCORDANCE WITH: THE BUILDING CODE OF

ENERGY CONSERVATION CODE OF

NEW YORK STATE AND APPLICABLE

FEDERAL LAWS AND REGULATIONS

KNOWLEDGE AND BELIEF, THESE CONSTRUCTION DOCUMENTS ARE

IN CONFORMANCE THEREWITH.

NEW YORK STATE AND THE

AND TO THE BEST OF MY

194 CENTRAL AVENUE FREDONIA, NEW YORK 14063

100% CONSTRUCTION DOCUMENT SET

	Revision Scl	riedule
Revision Number	Date	Description

DRAWING ISSUED:	10/01/2024
Project Number:	Scale:
FBA PROJECT #00388.00	AS SHOWN
Drawn By:	Checked By:
AML, JRS	MOM,DGP, JCG

Drawing Title **DETAILS**

Drawing Number


C6-0'

6 FT HT CPVC FENCE WITH 2 FT LATTICE TOP

3. POST SPACING SHALL BE DETERMINED BY PRODUCT REQUIREMENTS AND APPROVED BY OWNER'S REPRESENTATIVE IN SHOP DRAWING SUBMITTAL


1. WALPOLE OUTDOOR 6' HT UNIVERSAL BOARD FENCE WITH A 2' HT 2.5" HV TOPPER

2. INSTALL FENCE AS PER MANUFACTURER INSTALLATION INSTRUCTIONS

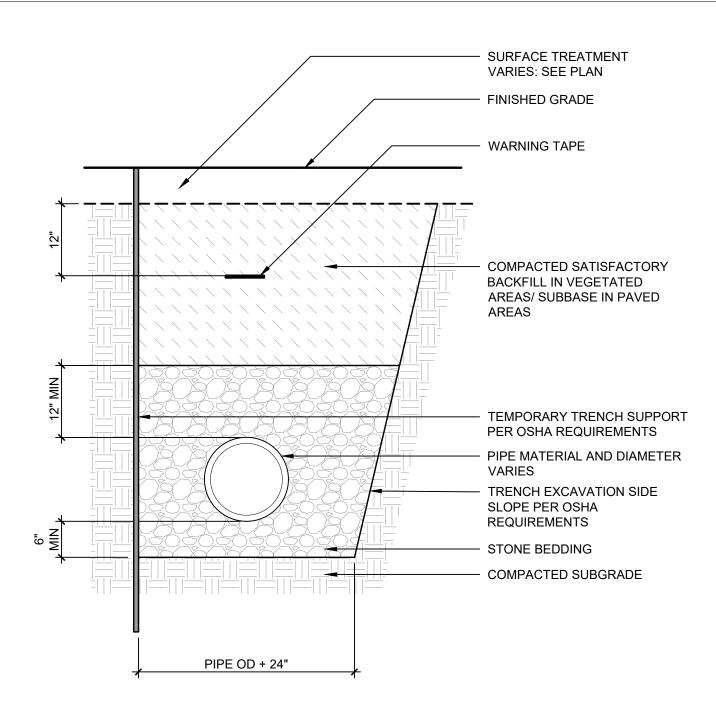


IPE TRENCH

WITH STONE BEDDING

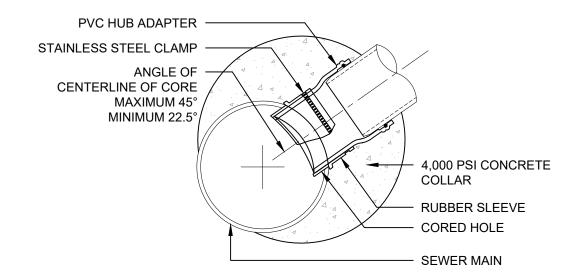

CORED TEE CONNECTION

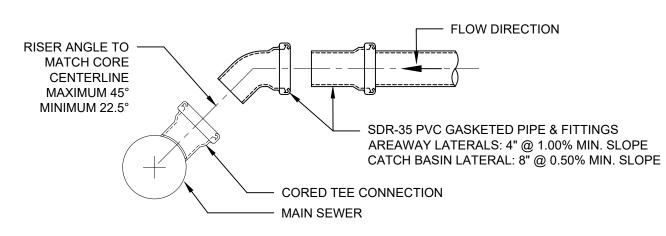


SECTION VIEW

1. LATERAL CONNECTION MUST BE CORED. PNEUMATIC DEVICES OR HAMMERING KNOCK-OUT METHODS ARE NOT ACCEPTABLE FOR CREATING OPENING FOR NEW LATERAL PIPE.


- 2. SIZE OF CORED OPENING SHALL BE LIMITED TO ONE-HALF THE NOMINAL DIAMETER OF THE 3. CORE HOLE A MINIMUM OF 6" AWAY FROM EXISTING PIPE HUBS.
- 4. TAKE NECESSARY PRECAUTIONS TO PREVENT DAMAGE TO THE MAIN SEWER, AND TO PREVENT DEBRIS FROM ENTERING THE SEWER.


SANITARY SEWER LATERAL

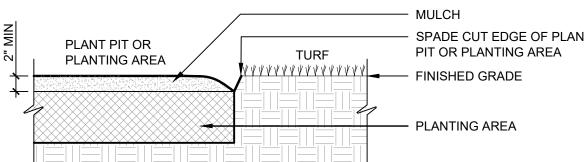

SPADE CUT EDGE


SPADE CUT EDGE OF PLANT

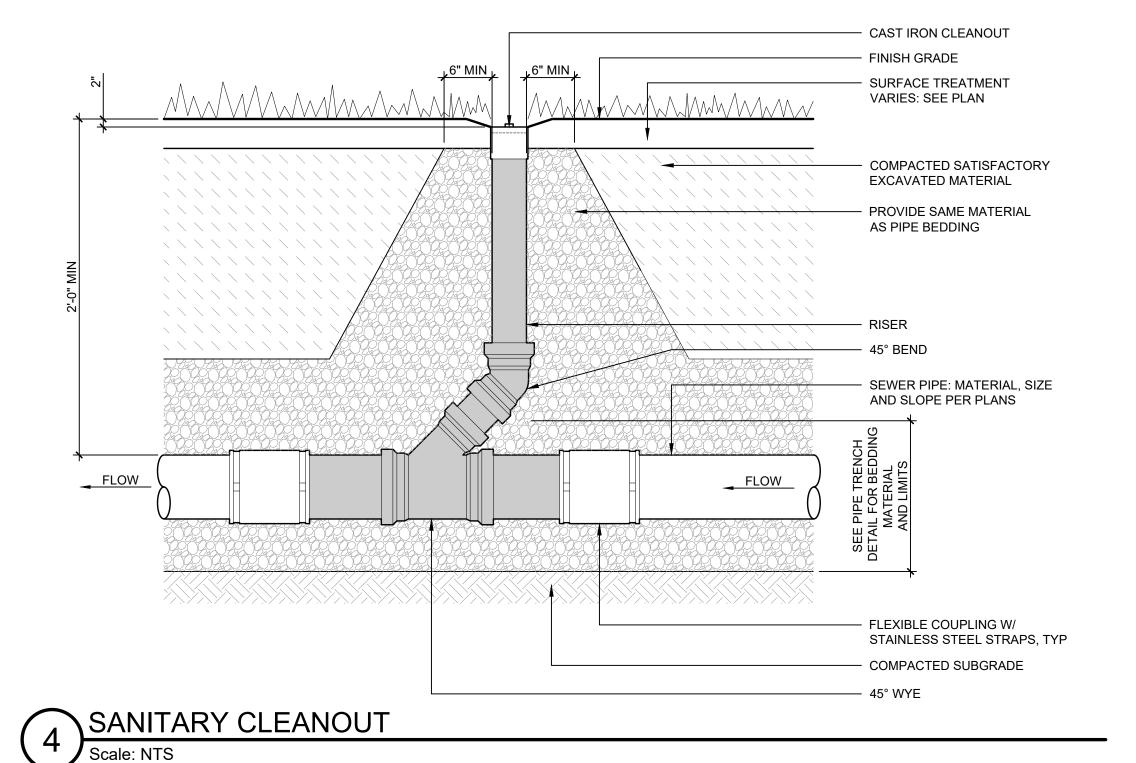

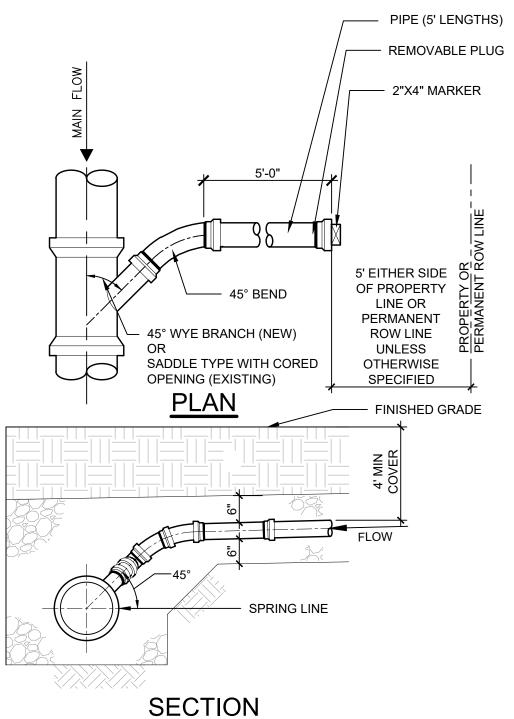

1. 2X4 MARKER TO EXTEND FROM INVERT TO 24" ABOVE FINISHED GRADE 2. ONLY ONE CONNECTION ALLOWED PER JOINT OF PIPE

SANITARY SEWER CONNECTION

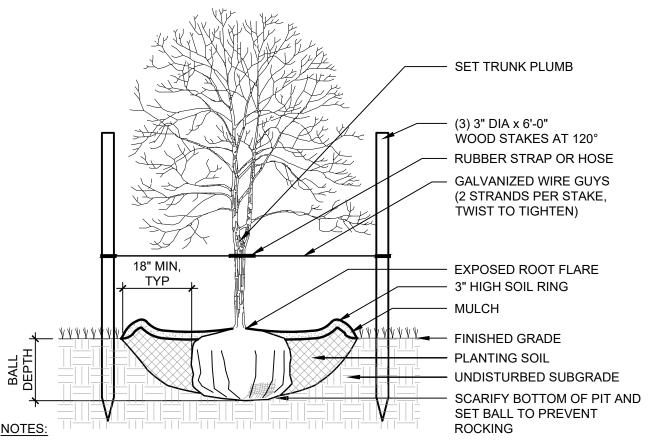


1. REMOVE BURLAP, ROPE, OR WIRE BASKET FROM TOP 1/3 OF BALL MINIMUM, CUT REMAINING PORTIONS OF ROPE OR WIRE BASKET ONCE PLANT IS IN THE FINAL POSITION IN PIT. 2. TOP OF ROOT BALL SHALL BE SET FLUSH WITH SURROUNDING FINISHED GRADE.

DECIDUOUS TREE

WITH UPRIGHT STAKES

WITH CONTINUOUS PLANT BED

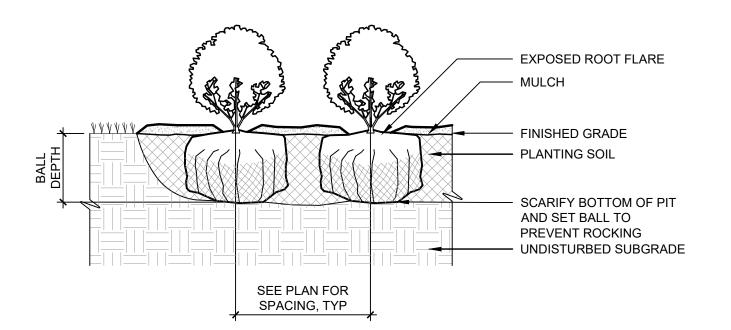

1. TOP OF ROOT BALL SHALL BE SET FLUSH WITH SURROUNDING FINISHED GRADE. 2. SET PLANTS PLUMB

SHRUB MASSING


SEE PLAN FOR SPACING - TOP OF PLANTING MEDIUM 3" HIGH SOIL RING AROUND PERIMETER OF PLANTING SPADE CUT EDGE FINISHED GRADE · PLANTING SOIL UNDISTURBED SUBGRADE

NOTES:

- 1. REMOVE GROWING CONTAINER
- 2. LOOSEN POT BOUND ROOTS 3. TOP OF PLANTING MEDIUM SHALL BE SET FLUSH WITH SURROUNDING FINISHED GRADE.
- 4. SET PLANTS PLUMB

PERENNIAL & GROUND COVER


MASSING - WITH CONTIUOUS PLANT BED

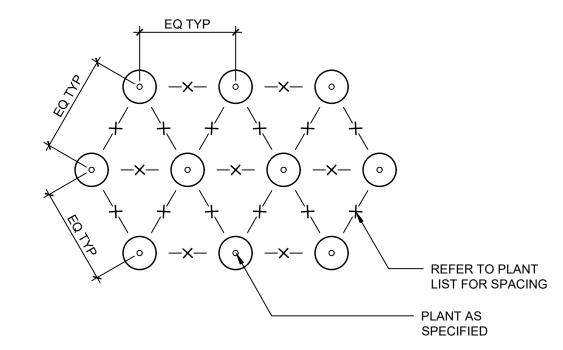

\PLANT LAYOUT

PERENNIAL & GROUND COVER

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PROJECT NO. 051037 LANFORD REHAB PHASE II EXTERIOR

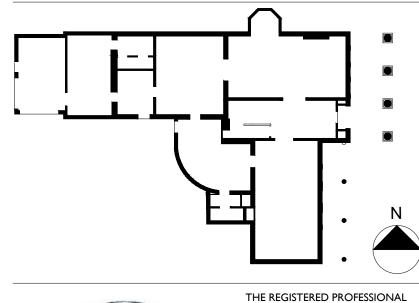194 CENTRAL AVENUE FREDONIA, NEW YORK 14063

100% CONSTRUCTION DOCUMENT SET

Revision Schedule Revision Number Description

DRAWING ISSUED: 10/01/2024 Project Number: Scale: AS SHOWN FBA PROJECT #00388.00 Drawn By: Checked By: MOM,DGP, JCG AML, JRS

Drawing Title

DETAILS

Drawing Number

C6-02

GENERAL NOTES

- THE WORK SHOWN ON THESE DRAWINGS HAS BEEN DESIGNED IN ACCORDANCE WITH THE STRUCTURAL REQUIREMENTS OF THE BUILDING CODE OF NEW YORK STATE (2020 EDITION).
- 2 THE STRUCTURAL COMPONENTS HAVE BEEN DESIGNED FOR THE LOADS INDICATED IN THE STRUCTURAL DESIGN CRITERIA.
- 3 CONTRACTOR SHALL FIELD MEASURE AND VERIFY ALL EXISTING CONDITIONS AND DIMENSIONS PRIOR TO THE START OF CONSTRUCTION AND THE FABRICATION OF ANY MATERIALS. NOTIFY ENGINEER OF ANY EXISTING CONDITION DISCREPANCIES.
- 4 THE CONTRACTOR IS RESPONSIBLE FOR DESIGNING, PROVIDING AND INSTALLING ALL TEMPRORY SHORING THAT IS REQUIRED DURING CONSTRUCTION.
- IF FAULTY CONSTRUCTION PROCEDURES OR MATERIAL RESULT IN DEFECTIVE WORK THAT REQUIRES ADDITIONAL ENGINEERING TIME TO DEVISE CORRECTIVE MEASURES, PROFESSIONAL FEES MAY BE CHARGED TO THE CONTRACTOR AT TEH STANDARD HOURLY RATE OF ADDITIONAL SERVICES. SUCH FEES MY BE WITHHELD FROM THE GENERAL CONTRACTOR'S PAYMENT.
- ONE BLACKLINE PRINT OF ALL ERECTION AND DETAIL SHOP DRAWINGS INDICATING THE FABRICATOR, MANUFACTURER, FINISH, LAYOUT AND ALL ACCESSORIES MUST BE SUBMITTED TO AND BE CHECKED BY THE CONTRACTOR AND SUBCONTRACTOR AND BEAR THE CHECKER'S INITIALS BEFORE SUBMISSION TO THE ARCHITECT FOR REVIEW PRIOR TO FABRICATION.
- 7 THESE DRAWINGS ARE SUPPLEMENTED BY A DETAILED TECHNICAL SPECIFICATION. THE NOTES SHOWN UNDER CERTAIN CATEGORIES OF WORK ARE INTENDED TO SUMMARIZE BASIC REQUIREMENTS
- 8 WORK SHOWN AS "TYPICAL DETAILS" APPLY THROUGHOUT THE PROJECT AS REQUIRED. WORK SHOWN AS "SECTIONS" SHALL BE CONSIDERED TO APPLY FOR THE SAME AND SIMILAR CONDITIONS IN THE BUILDING.
- 9 SOME DETAILS OF THE WORK ARE SHOWN ON THE ARCHITECTURAL DRAWINGS. CAREFUL REVIEW AND STUDY OF THE DETAILS ARE NECESSARY BEFORE THE FULL SCOPE OF THE WORK CAN BE COMPREHENDED.
- 10 DO NOT SCALE THE DRAWINGS.

FOUNDATION NOTES

- 1 REFER TO DIVISION 31 OF THE PROJECT SPECIFICATIONS FOR ADDITIONAL REQUIREMENTS OF EARTHWORK MATERIAL AND BACKFILLING.
- 2 ALL FOUNDATIONS SHALL BEAR ON INORGANIC, UNDISTURBED SOILS. ACCEPTABLE BEARING STRATA IS ANTICIPATED AT THE BOTTOM OF FOOTING ELEVATIONS NOTED ON PLAN AND SHALL BE INSPECTED BY THE GEOTECHNICAL ENGINEER PRIOR TO PLACING CONCRETE.
- 3 DO NOT PLACE CONCRETE ON FROZEN GROUND OR IN EXCAVATIONS CONTAINING FREE STANDING WATER. CONTRACTOR SHALL BE RESPONSIBLE FOR PROTECTING ALL BEARING GRADES AND SURROUNDING SOILS PRIOR TO AND AFTER FOUNDATIONS HAVE BEEN POURED.
- 4 LOCATE EXISTING UNDERGROUND UTILITIES IN AREAS OF EXCAVATION WORK, PROVIDE ADEQUATE MEANS OF SUPPORT AND PROTECTION DURING EARTHWORK OPERATIONS.
- 5 WHERE FOOTINGS ARE IN CLOSE PROXIMITY OF SUB-SURFACE PIPING, BOTTOM OF FOOTINGS SHALL BE AT LEAST 8-INCHES BELOW ELEVATION OF PIPING UNLESS OTHERWISE SHOWN ON THE CONTRACT DRAWINGS.
- 6 COMPLY WITH ALL OSHA STANDARDS AND REGULATIONS WHEN EXCAVATING FOR FOUNDATIONS.

CONCRETE NOTES

- 1 REFER TO DIVISION 03 OF THE PROJECT SPECIFICATIONS FOR ADDITONAL CONCRETE
- 2 REFER TO THE PROJECT "STATEMENT OF SPECIAL INSPECTIONS" FOR REQUIRED CONCRETE TESTING AND INSPECTIONS.
- 3 ALL CONCRETE WORK SHALL CONFORM TO THE REQUIREMENTS OF THE LATEST EDITION OF ACI 301 "SPECIFICATIONS FOR STRUCTURAL CONCRETE BUILDINGS".
- 4 ALL DETAILING, FABRICATION AND ERECTION OF REINFORCING BARS, UNLESS NOTED OTHERWISE, MUST FOLLOW THE LATEST EDITION OF THE ACI CODE AND ACI "MANUAL OF STANDARD PRATICE FOR DETAILING REINFORCED CONCRETE STRUCTURES.
- 5 "WET STICKING" DOWELS AND REINFORGING INTO CONCRETE IS NOT PERMITTED. ALL DOWELS, REINFORGING AND WELDED WIRE FABRIC MUST BE SUPPORTED AND TIED IN ITS PROPER LOCATION PRIOR TO POURING CONCRETE.
- 6 REFER TO CHAPTER 20 OF THE LATEST EDITION OF ACI 318 FOR MINIMUM CONCRETE COVER
- 8 DO NOT USE CALCIUM CHLORIDE IN ANY CONCRETE.
- 9 REFER TO AND COORDINATE WITH ARCHITECTURAL AND MEP DRAWINGS FOR ALL ITEMS REQUIRED BY OTHER TRADES TO BE PLACED INTO CONCRETE PRIOR TO POURING.
- 10 REFER TO AND COORDINATE WITH ARCHITECTURAL AND MEP DRAWINGS FOR ALL SLAB DEPRESSIONS, WALL AND SLAB OPENINGS AND FLOOR FINISHES PRIOR TO POURING CONCRETE.

STRUCTURAL STEEL NOTES

- 1 REFER TO DIVISION 05 OF THE PROJECT SPECIFICATIONS FOR ADDTIONAL STRUCTURAL STEEL REQUIREMENTS.
- 2 REFER TO THE PROJECT "STATEMENT OF SPECIAL INSPECTIONS" FOR REQUIRED STRUCTURAL STEEL TESTING AND INSPECTIONS.
- 3 DESIGN, FABRICATION AND ERECTION OF STRUCTURAL STEEL SHALL CONFORM TO THE LATEST EDITION OF THE AISC 360 "SPECIFICATION FOR STRUCTURAL STEEL BUILDINGS".
- 4 ALL MELDING SHALL CONFORM TO THE AMERICAN MELDING SOCIETY'S AMS D1.1 "STRUCTURAL MELDING CODE-STEEL" FOR ARC AND GAS WELDING. MELDS SHALL BE PERFORMED BY A CERTIFIED WELDER IN ACCORDANCE WITH AMS STANDARDS.
- 5 REFER TO ARCHITECTURAL DRAWINGS FOR STRUCTURAL STEEL FIRE RATINGS AND PROTECTION. COORDINATE STRUCTURAL STEEL SURFACE PREPARATION AND PRIMER WITH FIRE RATING REQUIREMENTS.
- 6 DO NOT FIELD ALTER OR FIELD CUT OPENINGS IN STRUCTUAL STEEL MITHOUT WRITTEN APPROVAL FROM ENGINEER. ALL OPENINGS IN STRUCTURAL STEEL MUST BE INDICATED ON STEEL SHOP DRAWINGS PRIOR TO FABRICATION.
- 7 PACK COLUMN AND BEAM BASE PLATES WITH NON-SHRINK GROUT AFTER BUILDING HAS BEEN ERECTED AND PLUMBED TO WITHIN AISC TOLERENCES AND BEFORE POURING OF ANY
- 8 COMPLY WITH ALL OSHA STANDARDS AND REGULATIONS WHEN ERECTING STRUCTURAL STEEL.

WOOD NOTES

- REFER TO DIVISION 06 OF THE PROJECT SPECIFICATION FOR ADDITIONAL WOOD
- STORAGE OF ALL LUMBER AND TIMBER ON SITE SHALL BE KEPT OFF GROUND, UNDER COVER AND PROTECTED FROM DAMAGE.
- 3 ALL WOOD FRAMING DETAILS NOT SHOWN OTHERWISE SHALL BE CONSTRUCTED TO THE MINIMUM STANDARDS OF THE INTERNATIONAL BUILDING CODE.
- 4 MINIMUM NAILING SHALL CONFORM TO TABLE 2304.10.1 IN THE INTERNATIONAL BUILDING
- 5 ALL NAILS FOR STRUCTURAL WORK SHALL BE COMMON WIRE NAILS. HOLES SHALL BE PRE-DRILLED WHERE NECESSARY TO PREVENT SPLITTING.
- FLUSH FRAMED CONNECTIONS SHALL BE MADE WITH PREFABRICATED GALVANIZED STEEL HANGERS MADE BY SIMPSON STRONG-TIE, CO. INC. OR APPROVED EQUIVALENT OF WIDTH AND DEPTH APPROPRIATE FOR THE SUPPORTED MEMBERS. INSTALL WITH THE TYPE AND QUANTITY OF FASTENERS RECOMM

SPECIAL INSPECTION NOTES

- 1 REFER TO DIVISION O1 OF THE PROJECT SPECIFICATIONS FOR THE SCHEDULE OF SPECIAL INSPECTIONS AND ADDITIONAL SPECIAL INSPECTIONS REQUIREMENTS.
- 2 MATERIAL SPECIFICATION SECTIONS, THE SCHEDULE OF SPECIAL INSPECTIONS AND ALL ASSOCIATED NOTES DESCRIBE THE STRUCTURAL TESTING AND INSPECTIONS REQUIRED FOR THE PROJECT. COLLECTIVELY THEY SHALL BE CONSIDERED THE STATEMENT OF SPECIAL TNSPECTIONS
- THE OWNER SHALL ENGAGE THE SERVICES OF A QUALIFIED SPECIAL INSPECTOR FOR THIS PROJECT. SIRACUSE ENGINEERS, PC IS NOT THE SPECIAL INSPECTOR FOR THIS PROJECT UNLESS ENGAGED BY THE OWNER UNDER A SEPARATE CONTRACT.
- THE CONTRACTOR SHALL HOLD A PRE-CONSTRUCTION MEETING PRIOR TO THE START OF CONSTRUCTION TO DISCUSS THE REQUIRED TESTING AND INSPECTION PROCEDURES FOR THIS PROJECT. THE MEETING SHALL ALSO DISCUSS NOTIFICATION AND REPORTING PROCEDURES.
- THE CONTRACTOR SHALL NOTIFY THE SPECIAL INSPECTOR AND TESTING AGENCY AT LEAST 24 HOURS IN ADVANCE OF A REQUIRED INSPECTION OR TEST. UN-INSPECTED WORK THAT REQUIRES INSPECTION OR TESTING MAY BE REJECTED SOLELY ON THAT BASIS.
- THE SPECIAL INSPECTOR AND/OR TESTING AGENCY SHALL IMMEDIATELY NOTIFY THE CONTRACTOR OF DEFICIENT WORK THAT REQUIRES CORRECTIVE ACTION. INSPECTION REPORTS FOR THIS WORK SHALL NOTE WHEN AND HOW THE DEFICIENT WORK WAS CORRECTED. WORK IMMEDIATELY CORRECTED WITH SPECIAL INSPECTOR OR TESTING AGENCY PRESENT AND RE-INSPECTED OR TESTED NEED NOT BE IDENTIFIED AS NON-CONFORMING WORK.
- 7 DEFICIENT WORK, NOT IMMEDIATELY CORRECTED WHILE SPECIAL INSPECTOR OR TESTING AGENCY ARE ON SITE, SHALL BE REPORTED TO THE ENGINEER OF RECORD AND CODE ENFORCEMENT OFFICIAL WITHIN 24 HOURS. A REPORT OF NON-CONFORMANCE SHALL BE ISSUED FOR THIS WORK.
- 8 THE CONTRACTOR SHALL COOPERATE WITH THE SPECIAL INSPECTOR AND TESTING AGENCY INCLUDING SAFE ACCESS TO THE WORK AREAS SO THAT TESTING AND INSPECTIONS CAN BE PERFORMED IN A TIMELY MANNER OR UNDUE DELAY TO THE PROJECT.
- THE SPECIAL INSPECTIONS REQUIREMENTS OF THIS PROJECT IN NO WAY RELIEVE THE CONTRACTOR OF HIS/HER OBLIGATION TO PERFORM WORK IN ACCORDANCE WITH THE REQUIREMENTS OF THE CONTRACT DOCUMENTS OR FROM IMPLEMENTING A EFFECTIVE QUALITY CONTROL PROGRAM.
- 10 EACH TESTING AGENCY SHALL SUBMIT, STAMP AND SIGN AN AGENT'S FINAL REPORT TO THE SPECIAL INSPECTOR FOR ATTACHMENT TO THE SPECIAL INSPECTOR'S FINAL REPORT. THE FINAL REPORT SHALL BE STAMPED AND SIGNED BY THE SPECIAL INSPECTOR AND SUBMITTED TO THE CODE ENFORCEMENT OFFICIAL AND OWNER PRIOR TO THE ISSUANCE OF A CERTIFICATE OF USE

STRUCTURAL ABBREVIATIONS

ABBREVIATION

DESCRIPTION

DESCRIPTIO

ABBREVIATION

NDDINE Y 1/NI 10N	7233141143		
ADJ	ADJACENT	LLH	LONG LEG HORIZONTAL
ADDL	ADDITIONAL	LLY	LONG LEG VERTICAL
ALT	ALTERNATE	LP	LOW POINT
AB	ANCHOR BOLT	LM	LIGHT WEIGHT
ARCH	ARCHITECT	мо	MASONRY OPENING
BRG	BEARING	MAX	MAXIMUM
CLR	CLEAR	MIN	MINIMUM
CMU	CONCRETE MASONRY UNIT	MP	MASONRY PIER
CONST JT	CONSTRUCTION JOINT	NIC	NOT IN CONTRACT
CJ	CONTROL JOINT	NTS	NOT TO SCALE
CU YD	CUBIC YARD	NS	NEAR SIDE
DIA	DIAMETER	00	ON CENTER
DIM	DIMENSION	OF	OUTSIDE FACE
DMG	DRAMING	P	PIER (CONCRETE)
EF	EACH FACE	PL	PLATE
EL	ELEVATION	R	RADIUS
EOD	EDGE OF DECK	RD	ROOF DRAIN
EO5	EDGE OF SLAB	RO	ROUGH OPENING
EQ	EQUAL	50	SLIP CRITICAL
ES	EACH SIDE	SIM	SIMILAR
EM	EACH WAY	506	SLAB ON GRADE
EXIST	EXISTING	STD	STANDARD
EXP	EXPANSION	SYMM	SYMMETRICAL
FS	FAR SIDE	T &B	TOP & BOTTOM
FTG	FOOTING	TOL	TOP OF LEDGE
GA	GAUGE	T05	TOP OF STEEL
GALV	GALVANIZED	TOM	TOP OF WALL
<i>G</i> B	GRADE BEAM	TRANS	TRANSVERSE
GC	GENERAL CONTRACTOR	TYP	TYPICAL
HORIZ	HORIZONTAL	UNO	UNLESS NOTED OTHERWISE
HP	HIGH POINT	VIF	VERIFY IN FIELD
HSS	HOLLOW STRUCTURAL SECTION	VERT	VERTICAL
IF	INSIDE FACE	MP	WORK POINT
JT	JOINT	MD	MOOD
L	ANGLE	MMF	MELDED WIRE FABRIC


STRUCTURAL DESIGN CRITERIA

NOTE: ALL LOADS SHALL BE DETERMINED IN ACCORDANCE WITH 2020 NEW YORK STATE BUILDING CODE. THESE LOADS APPLY TO NEW YORK ONLY, LOAD CAPACITIES OF EXISITING FRAMING WAS NOT VERIFIED. TYPE DESIGN CRITERIA DESCRIPTION RISK CATEGORY GARAGE 40 PSF FLOOR LIVE INACCESSIBLE SECOND FLOOR SPACE 10 PSF LOAD 20 PSF ROOF LIVE LOAD ROOF CONSTRUCTION LOAD IMPORTANCE FACTOR (IS) 40 PSF GROUND SNOW LOAD (Pg) SNOW EXPOSURE FACTOR (Ce) SNOW LOAD THERMAL FACTOR (Ct) 1.2 FLAT ROOF SNOW LOAD (PF) 40.3 PSF DRIFTING SNOW PER ASCE 7-16 IMPORTANCE FACTOR (IW) 1.0 WIND LOAD BASIC WIND SPEED (3-SECOND GUST: V3s) 110 MPH (MAIN FORCE RESISTING SYSTEM) WIND EXPOSURE CATEGORY MAXIMUM WIND PRESSURE PER ASCE 7-16 MAXIMUM WIND PRESSURE FOR WALLS PER ASCE 7-16 WIND LOAD (COMPONENT & CLADDING, MAXIMUM WIND PRESSURE FOR ROOFING PER ASCE 7-16 IMPORTANCE FACTOR (Ie) 1.0 DESIGN SPECTRAL RESPONSE COEFFICIENT (Sds) 0.124g DESIGN SPECTRAL RESPONSE COEFFICIENT (Sd1) 0.062g SOIL SITE CLASSIFICATION D (ASSUMED) EARTHQUAKE LOAD SEISMIC DESIGN CATEGORY PER ASCE 7-16 BASIC SEISMIC - FORCE RESISTING SYSTEM RESPONSE MODIFICATION FACTOR (R) PER ASCE 7-16 ANALYSIS PROCEDURE PER ASCE 7-16


STRUCTURAL SYMBOLS LEGEND


DESIGN SEISMIC BASE SHEAR

BOTTOM OF FOOTING ELEVATION

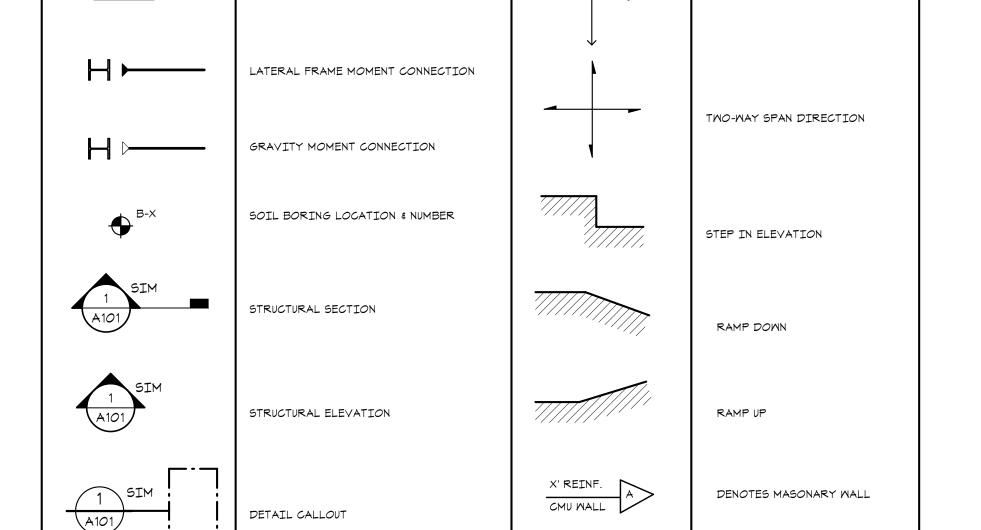

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PER ASCE 7-16

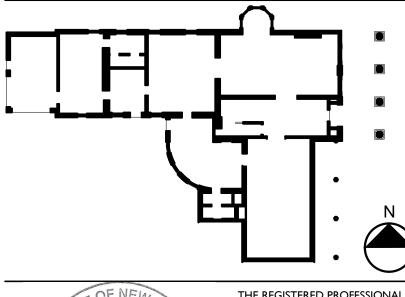ONE-WAY SPAN DIRECTION

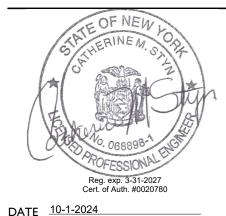WOOD POST DESIGNATION

EDR, DPC 274 North Goodman Street Rochester, New York 14607 Telephone (585) 271-0040

PROJECT NO. 051037 LANFORD REHAB PHASE II EXTERIOR

194 CENTRAL AVENUE FREDONIA, NEW YORK 14063

100% BID DOCUMENTS

Revision Number Date Description	Revision Schedule					
·	Revision Number	Date	Description			

DRAWING ISSUED:

Project Number:

FBA PROJECT #00388.00

Checked By:

CS

Drawing Title

SYMBOLS, ABBREVIATIONS, GENERAL NOTES & DESIGN CRITERIA


Drawing Number

S0-01


	REINFORCING BAR EMBEDMENT / LAP SPLICE SCHEDULE															
		CONCRETE COVER < 1 1/2" CONCRETE COVER > 1 1/2"														
D.D. C.T.75		TOP I	3ARS			OTHE	R BARS			TOP E	3ARS			OTHE	R BARS	
BAR SIZE	3,00	00 psi	4,000	psi	3,00	00 psi	4,000) psi	3,0	00 psi	4,000) psi	3,0	00 psi	4,000) psi
	EMBED.	LAP	EMBED.	LAP	EMBED.	LAP	EMBED.	LAP	EMBED.	LAP	EMBED.	LAP	EMBED.	LAP	ЕМВЕД.	LAP
#3	13"	17"	12"	15"	12"	13"	12"	12"	13"	17"	12"	15"	12"	13"	12"	12"
#4	22"	28"	19"	24"	17"	22"	15"	19"	17"	23"	15"	20"	13"	17"	12"	15"
#5	32"	41"	28"	36"	24"	32"	21"	28"	22"	28"	19"	24"	17"	22"	15"	19"
#6	43"	56"	37"	48"	33"	43"	29"	37"	26"	34"	22"	29"	20"	26"	17"	22"
#7	69"	90"	60"	78"	53"	69"	46"	60"	43"	55"	37"	48"	33"	43"	28"	37"
#8	86"	111"	74"	96"	66"	86"	57"	64"	54"	70"	47"	60"	41"	54"	36"	47"

NOTES:


- 1.) TOP BARS ARE THOSE WHICH ARE ORIENTED HORIZONTALLY AND HAVE MORE THAN 12" OF CONCRETE BELOW THE BAR.
- 2.) EMBEDMENT AND LAP SPLICE LENGTHS SHOWN ARE APPLICABLE TO ASTM A615 GR. 60 REINFORCING BARS. FOR GR. 75 REINFORCING BARS, MULTIPLY LENGTHS BY 1.25.
- 3.) TABULATED VALUES ARE BASED ON CONCRETE COVER CONTROLLING. FOR BARS WITH CENTER-TO-CENTER SPACING LESS THAN 1.0Db (BAR DIAMETER) PLUS TWICE THE CONCRETE COVER, NOTIFY THE ENGINEER.
- 4.) WHERE CONCRETE DEPTH PRECLUDES FULL EMBEDMENT, PROVIDE 90 DEGREE HOOK.
- 5.) PROVIDE CONCRETE PROTECTION FOR REINFORCEMENT AS DESCRIBED IN ACI 318, CHAPTER 7.
- 6.) TABULATED VALUES ARE BASED ON NORMAL WEIGHT AGGREGATE. FOR LIGHTWEIGHT AGGREGATE, MULTIPLY LENGTHS BY 1.33.

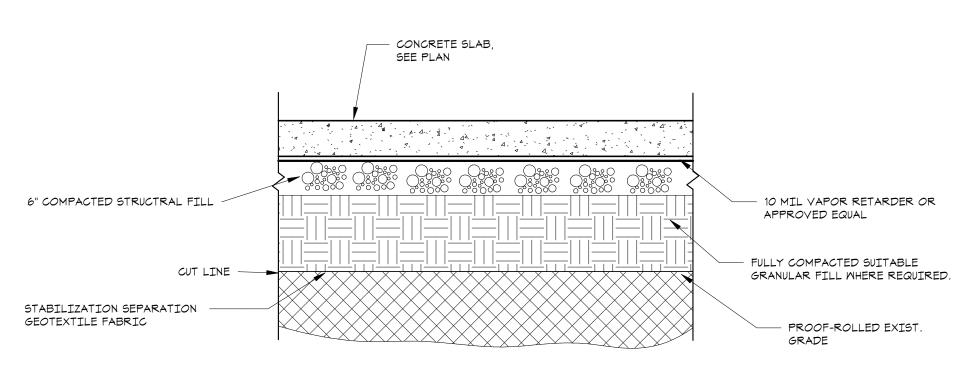


TYPICAL SLAB BASE DETAIL

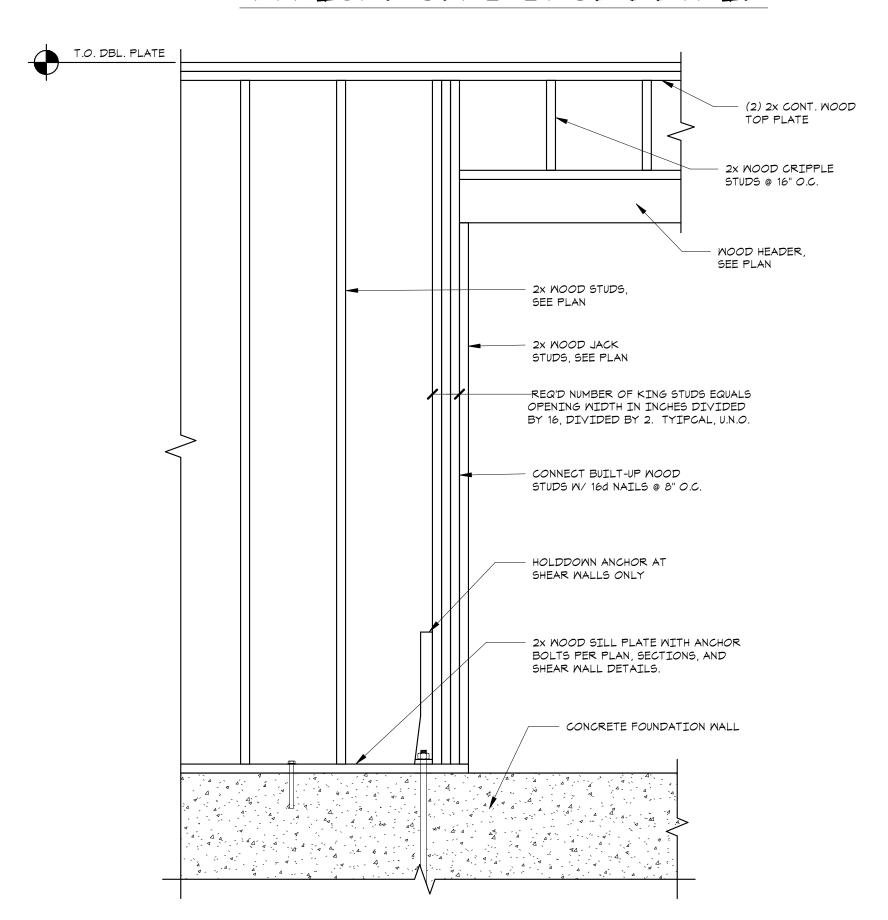


TYPICAL FRAMING ELEVATION AT OPENING DETAIL

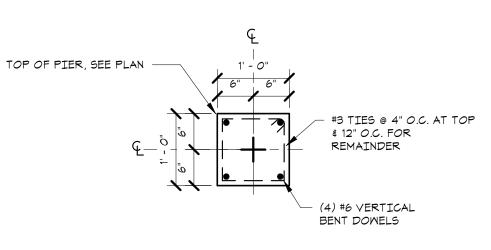




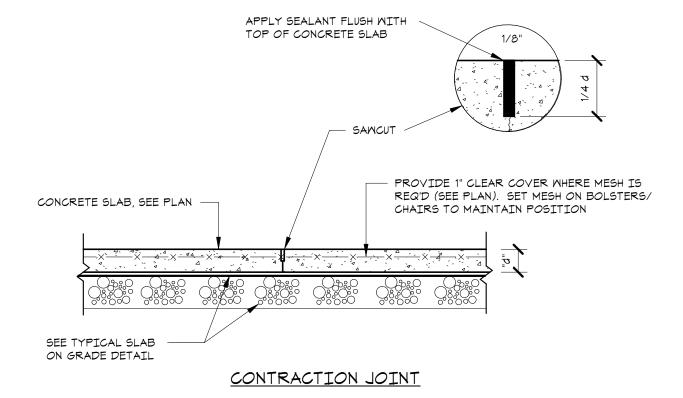


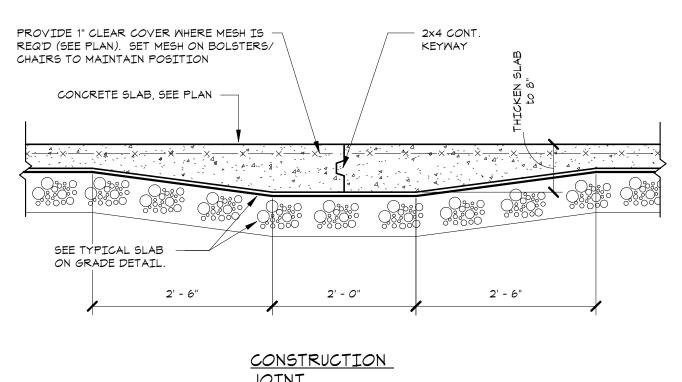


TYPICAL CONTROL JOINTS

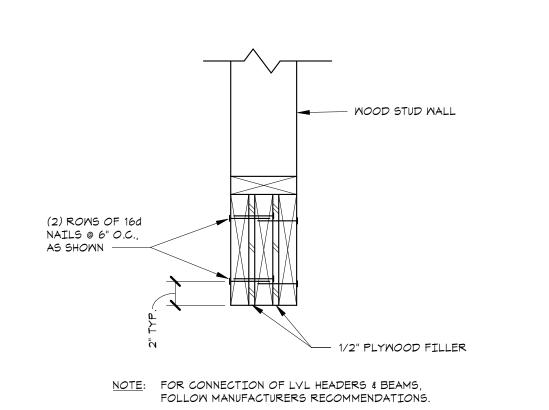

TYPICAL MULTIPLE PLY WOOD BEAM/HEADER DETAIL

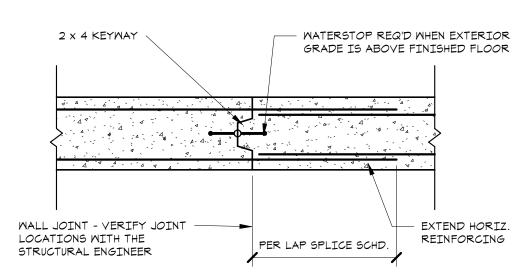


TYPICAL FOUNDATION MALL CONSTRUCTION JOINT DETAIL

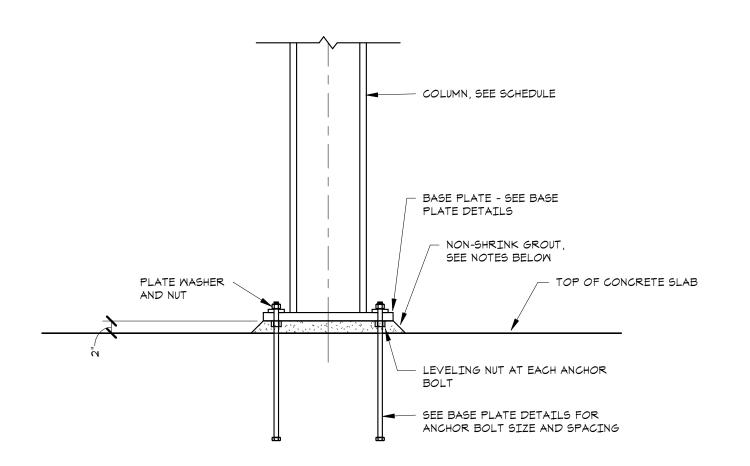

TYPICAL COLUMN BASE DETAIL


- 1.) SET COLUMN PLUMB ADJUST LEVELING NUTS AS REQUIRED
- 2.) IF CLEARANCE IS INSUFFICIENT FOR ADJUSTMENT OF NUTS, SUPPORT BASEPLATE WITH STEEL SHIMS.
- 3.) DRY-PACK BELOW BASE PLATE WITH NON-SHRINK, NON-METALLIC GROUT

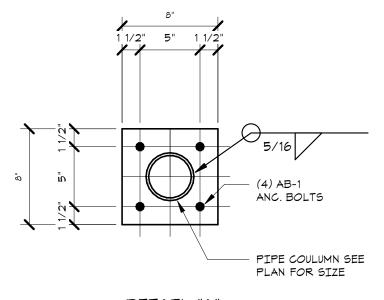

<u>DETAIL "A"</u>

BASE PLATE DETAILS


SCALE:1 1/2" = 1'-0"

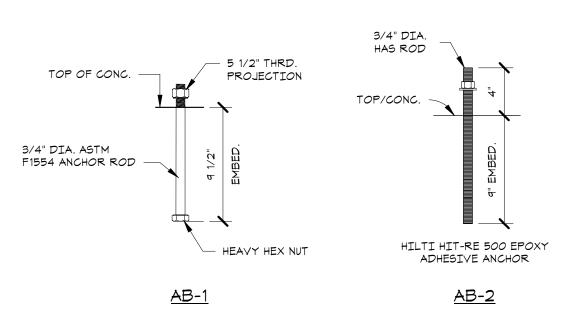


ANCHOR BOLT DETAILS

SCALE: 1/2" = 1'-0"

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PROJECT NO. 051037

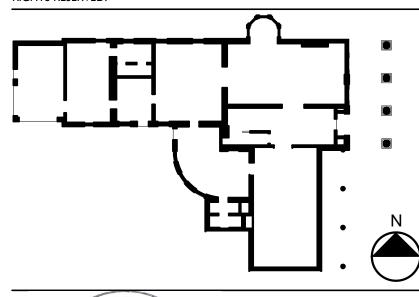PHASE II EXTERIOR

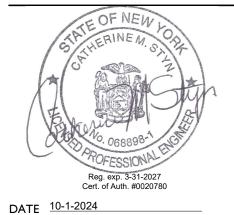194 CENTRAL AVENUE

FREDONIA, NEW YORK 14063

LANFORD REHAB

100% BID DOCUMENTS

	Revision S	Schedule
Revision Number	Date	Description

DRAWING ISSUED:

Project Number:

FBA PROJECT #00388.00

Checked By:

NF

CS

Drawing Title


TYPICAL DETAILS

Drawing Number

S0-02

	CONCRETE FOOTING SCHEDULE							
	FOOTINGS DESIGNED FOR 1,500 PSF BEARING CAPACITY							
MARK	LENGTH	MIDTH	THICKNESS	REINFORGING				
F-1	3' - 6"	3' - 6"	12"	(4) #5 EACH WAY, BOTT.				

MOOD POST SCHEDULE					
MARK	SIZE, SPECIES, & GRADE				
MP-1	6" X 6", DOUG FIR-LARCH, No. 1				
MP-2	2 X 4 DOUG FIR-LARCH, No. 1				

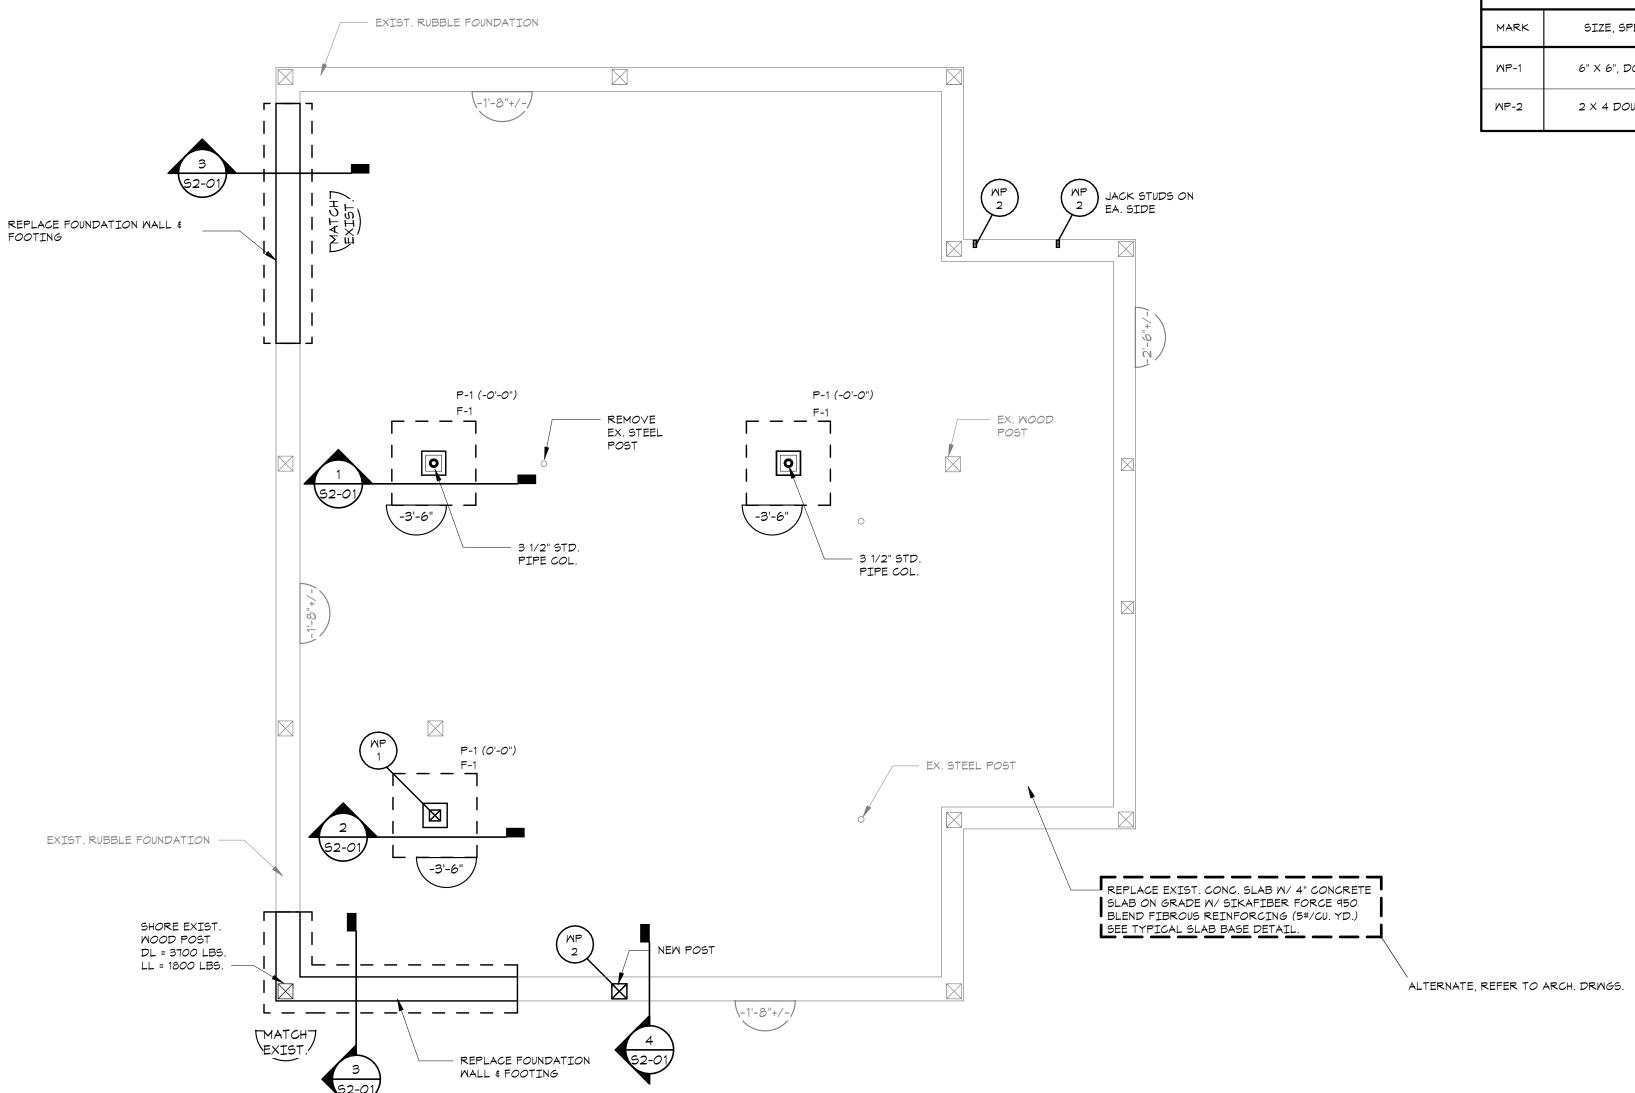

NORTH




NOTES:


1. FLOOR CONSTRUCTION SHALL BE 4" CONCRETE SLAB ON GRADE W/ SIKAFIBER FORCE 950 BLEND FIBROUS REINFORCING (5#/CU. YD.) SEE TYPICAL SLAB BASE DETAIL.

- 2. FINISH FLOOR ELEVATION SHALL BE 0'-0". ACTUAL ELEVATION = XXX.X'
- 3. CONSTRUCTION & CONTROL JOINTS ARE NOTED THUS, C.J., ON PLAN. SEE TYPICAL DETAILS.
- 4. F-X DENOTES CONCRETE FOOTING. SEE FOOTING SCHEDULE FOR SIZE & REINFORCING.
- 5. FOUNDATIONS HAVE BEEN DESIGNED BASED ON A PRESUMPTIVE LOAD-BEARING VALUE OF 1,500PSF ASSUMING CLAY, SANDY CLAY, SILTY CLAY, CLAYEY SILT, SILT OR SANDY SILT.
- 6. BOTTOM OF FOOTING/UNDERPINNING ELEVATIONS SHALL BE ASSUMED AT -4'-O" FROM FINISH FLOOR ELEVATION (O'-O") UNLESS NOTED OTHERWISE ON PLAN, SHOWN -X'-X" FROM FINISH FLOOR ELEVATION (O'-O"). ACTUAL ELEVATION TO BE DETERMINED IN FIELD.
- 7. P-X DENOTED CONCRETE PIER. SEE PIER DETAILS FOR SIZE & REINFORGING.
- 8. REFER TO DRAWINGS SO-01 & SO-02 FOR GENERAL NOTES, SYMBOLS, ABBREVIATIONS & TYPICAL DETAILS TO BE INCORPORATED INTO THE WORK.

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PROJECT NO. 051037 LANFORD REHAB PHASE II EXTERIOR

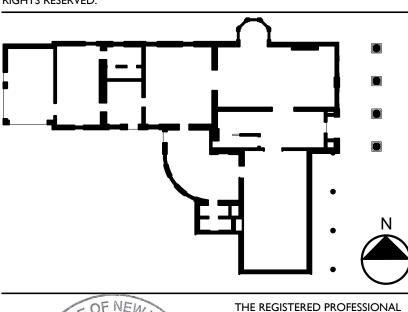194 CENTRAL AVENUE FREDONIA, NEW YORK 14063

100% BID DOCUMENTS

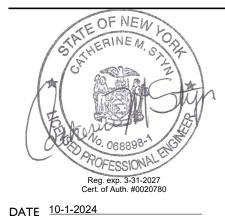	Revision S	Schedule
Revision Number	Date	Description

DRAWING ISSUED:	
Project Number: FBA PROJECT #00388.00	Scale: As indicated
Drawn By:	Checked By:

Drawing Title

FOUNDATION / FIRST FLOOR PLAN

Drawing Number

S1-01

SIZE, SPECIES, & GRADE (2) 2 x 8 DOUG FIR - LARCH, No. 2	M	OOD HEADER SCHEDULE
-1 (2) 2 x 8 DOUG FIR - LARCH, No. 2	ARK	SIZE, SPECIES, & GRADE
	-1	(2) 2 x 8 DOUG FIR - LARCH, No. 2


NORTH

Į.	NOOD BEAM SCHEDULE
MARK	SIZE, SPECIES, & GRADE
B-1	2 X 8 DOUG FIR LARCH, No.2
B-2	1 3/4" X 5 1/2" LVL
B-3	(2) 1 3/4" X 7 1/4" LVL
B-4	(3) 1 3/4" X 7 1/4" LVL
B-5	1 3/4" X 9 1/2" LVL
B-6	(2) 1 3/4" X 11 7/8" LVL
B-7	(3) 1 3/4" X 14" LVL

MP 1	—— WOOD POST UP ——	MP 1	
	EX. WOOD POST UP	EX. STEEL POST	EX. WOOD POST
	EX. 8" STL. BM (EL. +8") EX. POST UP	EX. 12" STL. BM. (EL. +1' 8")	EX. POST UP

EX. STEEL POST

ı	NOOD POST SCHEDULE
MARK	SIZE, SPECIES, & GRADE
MP-1	6" X 6", DOUG FIR LARCH, No. 1
MP-2	2 X 4 DOUG FIR LARCH, No. 1

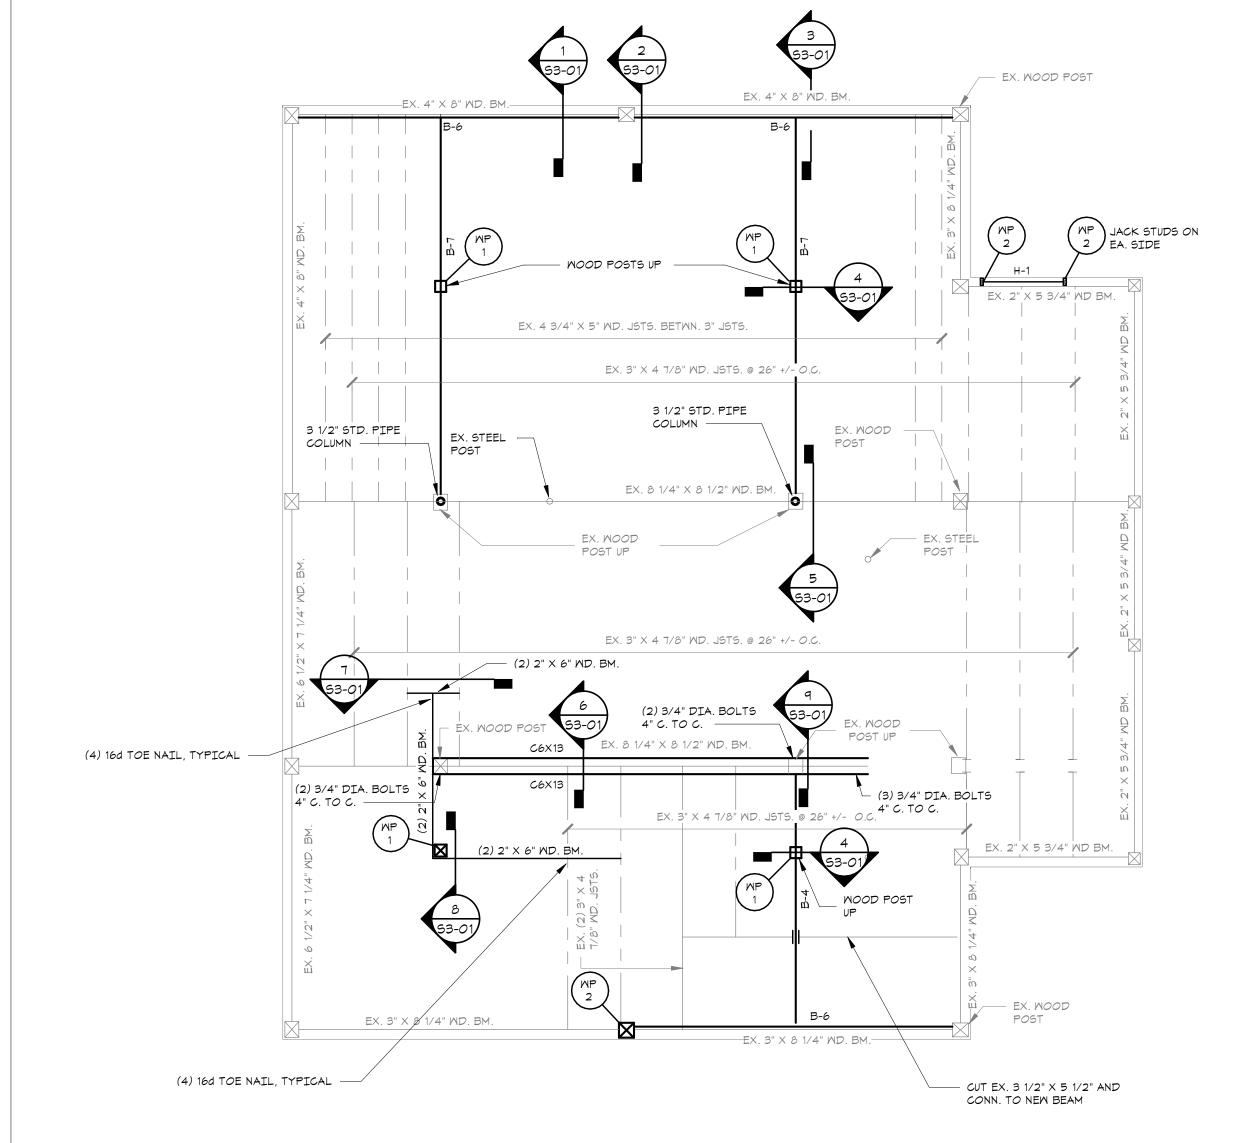



NOTES:


- CONTRACTOR TO VERIFY ALL CONDITIONS AND DIMENSIONS IN THE FIELD. IMMEDIATELY NOTIFY ARCHITECT OF ANY DISCREPANCIES FOUND.
- 2. REFER TO DRAWINGS SO-01 & SO-02 FOR GENERAL NOTES, SYMBOLS, ABBREVIATIONS & TYPICAL DETAILS TO BE INCORPORATED INTO THE WORK.



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DATE 10-1-2024

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PROJECT NO. 051037 LANFORD REHAB PHASE II EXTERIOR

194 CENTRAL AVENUE FREDONIA, NEW YORK 14063

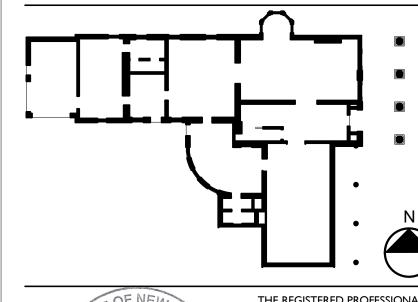100% BID DOCUMENTS

Revision Schedule			
Revision Number	Date	Description	

DRAWING ISSUED:

Project Number:

FBA PROJECT #00388.00

Scale:

As indicated

Drawn By:

NF

Checked By:

CS


Drawing Title

SECOND FLOOR FRAMING PLAN

Drawing Number

S1-02

MOOD HEADER SCHEDULE					
1ARK	SIZE, SPECIES, & GRADE				
H-1	(2) 2 X 8 DOUG FIR LARCH, No. 2				

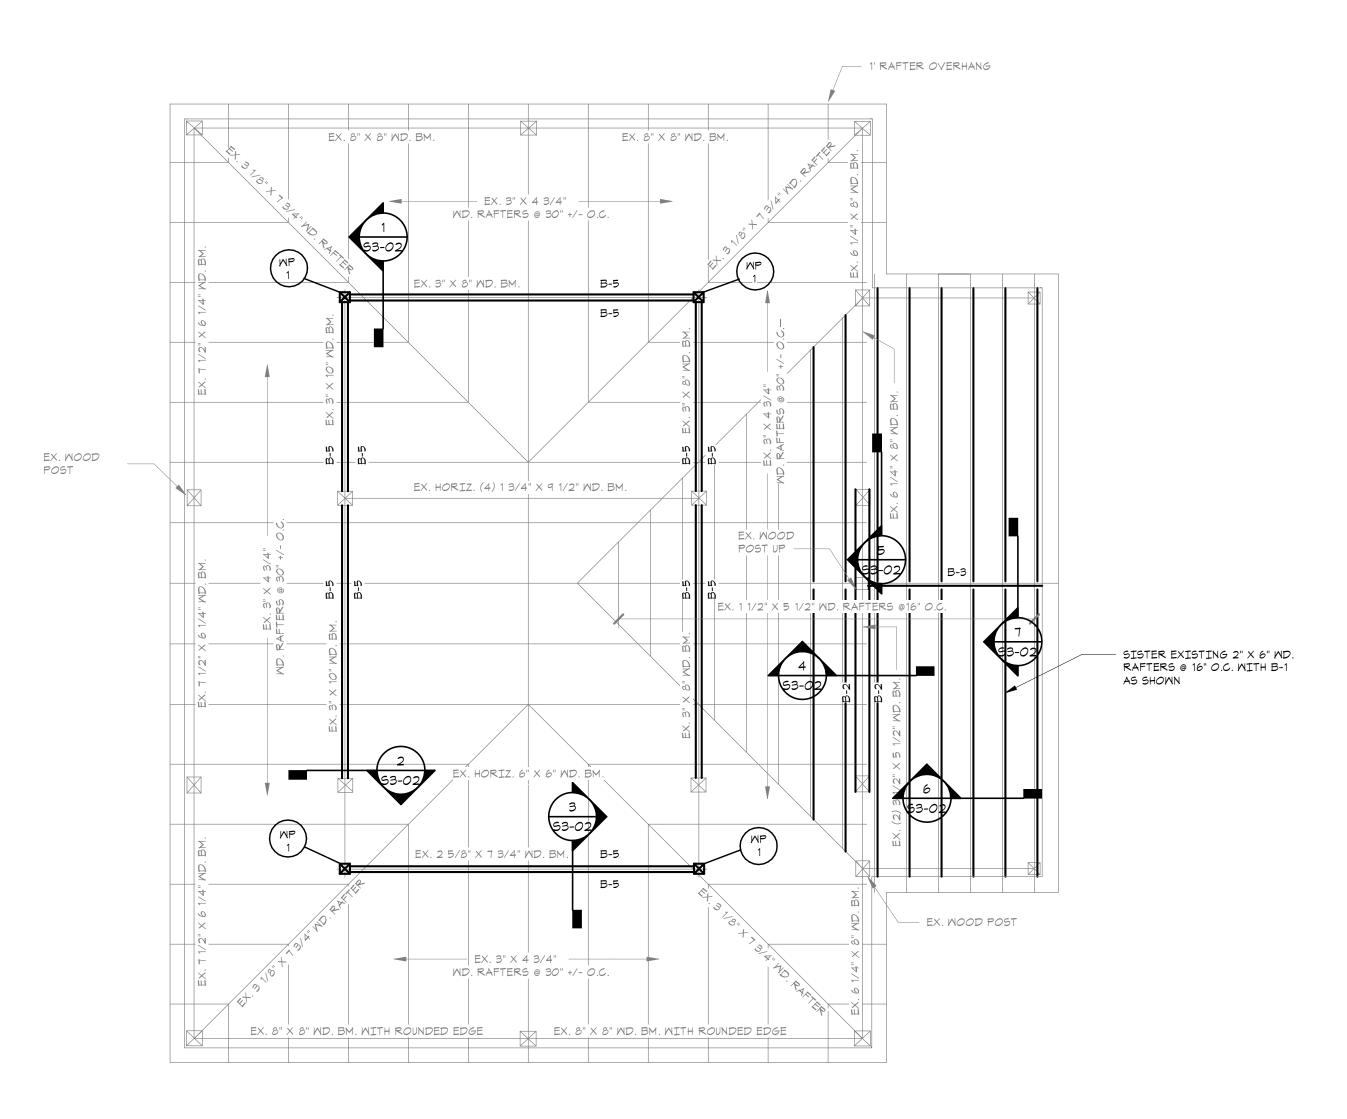



NORTH

CONTRACTOR TO VERIFY ALL CONDITIONS AND DIMENSIONS IN THE FIELD. IMMEDIATELY NOTIFY ARCHITECT OF ANY DISCREPANCIES FOUND.

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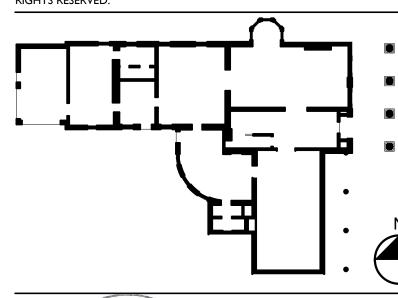
REFER TO DRAWINGS 50-01 & 50-02 FOR GENERAL NOTES, SYMBOLS, ABBREVIATIONS &



	MOOD BEAM SCHEDULE				
	MARK	SIZE, SPECIES, & GRADE			
	B-1	2 X 8 DOUG FIR LARCH, No. 2			
	B-2	1 3/4" X 5 1/2" LVL			
	B-3	(2) 1 3/4" X 7 1/4" LVL			
	B-4	(3) 1 3/4" X 7 1/4" LVL			
	B-5	1 3/4" X 9 1/2" LVL			
	B-6	(2) 1 3/4" X 11 7/8" LVL			
	B-7	(3) 1 3/4" X 14" LVL			

MOOD POST SCHEDULE				
MARK	SIZE, SPECIES, & GRADE			
MP-1	6" X 6", DOUG FIR LARCH, No.1			
MP-2	2 X 4 DOUG FIR LARCH, No.1			

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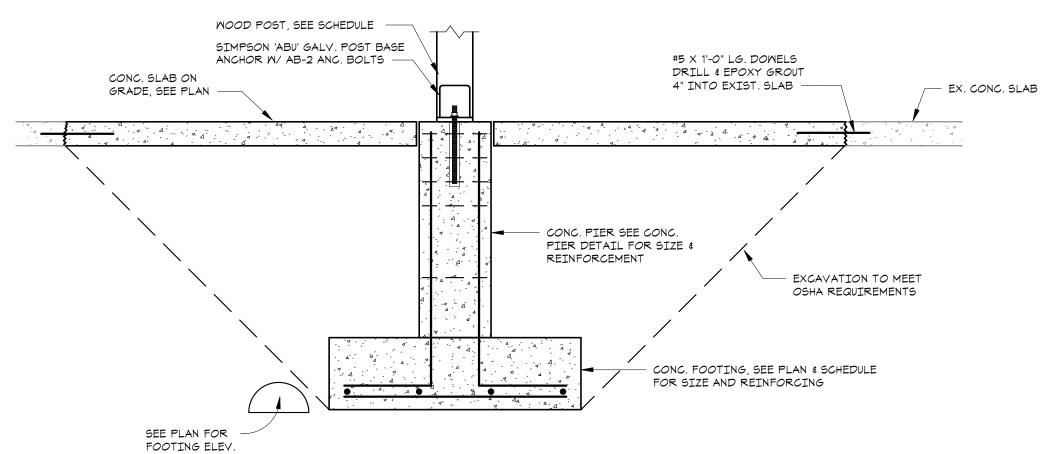
DRAWING ISSUED: 10/1/2024 Project Number: Scale: As indicated FBA PROJECT #00388.00 Drawn By: Checked By: CS

Drawing Title


ROOF FRAMING PLAN


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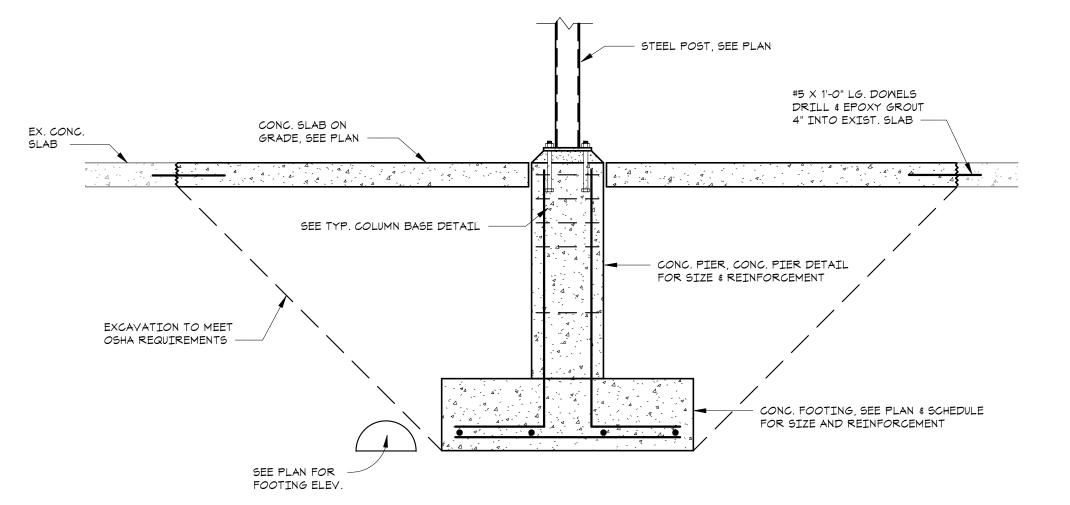
S1-03








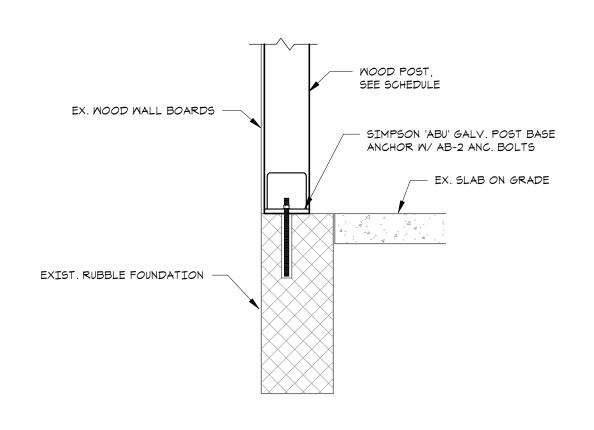


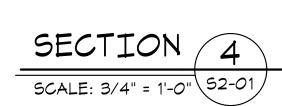




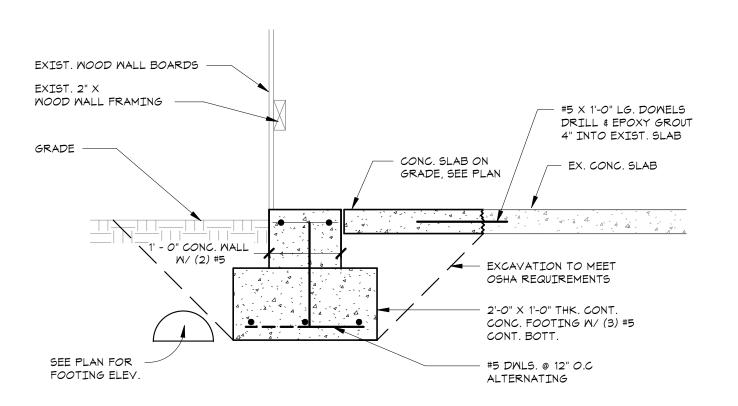



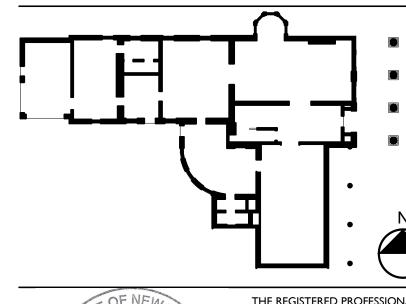

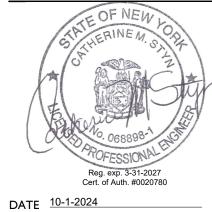

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ENERGY CONSERVATION CODE OF
NEW YORK STATE AND APPLICABLE
FEDERAL LAWS AND REGULATIONS
AND TO THE BEST OF MY
KNOWLEDGE AND BELIEF, THESE
CONSTRUCTION DOCUMENTS ARE
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PROJECT NO. 051037 LANFORD REHAB PHASE II EXTERIOR

194 CENTRAL AVENUE FREDONIA, NEW YORK 14063

100% BID DOCUMENTS

Revision Schedule			
Revision Number	Date	Description	

 DRAWING ISSUED:
 10/1/2024

 Project Number:
 Scale:

 FBA PROJECT #00388.00
 3/4" = 1'-0"

 Drawn By:
 Checked By:


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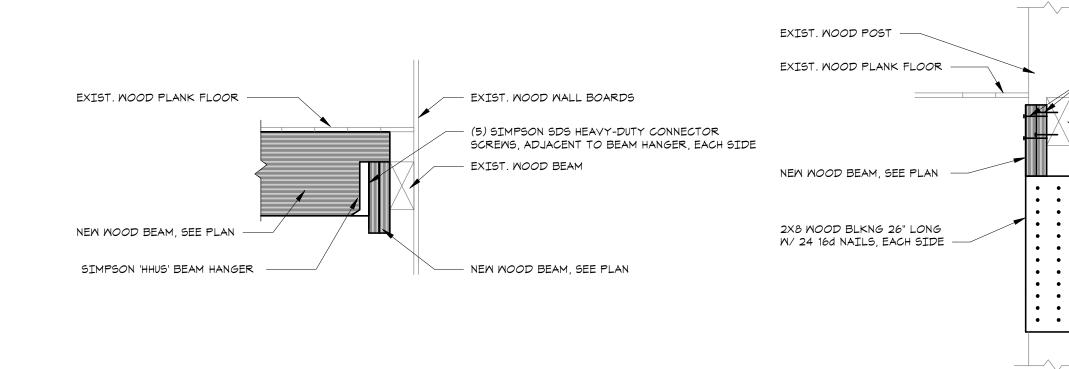
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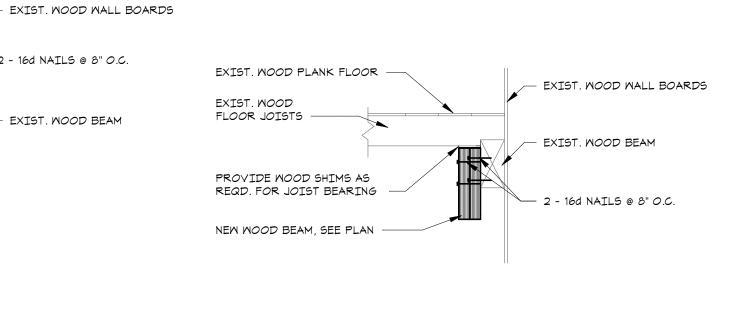
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Drawing Number

S2-01








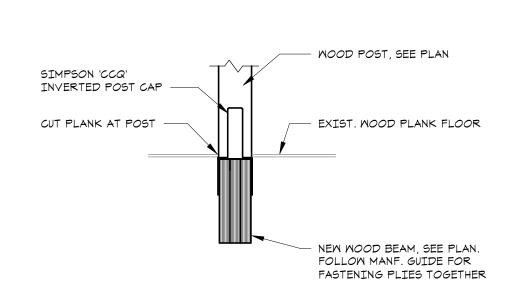





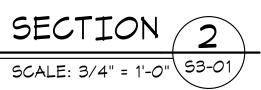



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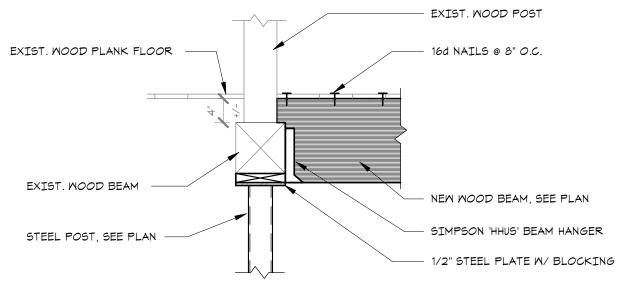
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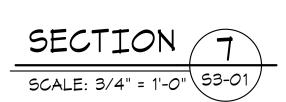





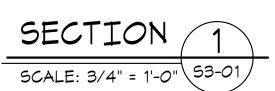


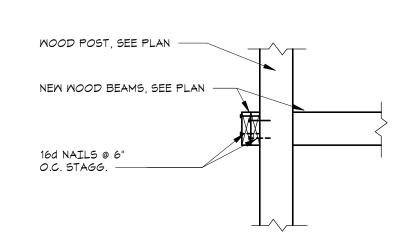


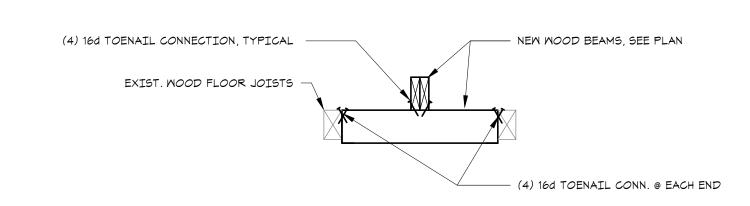


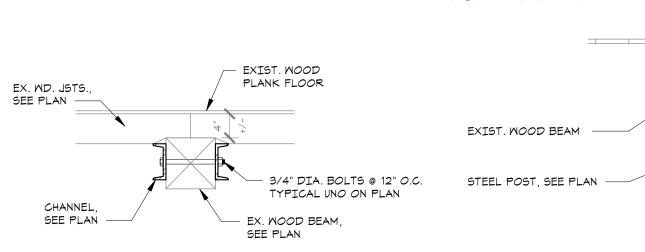

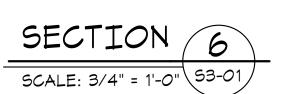


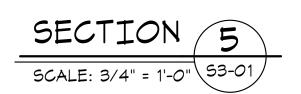

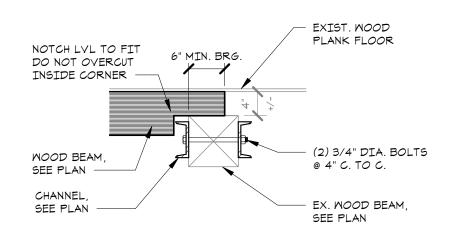

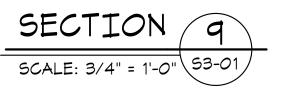

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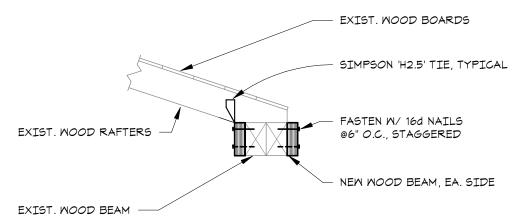
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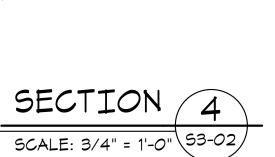
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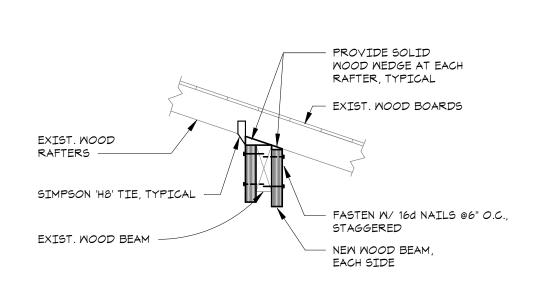
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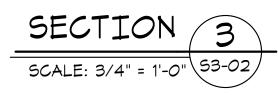
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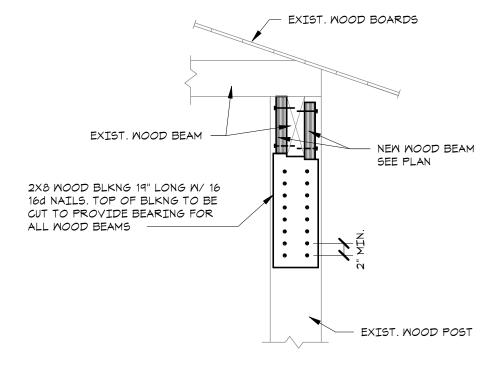
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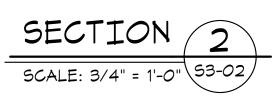


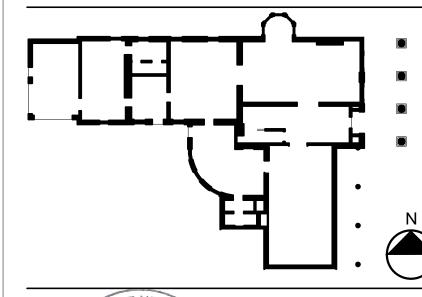














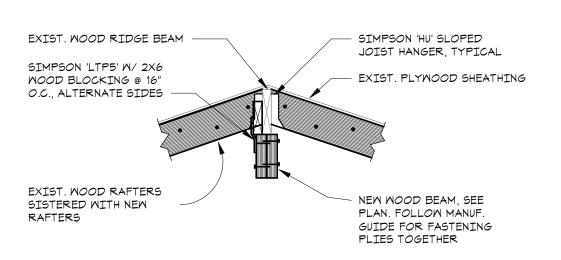


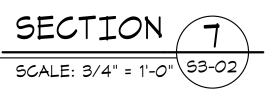


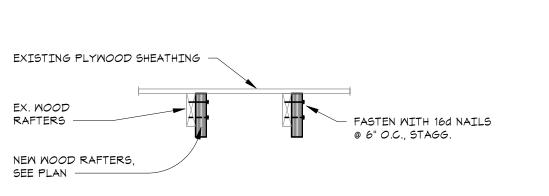


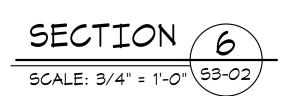


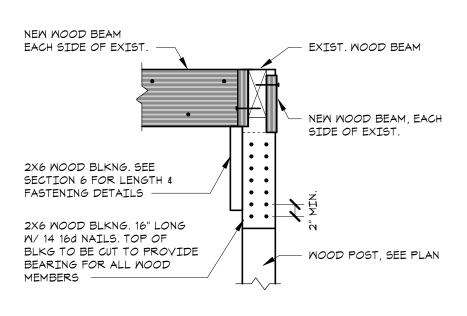


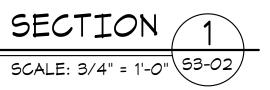

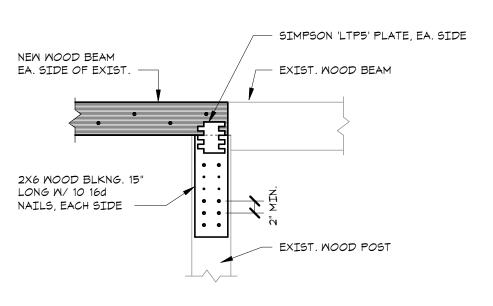

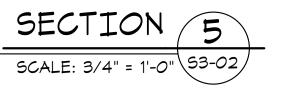

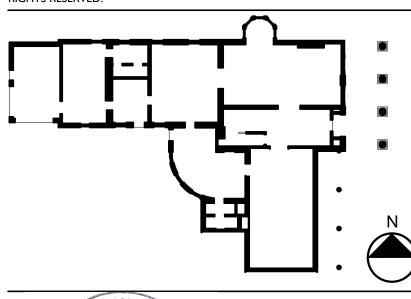

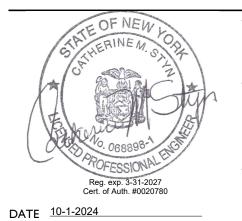

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194 CENTRAL AVENUE FREDONIA, NEW YORK 14063

100% BID DOCUMENTS

Revision Schedule		
Revision Number	Date	Description

DRAWING ISSUED:

Project Number:

FBA PROJECT #00388.00

Scale:

3/4" = 1'-0"

Drawn By:

NF

Checked By:


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Drawing Title

FRAMING SECTIONS

Drawing Number

S3-02

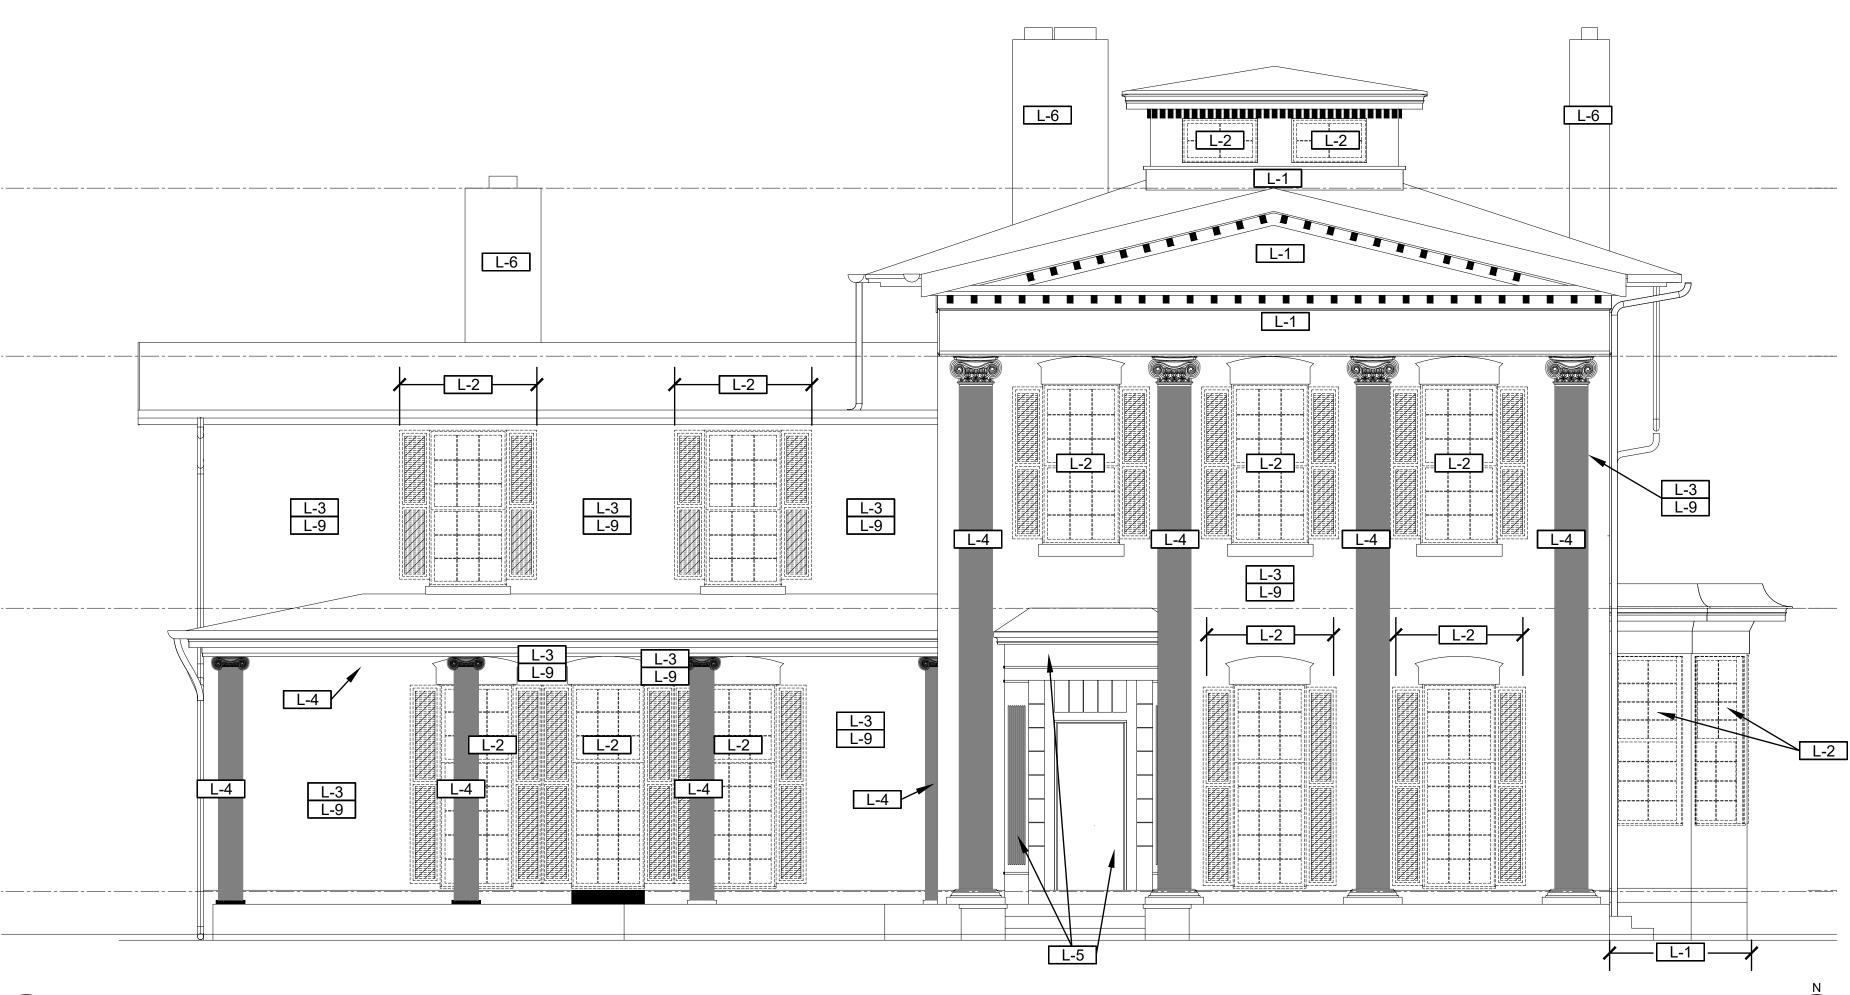

EAST ELEVATION - HAZARDOUS MATERIALS PLAN

LEAD-BASED PAINT ABATEMENT NOTES

ALL LOOSE PAINT SHALL BE REMOVED IN IDENTIFIED AREAS DOWN TO AN INTACT SURFACE IN PREPARATION FOR REPAINTING. REFER TO ARCHITECTURAL DRAWINGS AND SPECIFICATIONS FOR SURFACE PREPARATION REQUIREMENTS. COORDINATE ALL WORK WITH PAINTING/GENERAL CONTRACTOR. ALL REMOVED PAINT, PAINTED COMPONENTS SCHEDULED FOR DISPOSAL AND ASSOCIATED DEBRIS SHALL BE DISPOSED OF IN ACCORDANCE WITH GENERAL NOTE K.

- L-1 REMOVE EXISTING LEAD-BASED PAINT AT WOOD SIDING, SOFFIT AND TRIM. REFER TO ARCHITECTURAL DEMOLITION DRAWINGS, AND SPECIFIC DEMOLITION NOTE 2 FOR REMOVAL PROCEDURE REQUIREMENTS. REMOVE DAMAGED SIDING AND TRIM SCHEDULED FOR DEMOLITION. REFER TO ARCHITECTURAL NEW WORK ELEVATIONS FOR LOCATIONS. COORDINATE WORK WITH CARPENTER TASKED WITH WOOD COMPONENT REPLACEMENT.
- L-2 REMOVE EXISTING LOOSE LEAD-BASED PAINT AT WINDOW FRAMES. REMOVE AND PROPERLY DISPOSE OF SCREENS AND WINDOW SASHES COATED WITH LEAD-BASED PAINT. DETACH SHUTTERS AND PROPERLY DISPOSE. REMOVE EXISTING LOOSE LEAD-BASED PAINT FROM WALL SURFACE BENEATH DOWN TO AN INTACT SURFACE.
- L-3 REMOVE EXISTING LOOSE LEAD-BASED PAINT AT BRICK. ALL REMOVED PAINT AND ASSOCIATED DEBRIS SHALL BE DISPOSED OF IN ACCORDANCE WITH GENERAL NOTE K.
- L-4 REMOVE EXISTING LOOSE LEAD-BASED PAINT AT PORCH CEILING, ASSOCIATED WOOD TRIM AND PORCH COLUMNS/CAPITALS.
- L-5 REMOVE EXISTING LEAD-BASED PAINT FROM DOOR SLAB, DOOR FRAME AND ASSOCIATED TRIM. REFER TO ARCHITECTURAL DEMOLITION DRAWINGS SPECIFIC DEMOLITION NOTE 2 FOR REMOVAL PROCEDURE REQUIREMENTS.
- L-6 REMOVE ALL LEAD-BASED PAINT DOWN TO AND FROM BRICK SUBSTRATE ON ALL CHIMNEYS. PROTECT BRICK DURING REMOVAL ACTIVITIES.
- L-7 NOT USED.
- L-8 NOT USED

ALTERNATE 1

L-9 REMOVE ALL LEAD BASED PAINT FROM BRICK SUBSTRATE



PHOTO 1 VIEW OF PORCH CEILING.

GENERAL NOTES

- A. PERFORM ALL WORK IN ACCORDANCE WITH ALL APPLICABLE LOCAL, STATE, AND FEDERAL RULES, REGULATIONS, AND GUIDELINES, VARIANCES AND CONTRACT DOCUMENTS.
- B. ALL MATERIAL MEASUREMENTS AND/OR QUANTITIES AND LOCATIONS ARE APPROXIMATE AND FOR GENERAL ORIENTATION ONLY. CONTRACTOR IS RESPONSIBLE FOR FIELD VERIFICATION AT THE SITE PRIOR TO BIDDING.
- C. THE LOCATION OF ANY STORAGE OF MATERIAL, EQUIPMENT, AND WASTE TRAILER/DUMPSTER SHALL BE COORDINATED WITH AND APPROVED BY THE OWNER OR THE OWNER'S REPRESENTATIVE.
- D. SECURE ALL TOOLS, EQUIPMENT, AND SUPPLIES. THE OWNER OR THE OWNER'S REPRESENTATIVE WILL NOT BE LIABLE FOR THEFT OR DAMAGE.
- E. LEAD-BASED PAINT IDENTIFIED IN THE REPORT IS TO BE ABATED PRIOR TO ANY CONSTRUCTION THAT COULD DISTURB THESE MATERIALS.
- F. KEEP THE WORK AREA IN A CLEAN AND SAFE CONDITION. CONTRACTOR SHALL ENSURE THAT UNCERTIFIED PERSONNEL OR UNAUTHORIZED VISITORS DO NOT ENTER ACTIVE WORK AREAS AT
- G. PROVIDE TEMPORARY PROTECTION TO KEEP THE WORK AREAS AND BUILDING IN A SECURE AND WATERTIGHT CONDITION AT ALL TIMES DURING THE PERFORMANCE OF THE CONTRACT WORK. THE CONTRACTOR SHALL BE RESPONSIBLE FOR ANY DAMAGE CAUSED TO ANY AREAS OF THE BUILDING AS A RESULT OF IMPROPER TEMPORARY PROTECTION.
- H. PROTECT ALL FINISHES SCHEDULED TO REMAIN. CONTRACTOR IS RESPONSIBLE FOR ALL DAMAGE TO FINISHES.
- I. PROVIDE ALL SCAFFOLDING, LIFTS, ETC. REQUIRED TO PERFORM ITS WORK.
- J. AN INSPECTION FOR ACM, LBP, AND PCB CAULKS HAS BEEN COMPLETED. A COPY OF THE REPORT IS INCLUDED IN THE CONTRACT DOCUMENTS. ASBESTOS CONTAINING MATERIALS IDENTIFIED IN THE REPORT ARE TO BE ABATED PRIOR TO ANY CONSTRUCTION THAT COULD DISTURB THESE MATERIALS. PRESERVE AND PROTECT BUILDING MATERIALS AND FINISHES, FACILITY EQUIPMENT, AND FURNISHINGS PRESENT WITHIN EACH WORK AREA THAT ARE NOT REMOVED, ABATED, OR SCHEDULED FOR DEMOLITION. PERFORM WORK WITHOUT DAMAGE TO OR CONTAMINATION OF ADJACENT OR NEARBY AREAS. WHERE SUCH AREAS ARE DAMAGED, PROVIDE FOR RESTORATION TO THE SATISFACTION OF THE OWNER. WHERE SUCH AREAS ARE CONTAMINATED, PROVIDE FOR REQUISITE CONTAINMENT AND CLEANUP.
- K. ALL REMOVED PAINT, CHIPS, UNDERLYING SUBSTRATES AND ASSOCIATED DEBRIS SHALL BE PROPERLY DISPOSED OF IN ACCORDANCE WITH SECTION 028333: REMOVAL OF LEAD-CONTAINING MATERIAL. LOOSE PAINT FLAKES SHALL BE SEGREGATED, COLLECTED FOR TESTING AND DISPOSAL PER THE SPECIFICATION. FOR BIDDING, PAINT CHIPS, AND ASSOCIATED DEBRIS ARE ASSUMED TO BE DISPOSED AS RCRA HAZARDOUS WASTE AT AN APPROPRIATE LANDFILL IMMEDIATELY FOLLOWING PROJECT COMPLETION WITH PROPER WASTE MANIFESTS.
- L. ANTICIPATE 75% OF PAINT WILL REQUIRE REMOVAL FROM IDENTIFIED COMPONENTS FOR BIDDING PURPOSES.


LEAD AWARENESS NOTES

- 1. CONDUCT ALL WORK IN ACCORDANCE WITH APPLICABLE FEDERAL, STATE, AND LOCAL REQUIREMENTS, INCLUDING OSHA 29 CFR 1926.62: LEAD EXPOSURE IN CONSTRUCTION: INTERIM FINAL RULE AND 40 CFR SUBPART E (EPA RRP RULE) FOR ALL ACTIVITIES DURING WHICH AN EMPLOYEE MAY BE OCCUPATIONALLY EXPOSED TO LEAD. ALL CONTRACTORS SHALL ENSURE THAT THEIR EMPLOYEES WEAR PROPER PERSONAL PROTECTIVE EQUIPMENT AND/OR UTILIZE APPROPRIATE WORK METHODS TO PREVENT ELEVATED BLOOD LEAD LEVELS OR EXPOSURE ABOVE THE PERMISSIBLE EXPOSURE LIMIT. DISPOSAL OF GENERATED PAINT CHIPS SHALL BE IN COMPLIANCE WITH ALL APPLICABLE FEDERAL AND STATE REGULATIONS REGARDING LEAD.
- 2. FURNISHING THIS INFORMATION IS NOT INTENDED TO RELIEVE THE CONTRACTOR OF ITS RESPONSIBILITIES UNDER OSHA TO DETERMINE IF THEIR EMPLOYEES AND SUBCONTRACTORS MAY BE EXPOSED TO LEAD AND TO WARN THEIR EMPLOYEES OF THE POTENTIAL DANGERS OF THE DISTURBANCE OF LEAD-CONTAINING MATERIALS.
- 3. BASED ON THE TESTING, THE FOLLOWING COMPONENTS HAVE BEEN IDENTIFIED TO BE COATED/CONTAIN LEAD-BASED PAINT:

LANFORD HOUSE

- EXTERIOR WALLS
- PLUMBING VENT BOOT CHIMNEY
- PORCH OVERHANG
- COLUMNS
- WINDOWS
- WINDOW FRAMES WINDOW CASINGS
- SHUTTERS
- SOFFIT
- **DETACHED GARAGE** SIDING
- WINDOWS
- WINDOW FRAMES
- WINDOW CASINGS OVERHEAD DOORS
- OVERHEAD DOOR FRAMES
- SHUTTERS SOFFIT

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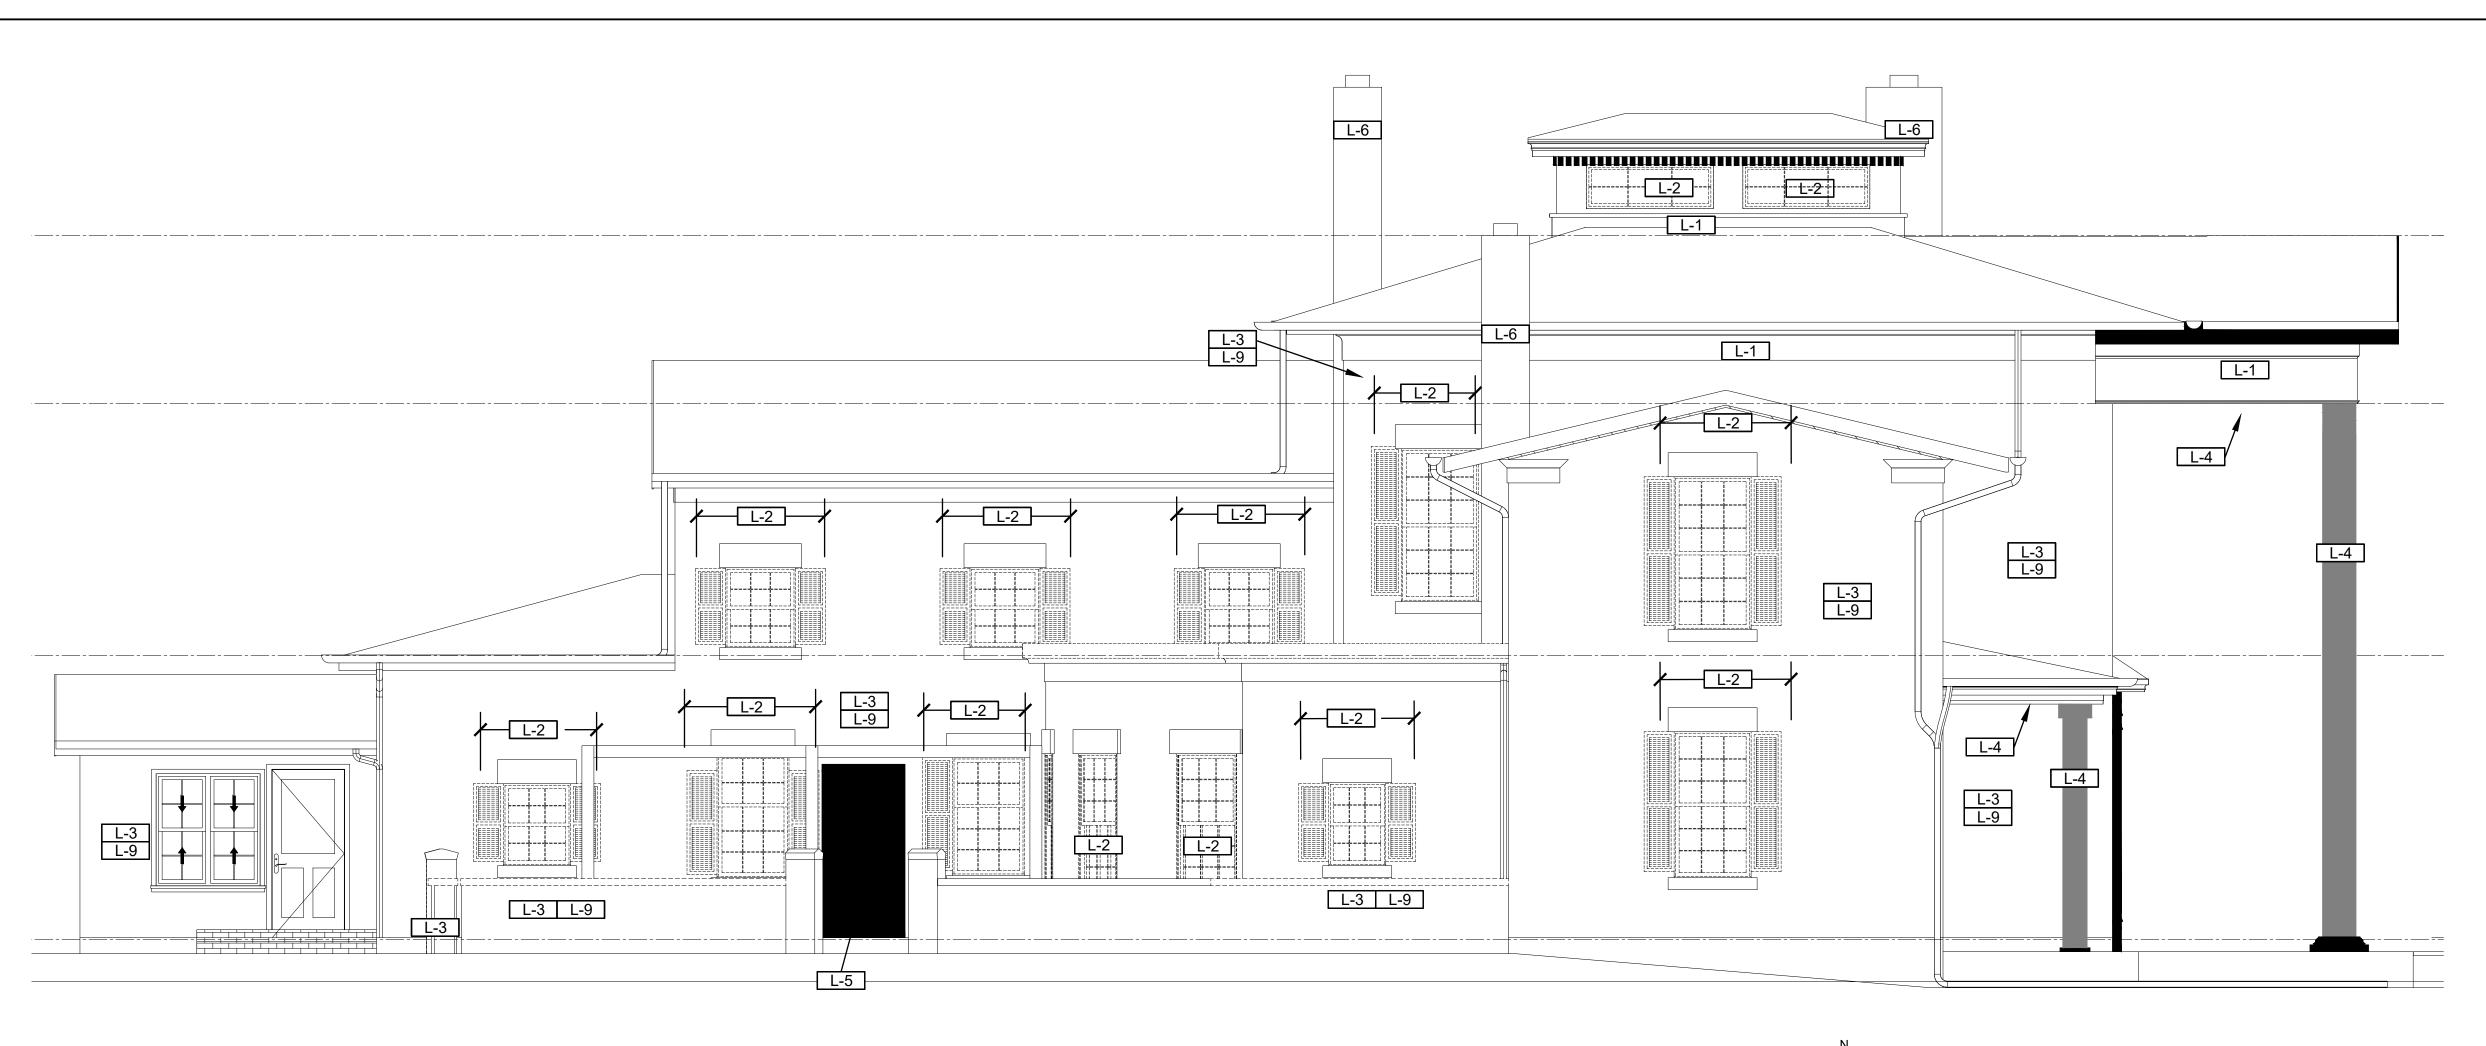
BID DOCUMENTS
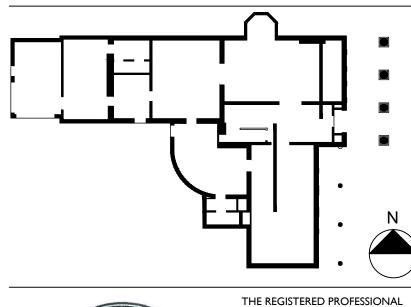
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Revision Number	Date	Description	

DRAWING ISSUED:		10/1/2024
Project Number: FBA PROJECT #00388.00	Scale: As indicated	
Drawn By: NAK	Checked By:	

Drawing Title

HAZARDOUS MATERIALS **EAST ELEVATION** REMOVAL PLAN





SOUTH ELEVATION - HAZARDOUS MATERIALS PLAN

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- I. PROVIDE ALL SCAFFOLDING, LIFTS, ETC. REQUIRED TO PERFORM ITS WORK.

THAT COULD DISTURB THESE MATERIALS.

- J. AN INSPECTION FOR ACM, LBP, AND PCB CAULKS HAS BEEN COMPLETED. A COPY OF THE REPORT IS INCLUDED IN THE CONTRACT DOCUMENTS. ASBESTOS CONTAINING MATERIALS IDENTIFIED IN THE REPORT ARE TO BE ABATED PRIOR TO ANY CONSTRUCTION THAT COULD DISTURB THESE MATERIALS. PRESERVE AND PROTECT BUILDING MATERIALS AND FINISHES, FACILITY EQUIPMENT, AND FURNISHINGS PRESENT WITHIN EACH WORK AREA THAT ARE NOT REMOVED, ABATED, OR SCHEDULED FOR DEMOLITION. PERFORM WORK WITHOUT DAMAGE TO OR CONTAMINATION OF ADJACENT OR NEARBY AREAS. WHERE SUCH AREAS ARE DAMAGED, PROVIDE FOR RESTORATION TO THE SATISFACTION OF THE OWNER. WHERE SUCH AREAS ARE CONTAMINATED, PROVIDE FOR REQUISITE CONTAINMENT AND CLEANUP.
- K. ALL REMOVED PAINT, CHIPS, UNDERLYING SUBSTRATES AND ASSOCIATED DEBRIS SHALL BE PROPERLY DISPOSED OF IN ACCORDANCE WITH SECTION 028333: REMOVAL OF LEAD-CONTAINING MATERIAL. LOOSE PAINT FLAKES SHALL BE SEGREGATED, COLLECTED FOR TESTING AND DISPOSAL PER THE SPECIFICATION. FOR BIDDING, PAINT CHIPS, AND ASSOCIATED DEBRIS ARE ASSUMED TO BE DISPOSED AS RCRA HAZARDOUS WASTE AT AN APPROPRIATE LANDFILL IMMEDIATELY FOLLOWING PROJECT COMPLETION WITH PROPER WASTE MANIFESTS.
- L. ANTICIPATE 75% OF PAINT WILL REQUIRE REMOVAL FROM IDENTIFIED COMPONENTS FOR BIDDING PURPOSES.

LEAD AWARENESS NOTES

- 1. CONDUCT ALL WORK IN ACCORDANCE WITH APPLICABLE FEDERAL, STATE, AND LOCAL REQUIREMENTS, INCLUDING OSHA 29 CFR 1926.62: LEAD EXPOSURE IN CONSTRUCTION: INTERIM FINAL RULE AND 40 CFR SUBPART E (EPA RRP RULE) FOR ALL ACTIVITIES DURING WHICH AN EMPLOYEE MAY BE OCCUPATIONALLY EXPOSED TO LEAD. ALL CONTRACTORS SHALL ENSURE THAT THEIR EMPLOYEES WEAR PROPER PERSONAL PROTECTIVE EQUIPMENT AND/OR UTILIZE APPROPRIATE WORK METHODS TO PREVENT ELEVATED BLOOD LEAD LEVELS OR EXPOSURE ABOVE THE PERMISSIBLE EXPOSURE LIMIT. DISPOSAL OF GENERATED PAINT CHIPS SHALL BE IN COMPLIANCE WITH ALL APPLICABLE FEDERAL AND STATE REGULATIONS REGARDING LEAD.
- 2. FURNISHING THIS INFORMATION IS NOT INTENDED TO RELIEVE THE CONTRACTOR OF ITS RESPONSIBILITIES UNDER OSHA TO DETERMINE IF THEIR EMPLOYEES AND SUBCONTRACTORS MAY BE EXPOSED TO LEAD AND TO WARN THEIR EMPLOYEES OF THE POTENTIAL DANGERS OF THE DISTURBANCE OF LEAD-CONTAINING MATERIALS.
- BASED ON THE TESTING, THE FOLLOWING COMPONENTS HAVE BEEN IDENTIFIED TO BE COATED/CONTAIN LEAD-BASED PAINT:


LANFORD HOUSE

- EXTERIOR WALLS
- PLUMBING VENT BOOT
- CHIMNEY
- PORCH OVERHANG
- COLUMNS
- WINDOWS
- WINDOW FRAMES
- WINDOW CASINGS SHUTTERS

SOFFIT

- DETACHED GARAGE SIDING
- WINDOWS WINDOW FRAMES
- WINDOW CASINGS
- OVERHEAD DOORS
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PROJECT NO. 051037 LANFORD REHAB PHASE II EXTERIOR

194 CENTRAL AVENUE FREDONIA, NEW YORK 14063

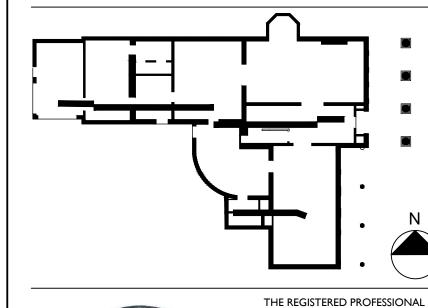
BID DOCUMENTS

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Revision Number	Date	Description	

DRAWING ISSUED:		10/1/2024
Project Number: FBA PROJECT #00388.00	Scale: As indicated	
Drawn By:	Checked By:	

Drawing Title

HAZARDOUS MATERIALS SOUTH ELEVATION REMOVAL PLAN

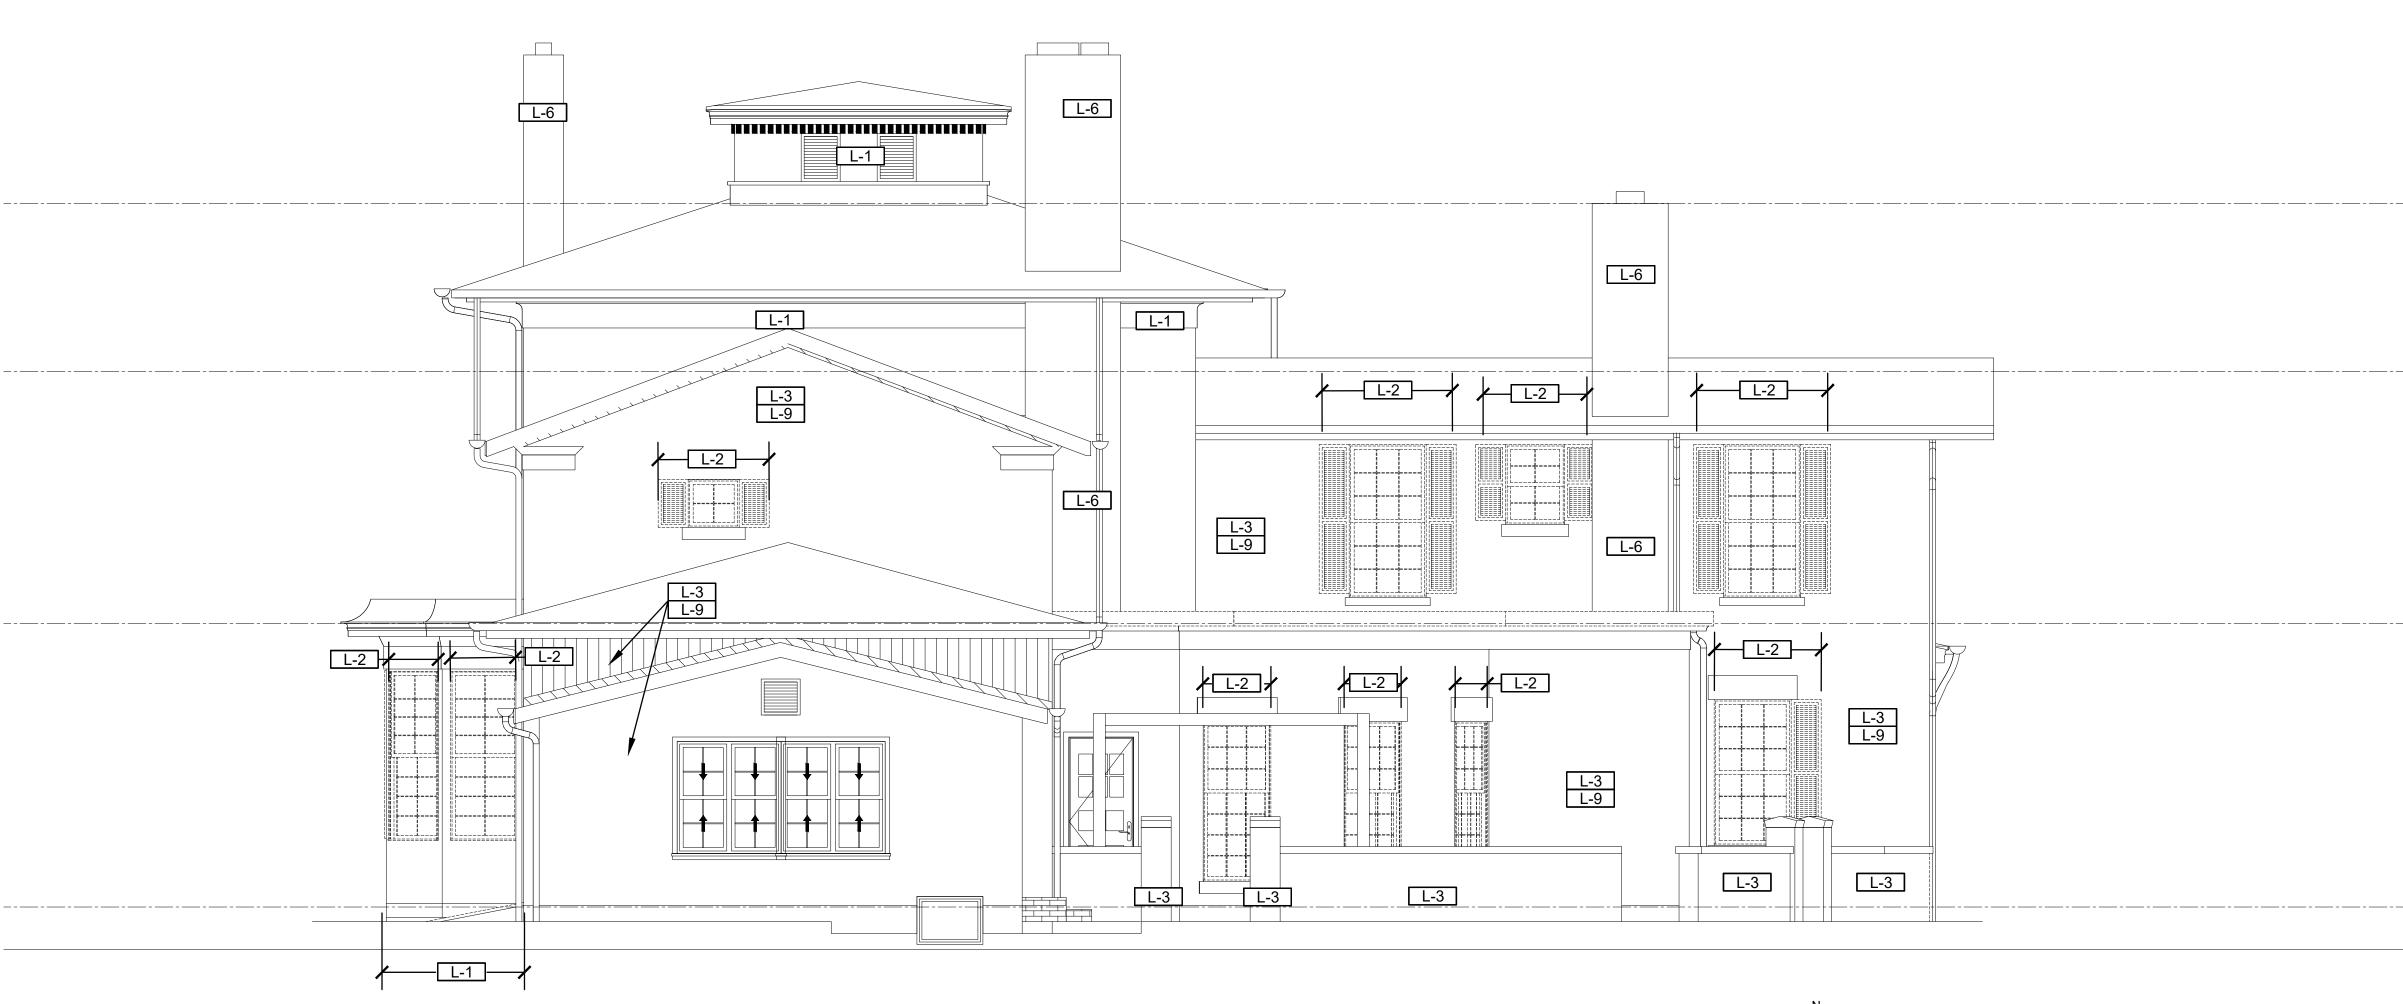



WEST ELEVATION - HAZARDOUS MATERIALS PLAN

SCALE: 1/4" = 1'-0"

LEAD-BASED PAINT ABATEMENT NOTES

ALL LOOSE PAINT SHALL BE REMOVED IN IDENTIFIED AREAS DOWN TO AN INTACT SURFACE IN PREPARATION FOR REPAINTING. REFER TO ARCHITECTURAL DRAWINGS AND SPECIFICATIONS FOR SURFACE PREPARATION REQUIREMENTS. COORDINATE ALL WORK WITH PAINTING/GENERAL CONTRACTOR. ALL REMOVED PAINT, PAINTED COMPONENTS SCHEDULED FOR DISPOSAL AND ASSOCIATED DEBRIS SHALL BE DISPOSED OF IN ACCORDANCE WITH GENERAL NOTE K.

- L-1 REMOVE EXISTING LEAD-BASED PAINT AT WOOD SIDING, SOFFIT AND TRIM. REFER TO ARCHITECTURAL DEMOLITION DRAWINGS, AND SPECIFIC DEMOLITION NOTE 2 FOR REMOVAL PROCEDURE REQUIREMENTS. REMOVE DAMAGED SIDING AND TRIM SCHEDULED FOR DEMOLITION. REFER TO ARCHITECTURAL NEW WORK ELEVATIONS FOR LOCATIONS. COORDINATE WORK WITH CARPENTER TASKED WITH WOOD COMPONENT REPLACEMENT.
- L-2 REMOVE EXISTING LOOSE LEAD-BASED PAINT AT WINDOW FRAMES. REMOVE AND PROPERLY DISPOSE OF SCREENS AND WINDOW SASHES COATED WITH LEAD-BASED PAINT. DETACH SHUTTERS AND PROPERLY DISPOSE. REMOVE EXISTING LOOSE LEAD-BASED PAINT FROM WALL SURFACE BENEATH DOWN TO AN
- L-3 REMOVE EXISTING LOOSE LEAD-BASED PAINT AT BRICK. ALL REMOVED PAINT AND ASSOCIATED DEBRIS SHALL BE DISPOSED OF IN ACCORDANCE WITH GENERAL NOTE K.
- L-4 NOT USED.
- L-5 NOT USED.
- L-6 REMOVE ALL LEAD-BASED PAINT DOWN TO AND FROM BRICK SUBSTRATE ON ALL CHIMNEYS. PROTECT BRICK DURING REMOVAL ACTIVITIES.
- L-7 NOT USED.
- L-8 NOT USED.

ALTERNATE 1

L-9 REMOVE ALL LEAD BASED PAINT FROM BRICK SUBSTRATE.

GENERAL NOTES

- A. PERFORM ALL WORK IN ACCORDANCE WITH ALL APPLICABLE LOCAL, STATE, AND FEDERAL RULES, REGULATIONS, AND GUIDELINES, VARIANCES AND CONTRACT DOCUMENTS.
- B. ALL MATERIAL MEASUREMENTS AND/OR QUANTITIES AND LOCATIONS ARE APPROXIMATE AND FOR GENERAL ORIENTATION ONLY. CONTRACTOR IS RESPONSIBLE FOR FIELD VERIFICATION AT THE SITE PRIOR TO BIDDING.
- C. THE LOCATION OF ANY STORAGE OF MATERIAL, EQUIPMENT, AND WASTE TRAILER/DUMPSTER SHALL BE COORDINATED WITH AND APPROVED BY THE OWNER OR THE OWNER'S
- D. SECURE ALL TOOLS, EQUIPMENT, AND SUPPLIES. THE OWNER OR THE OWNER'S REPRESENTATIVE WILL NOT BE LIABLE FOR THEFT OR DAMAGE.
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- H. PROTECT ALL FINISHES SCHEDULED TO REMAIN. CONTRACTOR IS RESPONSIBLE FOR ALL DAMAGE TO FINISHES.
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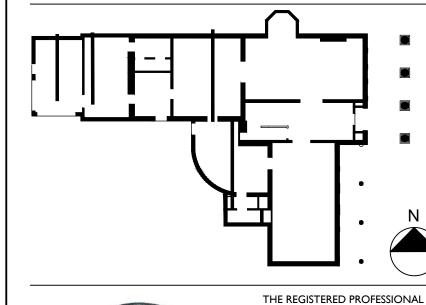
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- 3. BASED ON THE TESTING, THE FOLLOWING COMPONENTS HAVE BEEN IDENTIFIED TO BE COATED/CONTAIN LEAD-BASED PAINT:

LANFORD HOUSE

- EXTERIOR WALLS
- PLUMBING VENT BOOT CHIMNEY
- PORCH OVERHANG
- COLUMNS
- WINDOWS
- WINDOW FRAMES
- WINDOW CASINGS SHUTTERS
- SOFFIT
- **DETACHED GARAGE** SIDING
- WINDOWS
- WINDOW FRAMES WINDOW CASINGS
- OVERHEAD DOORS
- OVERHEAD DOOR FRAMES
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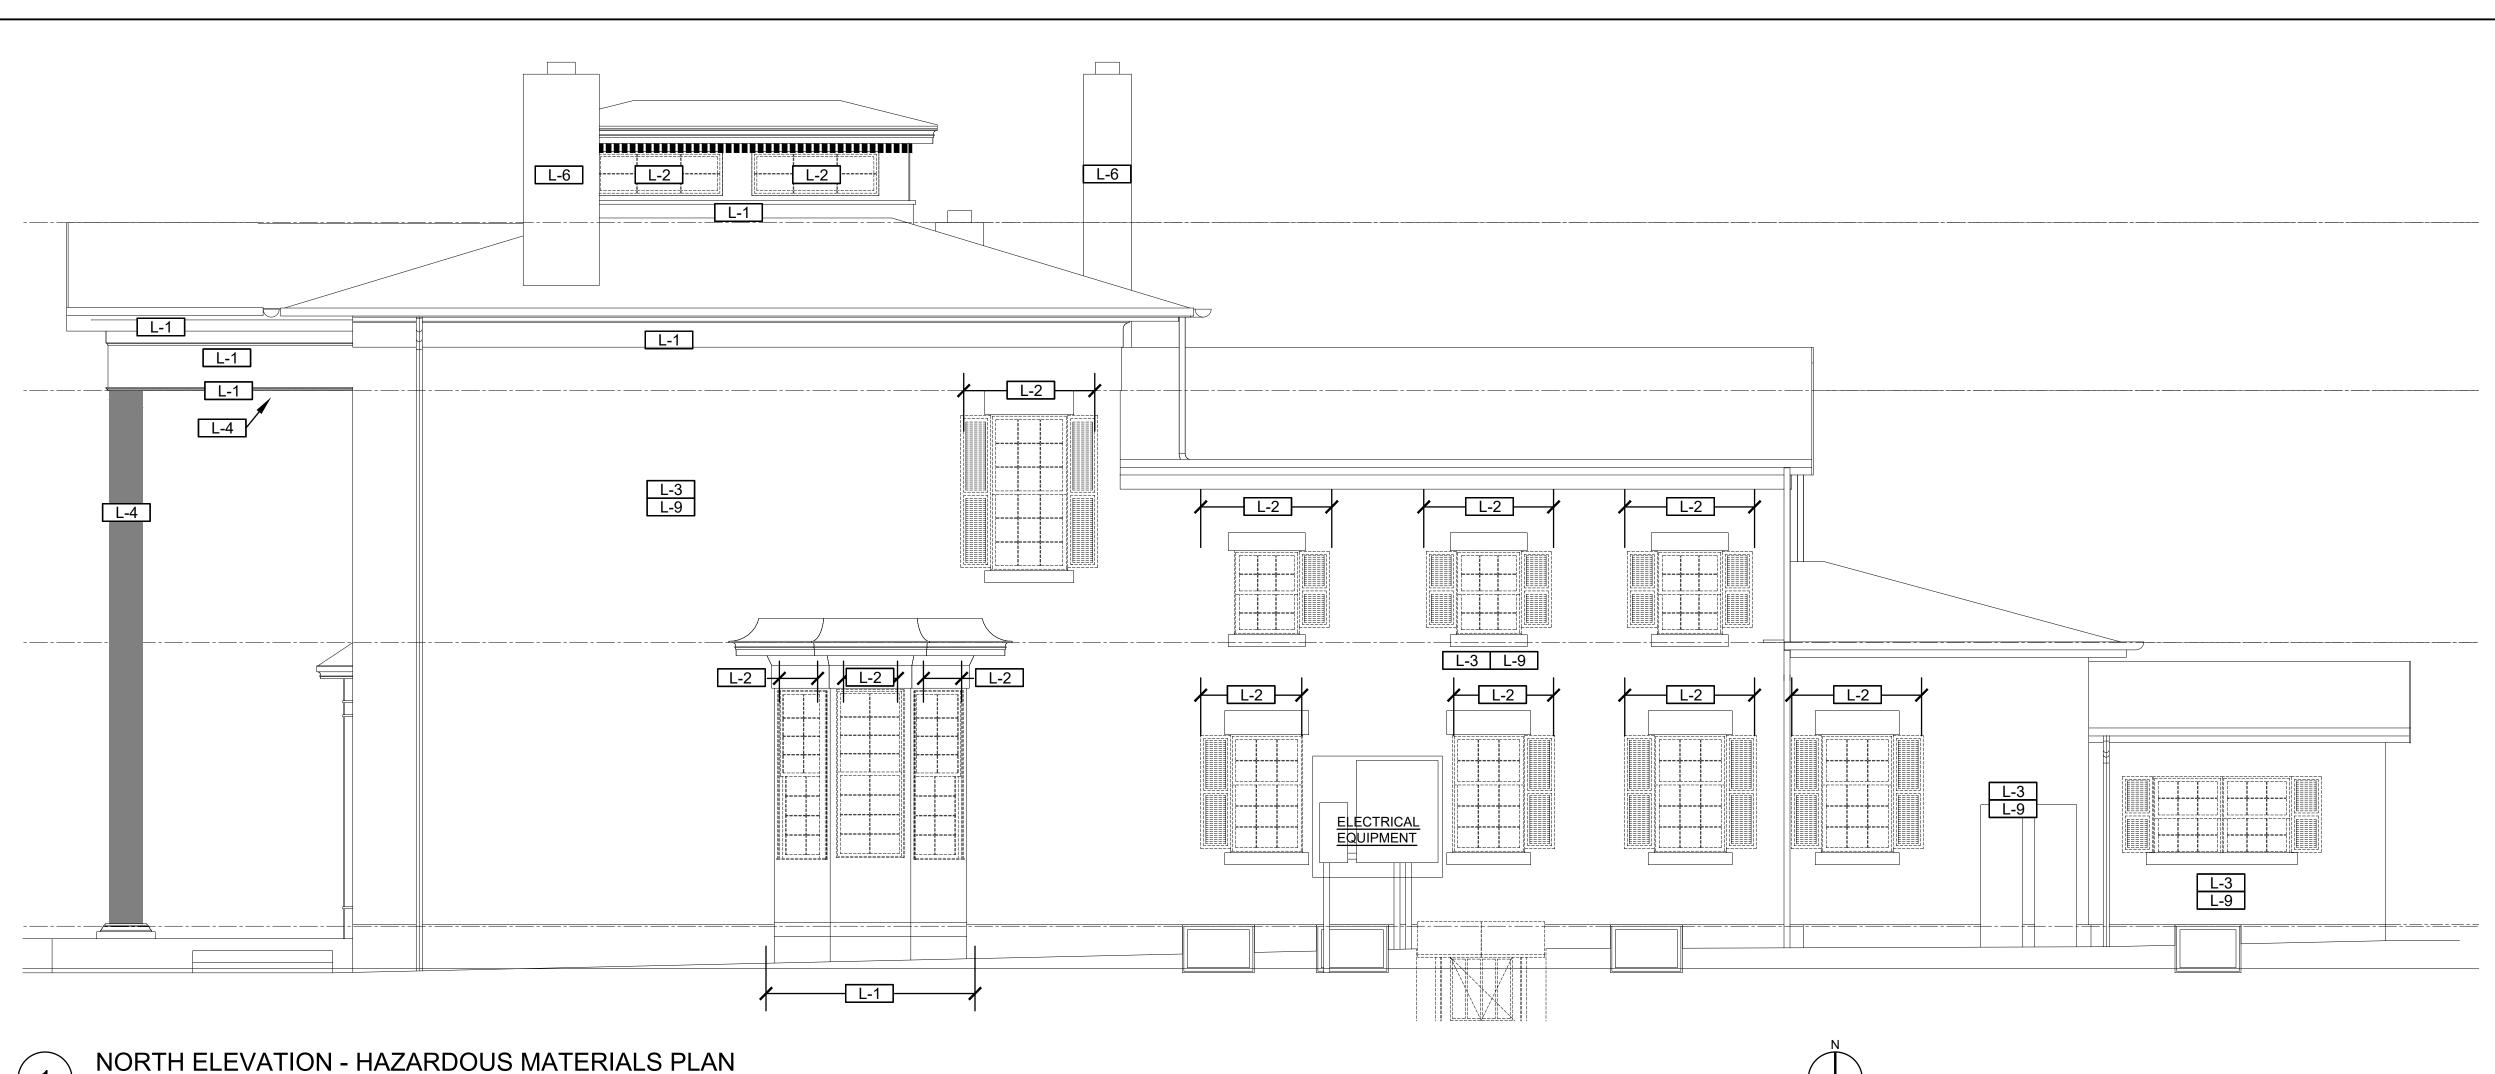
BID DOCUMENTS

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Revision Number	Date	Description	

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Project Number: FBA PROJECT #00388.00	Scale: As indicated	
Drawn By: NAK	Checked By:	

Drawing Title

HAZARDOUS MATERIALS WEST ELEVATION REMOVAL PLAN



SCALE: 1/4" = 1'-0"

LEAD-BASED PAINT ABATEMENT NOTES

ALL LOOSE PAINT SHALL BE REMOVED IN IDENTIFIED AREAS DOWN TO AN INTACT SURFACE IN PREPARATION FOR REPAINTING. REFER TO ARCHITECTURAL DRAWINGS AND SPECIFICATIONS FOR SURFACE PREPARATION REQUIREMENTS. COORDINATE ALL WORK WITH PAINTING/GENERAL CONTRACTOR. ALL REMOVED PAINT, PAINTED COMPONENTS SCHEDULED FOR DISPOSAL AND ASSOCIATED DEBRIS SHALL BE DISPOSED OF IN ACCORDANCE WITH GENERAL NOTE K.

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- L-3 REMOVE EXISTING LOOSE LEAD-BASED PAINT AT BRICK. ALL REMOVED PAINT AND ASSOCIATED DEBRIS SHALL BE DISPOSED OF IN ACCORDANCE WITH GENERAL NOTE K.
- L-4 REMOVE EXISTING LOOSE LEAD-BASED PAINT AT PORCH CEILING, ASSOCIATED WOOD TRIM AND PORCH COLUMNS/CAPITALS.
- L-5 NOT USED.

INTACT SURFACE.

- L-6 REMOVE ALL LEAD-BASED PAINT DOWN TO AND FROM BRICK SUBSTRATE ON ALL CHIMNEYS. PROTECT BRICK DURING REMOVAL ACTIVITIES.
- L-7 NOT USED.
- L-8 NOT USED.

ALTERNATE 1

L-9 REMOVE ALL LEAD BASED PAINT FROM BRICK SUBSTRATE.

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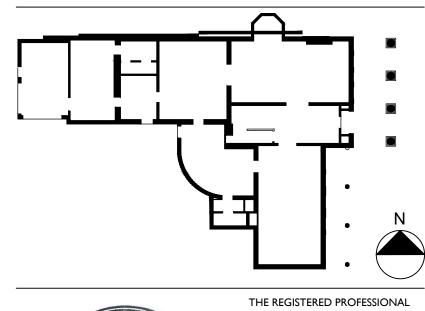
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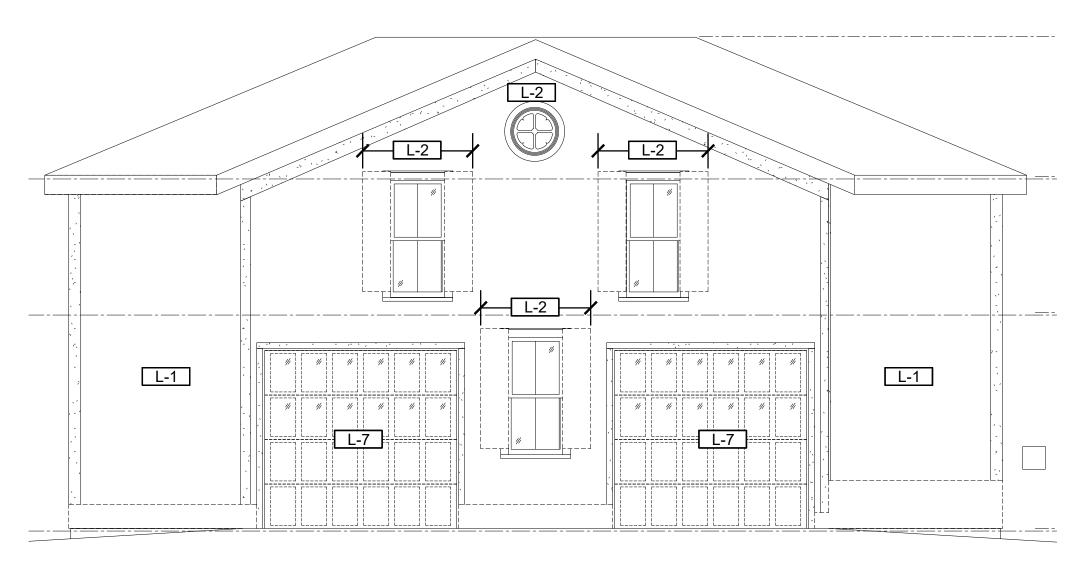
DRAWING ISSUED:		10/1/2024
Project Number: FBA PROJECT #00388.00	Scale: As indicated	
Drawn By: NAK	Checked By:	

Drawing Title

HAZARDOUS MATERIALS NORTH ELEVATION REMOVAL PLAN

Drawing Number

HM-04



EAST ELEVATION - HAZARDOUS MATERIALS PLAN

WEST ELEVATION - HAZARDOUS MATERIALS PLAN

SCALE: 1/4" = 1'-0"

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L-1 REMOVE EXISTING LEAD-BASED PAINT AT WOOD SIDING, SOFFIT AND TRIM. REFER TO ARCHITECTURAL DEMOLITION DRAWINGS, AND SPECIFIC DEMOLITION NOTE 2 FOR REMOVAL PROCEDURE REQUIREMENTS. REMOVE DAMAGED SIDING AND TRIM SCHEDULED FOR DEMOLITION. REFER TO ARCHITECTURAL NEW WORK ELEVATIONS FOR LOCATIONS. COORDINATE WORK WITH CARPENTER TASKED WITH WOOD COMPONENT REPLACEMENT.

L-2 NOT USED.

L-3 NOT USED.

L-4 NOT USED.

L-5 NOT USED.

L-6 NOT USED.

L-7 REMOVE EXISTING LOOSE LEAD-BASED PAINT AT OVERHEAD DOOR AND ASSOCIATED WOOD TRIM. REMOVE ALL PAINT DOWN TO AN INTACT SURFACE. ENCAPSULATE ANY PAINT WHICH IS INTACT AND SHALL REMAIN AND PREPARE FOR A NEW SURFACE. ALL REMOVED PAINT AND ASSOCIATED DEBRIS SHALL BE DISPOSED OF IN ACCORDANCE WITH GENERAL NOTE K.


L-8 REMOVE EXISTING LOOSE LEAD-BASED PAINT AT WINDOW FRAMES DOWN TO AN INTACT SURFACE. CAREFULLY REMOVE WINDOW SASHES COATED WITH LEAD-BASED PAINT. DETACH SHUTTERS AND REMOVE EXISTING LOOSE LEAD-BASED PAINT FROM SHUTTERS AND WALL SURFACE BENEATH DOWN TO AN INTACT SURFACE. WINDOW SASHES FOR REINSTALLATION UPON REPAINTING.

ALTERNATE 1

L-9 REMOVE ALL LEAD BASED PAINT FROM BRICK SUBSTRATE.



SOUTH ELEVATION - HAZARDOUS MATERIALS PLAN

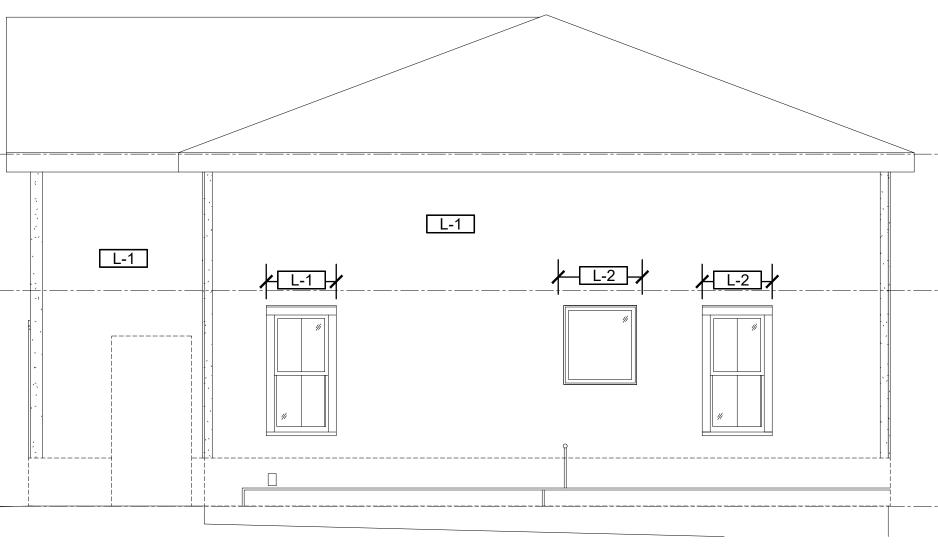

NORTH ELEVATION - HAZARDOUS MATERIALS PLAN

GENERAL NOTES

ANY TIME.

- A. PERFORM ALL WORK IN ACCORDANCE WITH ALL APPLICABLE LOCAL, STATE, AND FEDERAL RULES, REGULATIONS, AND GUIDELINES, VARIANCES AND CONTRACT DOCUMENTS.
- B. ALL MATERIAL MEASUREMENTS AND/OR QUANTITIES AND LOCATIONS ARE APPROXIMATE AND FOR GENERAL ORIENTATION ONLY. CONTRACTOR IS RESPONSIBLE FOR FIELD VERIFICATION AT THE SITE PRIOR TO BIDDING.
- C. THE LOCATION OF ANY STORAGE OF MATERIAL, EQUIPMENT, AND WASTE TRAILER/DUMPSTER SHALL BE COORDINATED WITH AND APPROVED BY THE OWNER OR THE OWNER'S
- D. SECURE ALL TOOLS, EQUIPMENT, AND SUPPLIES. THE OWNER OR THE OWNER'S REPRESENTATIVE WILL NOT BE LIABLE FOR THEFT OR DAMAGE.
- E. LEAD-BASED PAINT IDENTIFIED IN THE REPORT IS TO BE ABATED PRIOR TO ANY CONSTRUCTION THAT COULD DISTURB THESE MATERIALS.
- F. KEEP THE WORK AREA IN A CLEAN AND SAFE CONDITION. CONTRACTOR SHALL ENSURE THAT UNCERTIFIED PERSONNEL OR UNAUTHORIZED VISITORS DO NOT ENTER ACTIVE WORK AREAS AT
- G. PROVIDE TEMPORARY PROTECTION TO KEEP THE WORK AREAS AND BUILDING IN A SECURE AND WATERTIGHT CONDITION AT ALL TIMES DURING THE PERFORMANCE OF THE CONTRACT WORK. THE CONTRACTOR SHALL BE RESPONSIBLE FOR ANY DAMAGE CAUSED TO ANY AREAS OF THE BUILDING AS A RESULT OF IMPROPER TEMPORARY PROTECTION.
- H. PROTECT ALL FINISHES SCHEDULED TO REMAIN. CONTRACTOR IS RESPONSIBLE FOR ALL DAMAGE TO FINISHES.
- I. PROVIDE ALL SCAFFOLDING, LIFTS, ETC. REQUIRED TO PERFORM ITS WORK.
- J. AN INSPECTION FOR ACM, LBP, AND PCB CAULKS HAS BEEN COMPLETED. A COPY OF THE REPORT IS INCLUDED IN THE CONTRACT DOCUMENTS. ASBESTOS CONTAINING MATERIALS IDENTIFIED IN THE REPORT ARE TO BE ABATED PRIOR TO ANY CONSTRUCTION THAT COULD DISTURB THESE MATERIALS. PRESERVE AND PROTECT BUILDING MATERIALS AND FINISHES, FACILITY EQUIPMENT, AND FURNISHINGS PRESENT WITHIN EACH WORK AREA THAT ARE NOT REMOVED, ABATED, OR SCHEDULED FOR DEMOLITION. PERFORM WORK WITHOUT DAMAGE TO OR CONTAMINATION OF ADJACENT OR NEARBY AREAS. WHERE SUCH AREAS ARE DAMAGED, PROVIDE FOR RESTORATION TO THE SATISFACTION OF THE OWNER. WHERE SUCH AREAS ARE CONTAMINATED, PROVIDE FOR REQUISITE CONTAINMENT AND CLEANUP.
- K. ALL REMOVED PAINT, CHIPS, UNDERLYING SUBSTRATES AND ASSOCIATED DEBRIS SHALL BE PROPERLY DISPOSED OF IN ACCORDANCE WITH SECTION 028333: REMOVAL OF LEAD-CONTAINING MATERIAL. LOOSE PAINT FLAKES SHALL BE SEGREGATED, COLLECTED FOR TESTING AND DISPOSAL PER THE SPECIFICATION. FOR BIDDING, PAINT CHIPS, AND ASSOCIATED DEBRIS ARE ASSUMED TO BE DISPOSED AS RCRA HAZARDOUS WASTE AT AN APPROPRIATE LANDFILL IMMEDIATELY FOLLOWING PROJECT COMPLETION WITH PROPER WASTE MANIFESTS.
- L. ANTICIPATE 75% OF PAINT WILL REQUIRE REMOVAL FROM IDENTIFIED COMPONENTS FOR BIDDING PURPOSES.

LEAD AWARENESS NOTES

- 1. CONDUCT ALL WORK IN ACCORDANCE WITH APPLICABLE FEDERAL, STATE, AND LOCAL REQUIREMENTS, INCLUDING OSHA 29 CFR 1926.62: LEAD EXPOSURE IN CONSTRUCTION: INTERIM FINAL RULE AND 40 CFR SUBPART E (EPA RRP RULE) FOR ALL ACTIVITIES DURING WHICH AN EMPLOYEE MAY BE OCCUPATIONALLY EXPOSED TO LEAD. ALL CONTRACTORS SHALL ENSURE THAT THEIR EMPLOYEES WEAR PROPER PERSONAL PROTECTIVE EQUIPMENT AND/OR UTILIZE APPROPRIATE WORK METHODS TO PREVENT ELEVATED BLOOD LEAD LEVELS OR EXPOSURE ABOVE THE PERMISSIBLE EXPOSURE LIMIT. DISPOSAL OF GENERATED PAINT CHIPS SHALL BE IN COMPLIANCE WITH ALL APPLICABLE FEDERAL AND STATE REGULATIONS REGARDING LEAD.
- FURNISHING THIS INFORMATION IS NOT INTENDED TO RELIEVE THE CONTRACTOR OF ITS RESPONSIBILITIES UNDER OSHA TO DETERMINE IF THEIR EMPLOYEES AND SUBCONTRACTORS MAY BE EXPOSED TO LEAD AND TO WARN THEIR EMPLOYEES OF THE POTENTIAL DANGERS OF THE DISTURBANCE OF LEAD-CONTAINING MATERIALS.
- 3. BASED ON THE TESTING, THE FOLLOWING COMPONENTS HAVE BEEN IDENTIFIED TO BE COATED/CONTAIN LEAD-BASED PAINT:

LANFORD HOUSE


- EXTERIOR WALLS
- PLUMBING VENT BOOT
- CHIMNEY
 PORCH OVERHANG
- PORCH OVERHANGCOLUMNS
- WINDOWS
- WINDOW FRAMES
- WINDOW CASINGSSHUTTERS

SOFFIT DETACHED GARAGE

- SIDING
- WINDOWSWINDOW FRAMES
- WINDOW FRAMESWINDOW CASINGS
- OVERHEAD DOORSOVERHEAD DOOR FRAMES
- SHUTTERSSOFFIT

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THESE DOCUMENTS, SUBMITTED FOR THE SPECIFIC PROJECT NAMELY



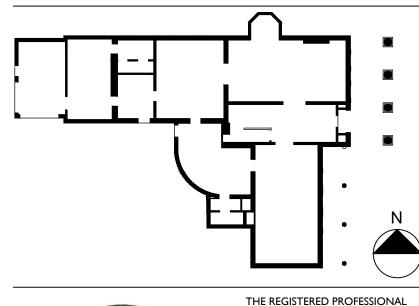

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PROJECT NO. 051037 LANFORD REHAB PHASE II EXTERIOR

194 CENTRAL AVENUE FREDONIA, NEW YORK 14063

BID DOCUMENTS

Revision Number Date D	escription


DRAWING ISSUED:		10/1/2024
Project Number: FBA PROJECT #00388.00	Scale: As indicated	
Drawn By:	Checked By:	

Drawing Title

HAZARDOUS MATERIALS REMOVAL GARAGE ELEVATIONS

Drawing Number

HM-05

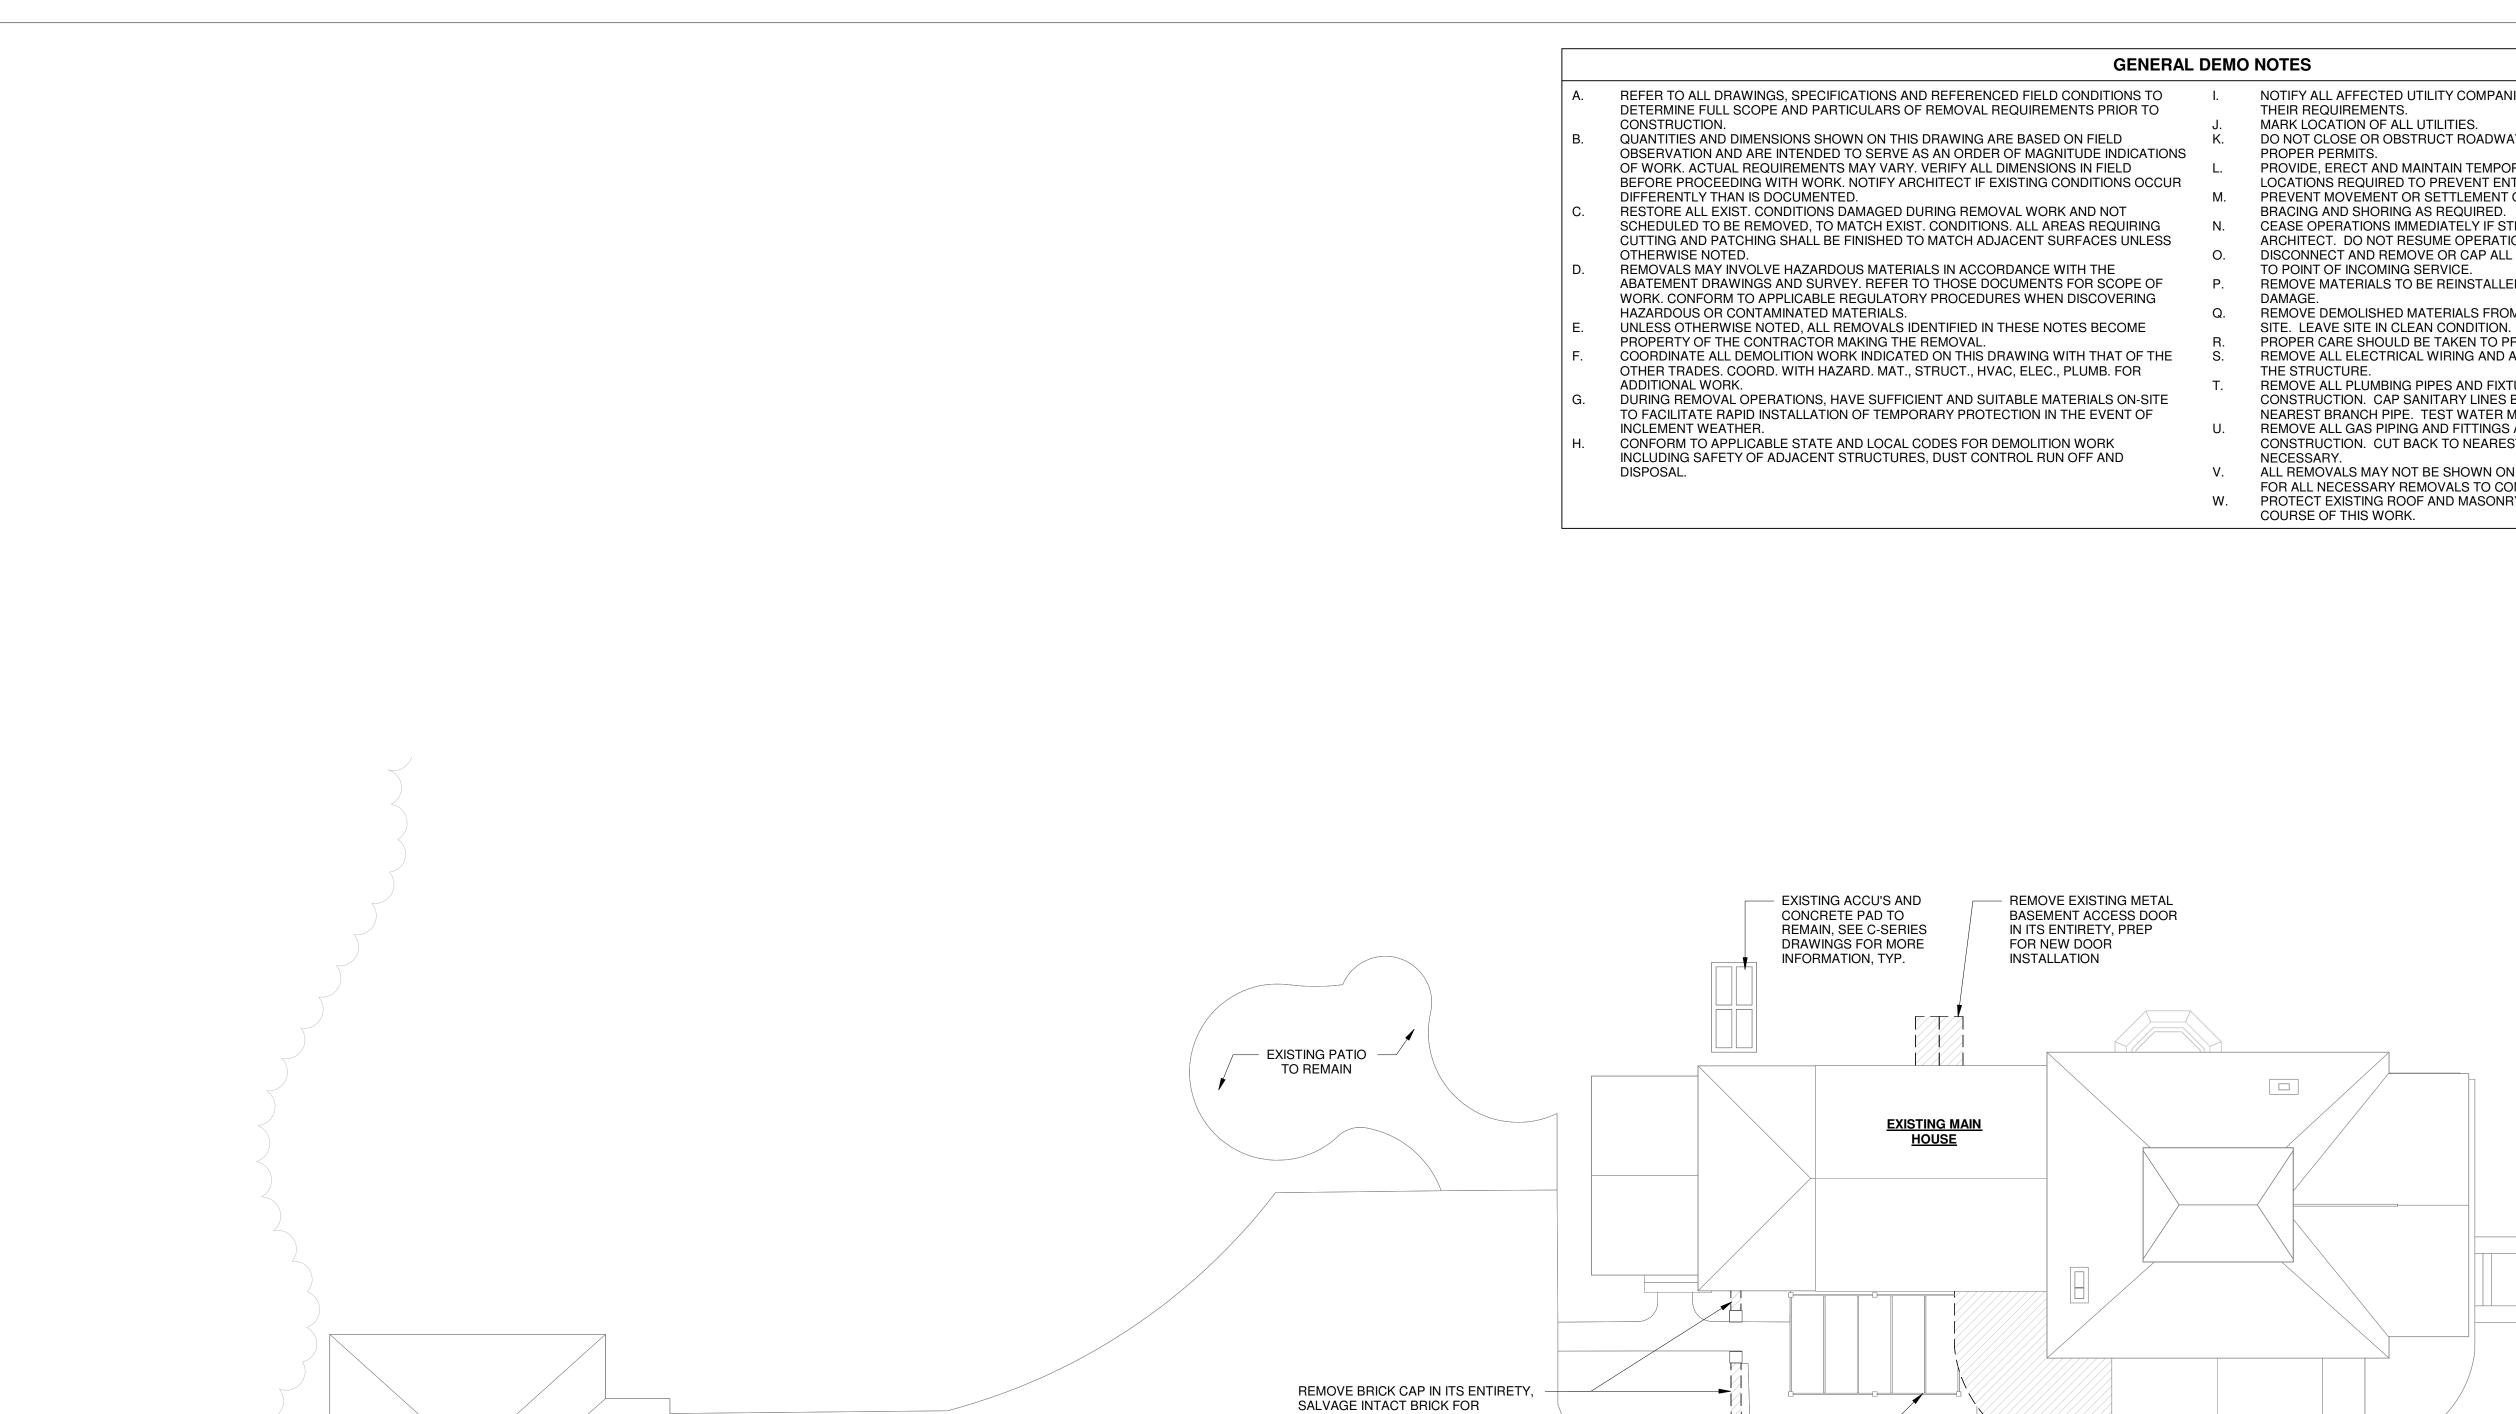

EXISTING CONCRETE

TO REMAIN, TYP.

DRIVEWAY AND PARKING

EXISTING GENERATOR AND

EXISTING GARAGE

NOTE: SEE C-SERIES DRAWINGS FOR SITE REMOVALS, PROTECTIONS, AND CONTRACTOR STAGING AREAS, TYP.

CONCRETE PAD TO

CONSTRUCTION, TYP.

REMAIN, PROTECT

THROUGHOUT

REINSTALLATION, SCRAPE ALL LOOSE

PAINT FROM THE GARDEN WALL BRICK

IN ITS ENTIRETY, TYP. U.N.O., SEE HM-

INFORMATION, TYP.

MORE INFORMATION, TYP.

SERIES AND DETAIL 3 / A4-01 FOR MORE

PROTECT SELECT PLANTS AND TREES ON

PROPERTY NEAR WORK AREAS PER C-SERIES DRAWINGS, SEE SPECIFICATION SECTION 015639

TEMPORARY TREE AND PLANT PROTECTION FOR

REMOVE BRICK CAP IN ITS ENTIRETY, SALVAGE INTACT BRICK FOR REINSTALLATION, CAREFULLY REMOVE STUCCO FROM BRICK AT THE SOUTH SIDE OF THE

GARDEN WALL IN ITS ENTIRETY, SCRAPE ALL LOOSE

PAINT FROM THE REST OF THE GARDEN WALL BRICK IN ITS ENTIRETY, TYP. U.N.O., SEE HM-SERIES AND DETAIL 1 / A4-01 FOR MORE INFORMATION, TYP.

EXISTING

REMAIN

PERGULA TO

EXISTING STAMPED

CONCRETE PATIO TO

REMAIN, TYP.

ALTERNATE #3: REMOVE EXISTING INSULATION, ALUMINUM

FASCIA/DRIP EDGE AND ROOFING

MEMBRANE IN ITS ENTIRETY

NOTIFY ALL AFFECTED UTILITY COMPANIES BEFORE STARTING WORK AND COMPLY WITH THEIR REQUIREMENTS. MARK LOCATION OF ALL UTILITIES.

> - EXISTING CONCRETE DRIVEWAY TO REMAIN, TYP.

DO NOT CLOSE OR OBSTRUCT ROADWAYS, SIDEWALKS OR HYDRANTS WITHOUT PROPER PERMITS. PROVIDE, ERECT AND MAINTAIN TEMPORARY BARRIERS AND SECURITY DEVICES AT

LOCATIONS REQUIRED TO PREVENT ENTRANCE TO WORK AREA. PREVENT MOVEMENT OR SETTLEMENT OF STRUCTURAL COMPONENTS. PROVIDE

BRACING AND SHORING AS REQUIRED. CEASE OPERATIONS IMMEDIATELY IF STRUCTURE APPEARS TO BE IN DANGER, NOTIFY

ARCHITECT. DO NOT RESUME OPERATIONS UNTIL DIRECTED. DISCONNECT AND REMOVE OR CAP ALL EXISTING UTILITIES WITHIN BUILDING SOURCE TO POINT OF INCOMING SERVICE.

REMOVE MATERIALS TO BE REINSTALLED OR RETAINED IN A MANNER TO PREVENT REMOVE DEMOLISHED MATERIALS FROM SITE. DO NOT BURN OR BURY MATERIALS ON

PROPER CARE SHOULD BE TAKEN TO PROVIDE PROPER BRACING OF THE STRUCTURE. REMOVE ALL ELECTRICAL WIRING AND APPURTENANCES IN DEMO WALLS THROUGHOUT

REMOVE ALL PLUMBING PIPES AND FIXTURES AS REQUIRED BY DEMOLITION AND NEW CONSTRUCTION. CAP SANITARY LINES BELOW SLAB, CUT SUPPLY LINES BACK TO NEAREST BRANCH PIPE. TEST WATER METER, REPLACE IF NECESSARY.

REMOVE ALL GAS PIPING AND FITTINGS AS REQUIRED BY DEMOLITION AND NEW CONSTRUCTION. CUT BACK TO NEAREST BRANCH PIPE. TEST GAS METER, REPLACE IF


ALL REMOVALS MAY NOT BE SHOWN ON DRAWINGS. CONTRACTOR TO BE RESPONSIBLE

FOR ALL NECESSARY REMOVALS TO COMPLETE THE NEW DESIGN. PROTECT EXISTING ROOF AND MASONRY TO REMAIN AS REQUIRED THROUGHOUT

> **DEMOLITION LEGEND** - — — EXISTING TO BE REMOVED

> > EXISTING TO BE REMOVED

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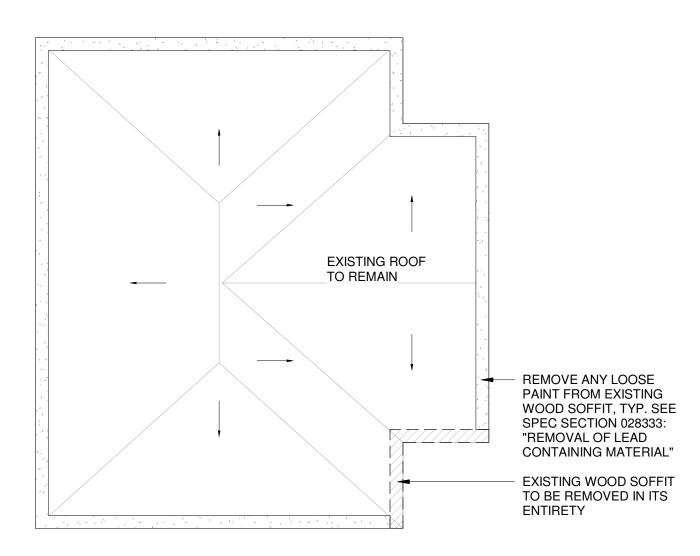
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Revision Schedule			
Revision Number	Date	Description	

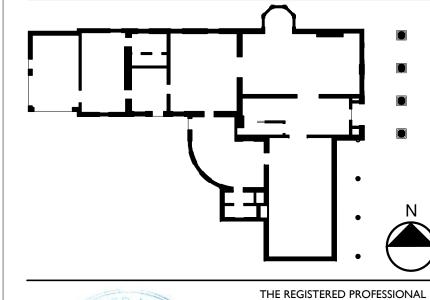
DRAWING ISSUED:		10/1/2024
Project Number: FBA PROJECT #00388.00	Scale: As indicated	
Drawn By: MNB	Checked By:	

Drawing Title

PROJECT DEMO SITE PLAN



GARAGE ROOF DEMO PLAN

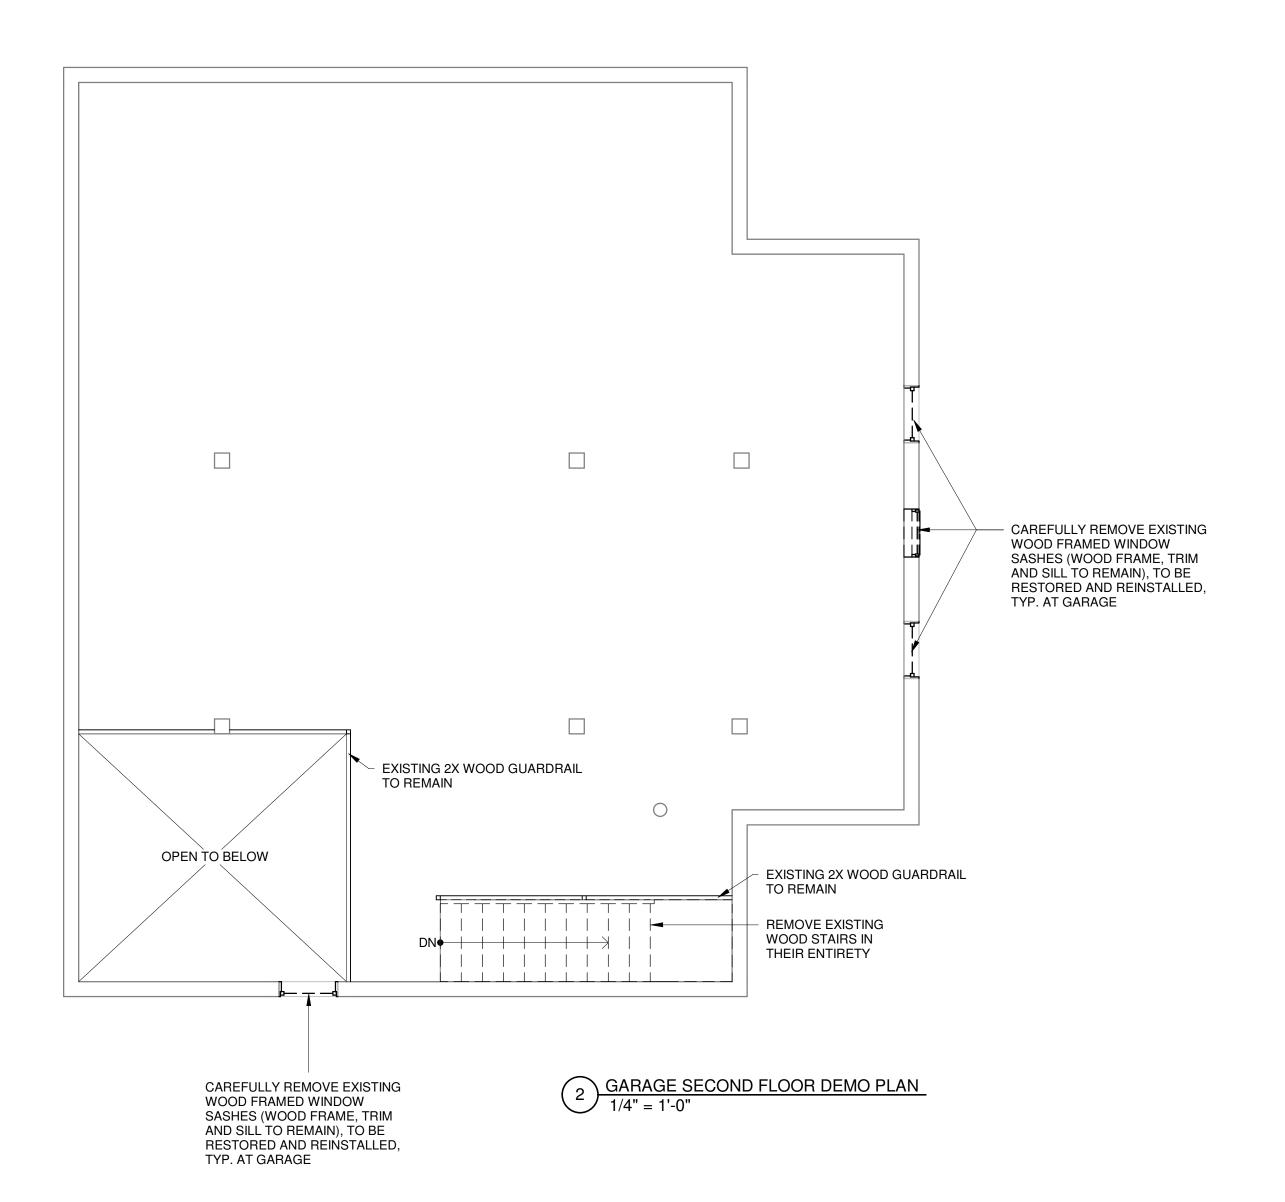

GENERAL DEMO NOTES

- A. REFER TO ALL DRAWINGS, SPECIFICATIONS AND REFERENCED FIELD CONDITIONS TO DETERMINE FULL SCOPE AND PARTICULARS OF REMOVAL REQUIREMENTS PRIOR TO CONSTRUCTION.

 B. QUANTITIES AND DIMENSIONS SHOWN ON THIS DRAWING ARE BASED ON FIELD
- OBSERVATION AND ARE INTENDED TO SERVE AS AN ORDER OF MAGNITUDE INDICATIONS OF WORK. ACTUAL REQUIREMENTS MAY VARY. VERIFY ALL DIMENSIONS IN FIELD BEFORE PROCEEDING WITH WORK. NOTIFY ARCHITECT IF EXISTING CONDITIONS OCCUR DIFFERENTLY THAN IS DOCUMENTED.
 RESTORE ALL EXIST. CONDITIONS DAMAGED DURING REMOVAL WORK AND NOT
- SCHEDULED TO BE REMOVED, TO MATCH EXIST. CONDITIONS. ALL AREAS REQUIRING CUTTING AND PATCHING SHALL BE FINISHED TO MATCH ADJACENT SURFACES UNLESS OTHERWISE NOTED.

 REMOVALS MAY INVOLVE HAZARDOUS MATERIALS IN ACCORDANCE WITH THE
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- HAZARDOUS OR CONTAMINATED MATERIALS.

 UNLESS OTHERWISE NOTED, ALL REMOVALS IDENTIFIED IN THESE NOTES BECOME
- PROPERTY OF THE CONTRACTOR MAKING THE REMOVAL.
 COORDINATE ALL DEMOLITION WORK INDICATED ON THIS DRAWING WITH THAT OF THE
 OTHER TRADES. COORD. WITH HAZARD. MAT., STRUCT., HVAC, ELEC., PLUMB. FOR
 ADDITIONAL WORK.
- DURING REMOVAL OPERATIONS, HAVE SUFFICIENT AND SUITABLE MATERIALS ON-SITE TO FACILITATE RAPID INSTALLATION OF TEMPORARY PROTECTION IN THE EVENT OF INCLEMENT WEATHER.
- H. CONFORM TO APPLICABLE STATE AND LOCAL CODES FOR DEMOLITION WORK INCLUDING SAFETY OF ADJACENT STRUCTURES, DUST CONTROL RUN OFF AND DISPOSAL.


- NS TO I. NOTIFY ALL AFFECTED UTILITY COMPANIES BEFORE STARTING WORK AND COMPLY WITH
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 MARK LOCATION OF ALL UTILITIES.
 DO NOT CLOSE OR OBSTRUCT ROADWAYS, SIDEWALKS OR HYDRANTS WITHOUT
 - PROPER PERMITS.

 L. PROVIDE, ERECT AND MAINTAIN TEMPORARY BARRIERS AND SECURITY DEVICES AT
 - LOCATIONS REQUIRED TO PREVENT ENTRANCE TO WORK AREA.

 I. PREVENT MOVEMENT OR SETTLEMENT OF STRUCTURAL COMPONENTS. PROVIDE BRACING AND SHORING AS REQUIRED.
 - CEASE OPERATIONS IMMEDIATELY IF STRUCTURE APPEARS TO BE IN DANGER, NOTIFY ARCHITECT. DO NOT RESUME OPERATIONS UNTIL DIRECTED.
 DISCONNECT AND REMOVE OR CAP ALL EXISTING UTILITIES WITHIN BUILDING SOURCE TO POINT OF INCOMING SERVICE.
 - REMOVE MATERIALS TO BE REINSTALLED OR RETAINED IN A MANNER TO PREVENT DAMAGE.
 - REMOVE DEMOLISHED MATERIALS FROM SITE. DO NOT BURN OR BURY MATERIALS ON SITE. LEAVE SITE IN CLEAN CONDITION.
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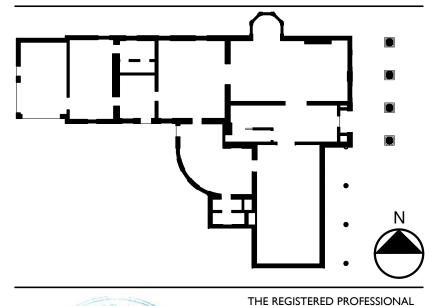
REMOVE ALL ELECTRICAL WIRING AND APPURTENANCES IN DEMO WALLS THROUGHOUT

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Revision Schedule			
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Project Number:

FBA PROJECT #00388.00
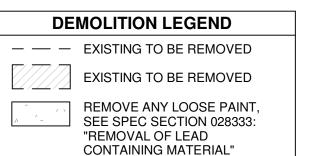
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MNB

Checked By:


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Drawing Title

GARAGE DEMO PLANS


Drawing Number

AD-01

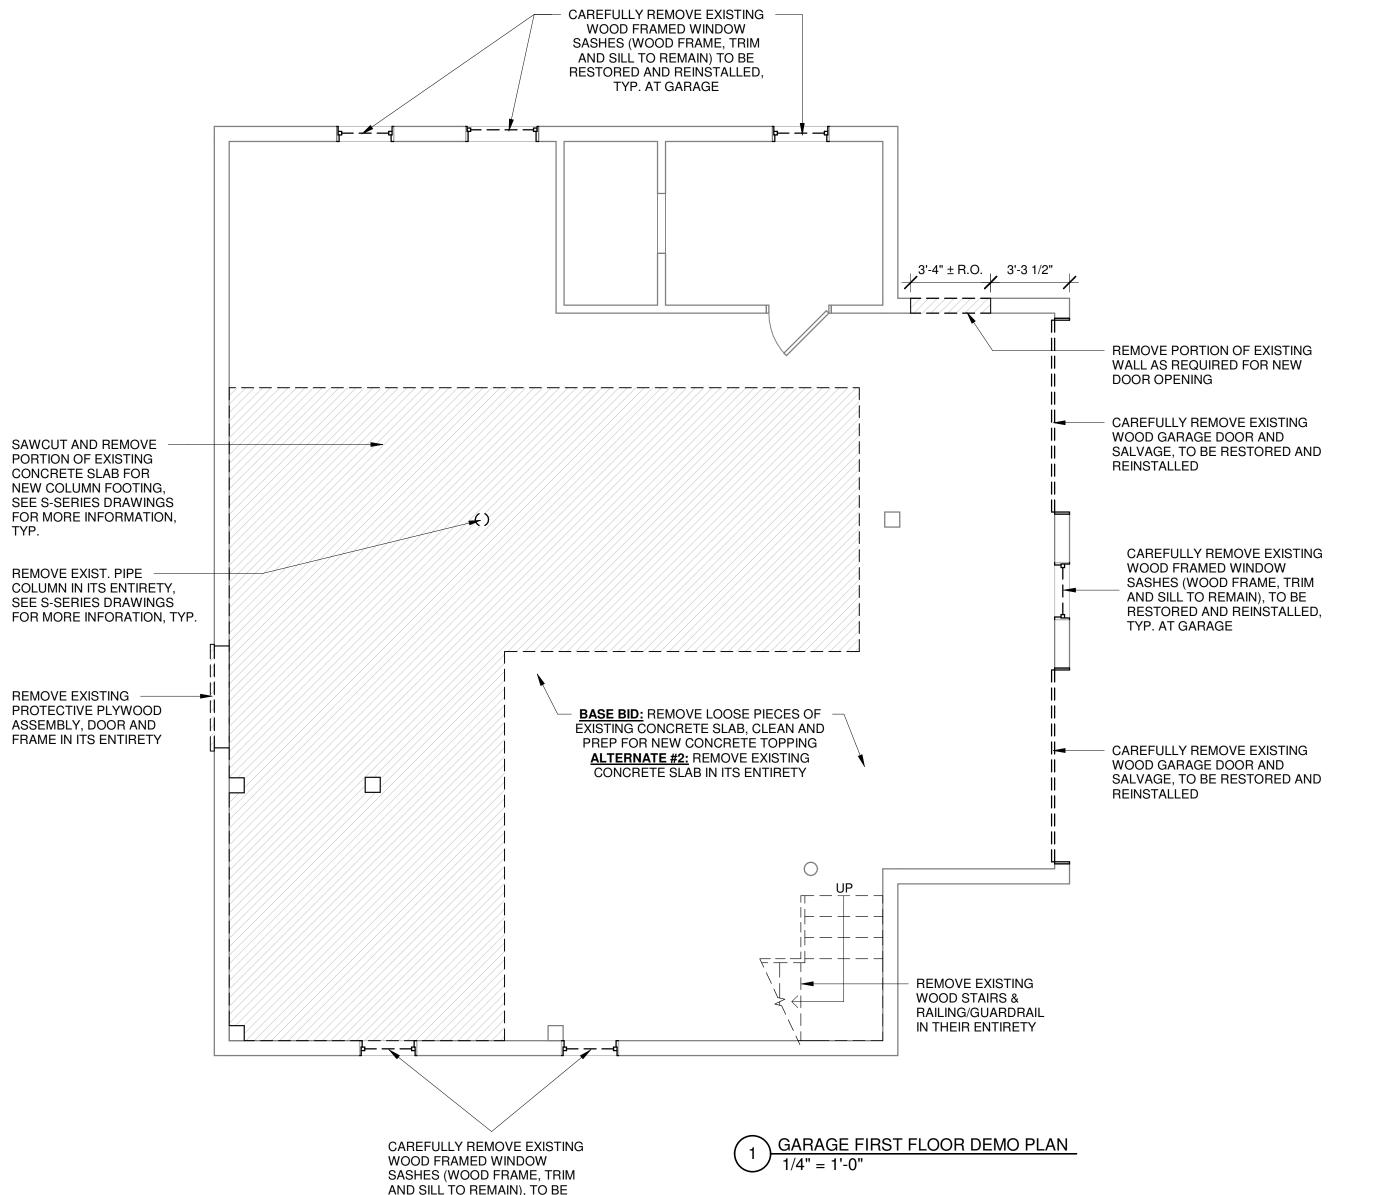

RESTORED AND REINSTALLED,

TYP. AT GARAGE

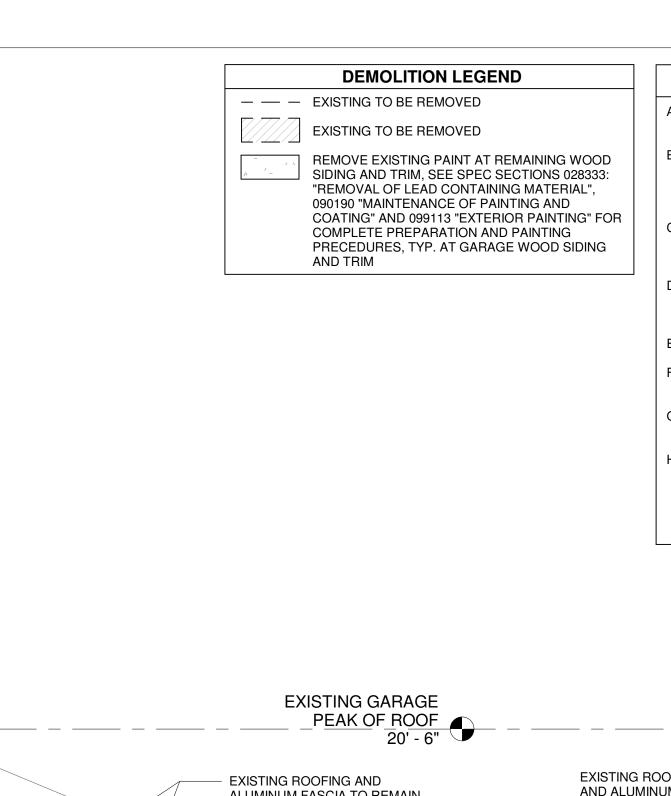

GENERAL DEMO NOTES

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CONFORM TO APPLICABLE STATE AND LOCAL CODES FOR DEMOLITION WORK INCLUDING SAFETY OF ADJACENT STRUCTURES, DUST CONTROL RUN OFF AND DISPOSAL.

NOTIFY ALL AFFECTED UTILITY COMPANIES BEFORE STARTING WORK AND COMPLY WITH THEIR REQUIREMENTS.

MARK LOCATION OF ALL UTILITIES. DO NOT CLOSE OR OBSTRUCT ROADWAYS, SIDEWALKS OR HYDRANTS WITHOUT PROPER PERMITS.

PROVIDE. ERECT AND MAINTAIN TEMPORARY BARRIERS AND SECURITY DEVICES AT LOCATIONS REQUIRED TO PREVENT ENTRANCE TO WORK AREA. PREVENT MOVEMENT OR SETTLEMENT OF STRUCTURAL COMPONENTS. PROVIDE BRACING AND SHORING AS REQUIRED.

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TO POINT OF INCOMING SERVICE. REMOVE MATERIALS TO BE REINSTALLED OR RETAINED IN A MANNER TO PREVENT

REMOVE DEMOLISHED MATERIALS FROM SITE. DO NOT BURN OR BURY MATERIALS ON


SITE. LEAVE SITE IN CLEAN CONDITION. PROPER CARE SHOULD BE TAKEN TO PROVIDE PROPER BRACING OF THE STRUCTURE. REMOVE ALL ELECTRICAL WIRING AND APPURTENANCES IN DEMO WALLS THROUGHOUT THE STRUCTURE.

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PROTECT EXISTING ROOF AND MASONRY TO REMAIN AS REQUIRED THROUGHOUT COURSE OF THIS WORK.

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PROJECT NO. 051037 LANFORD REHAB PHASE II EXTERIOR

194 CENTRAL AVENUE FREDONIA, NEW YORK 14063


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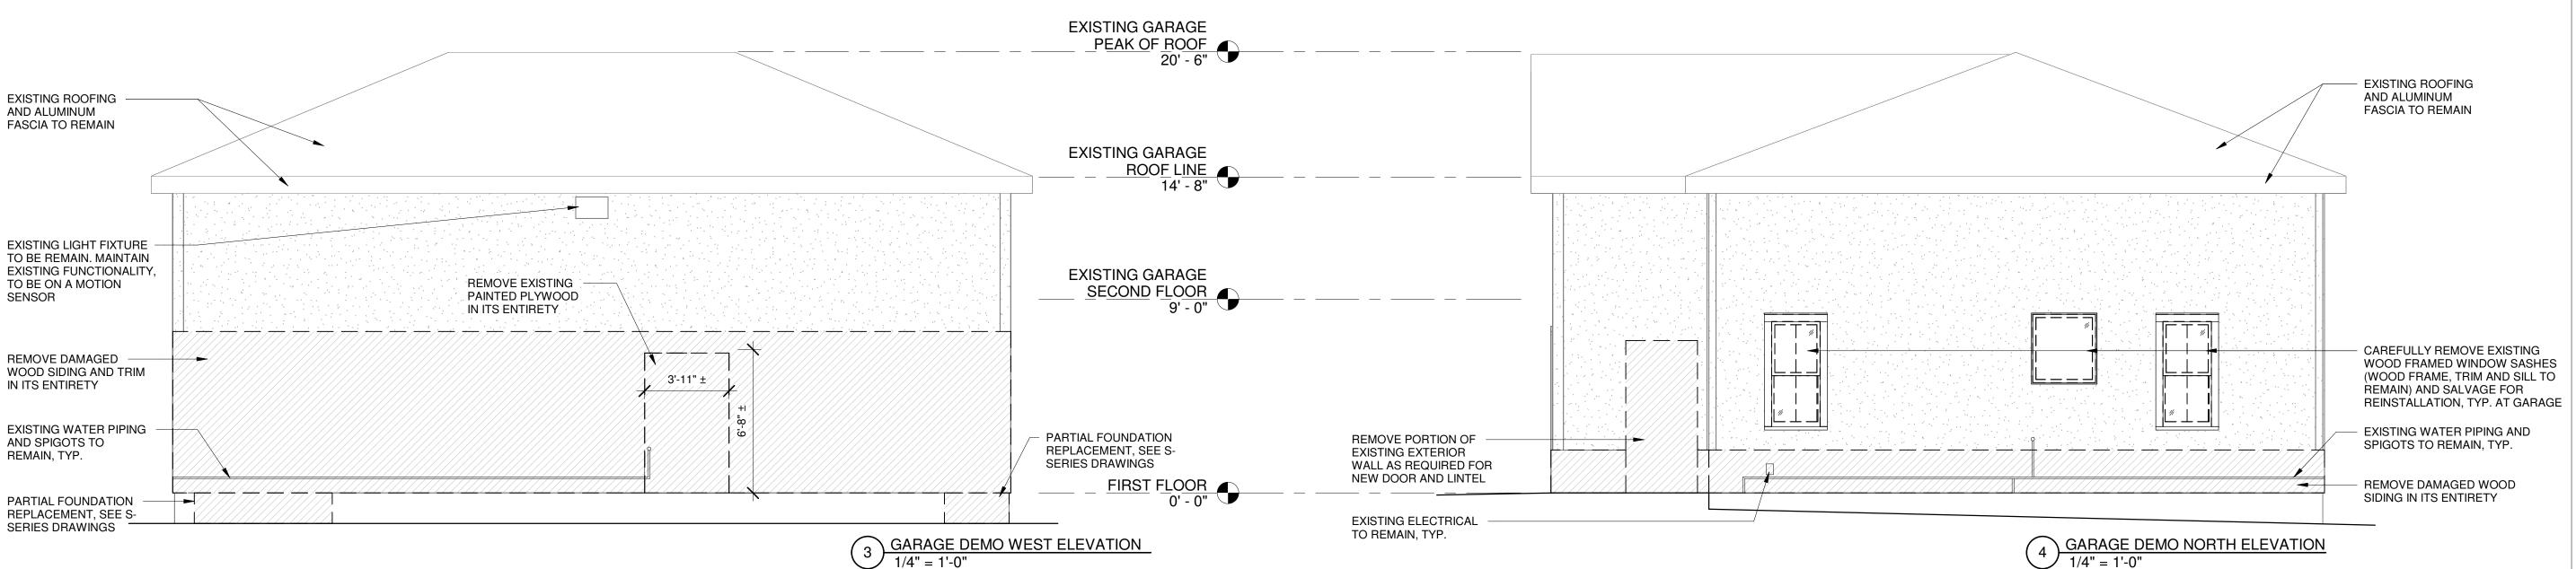
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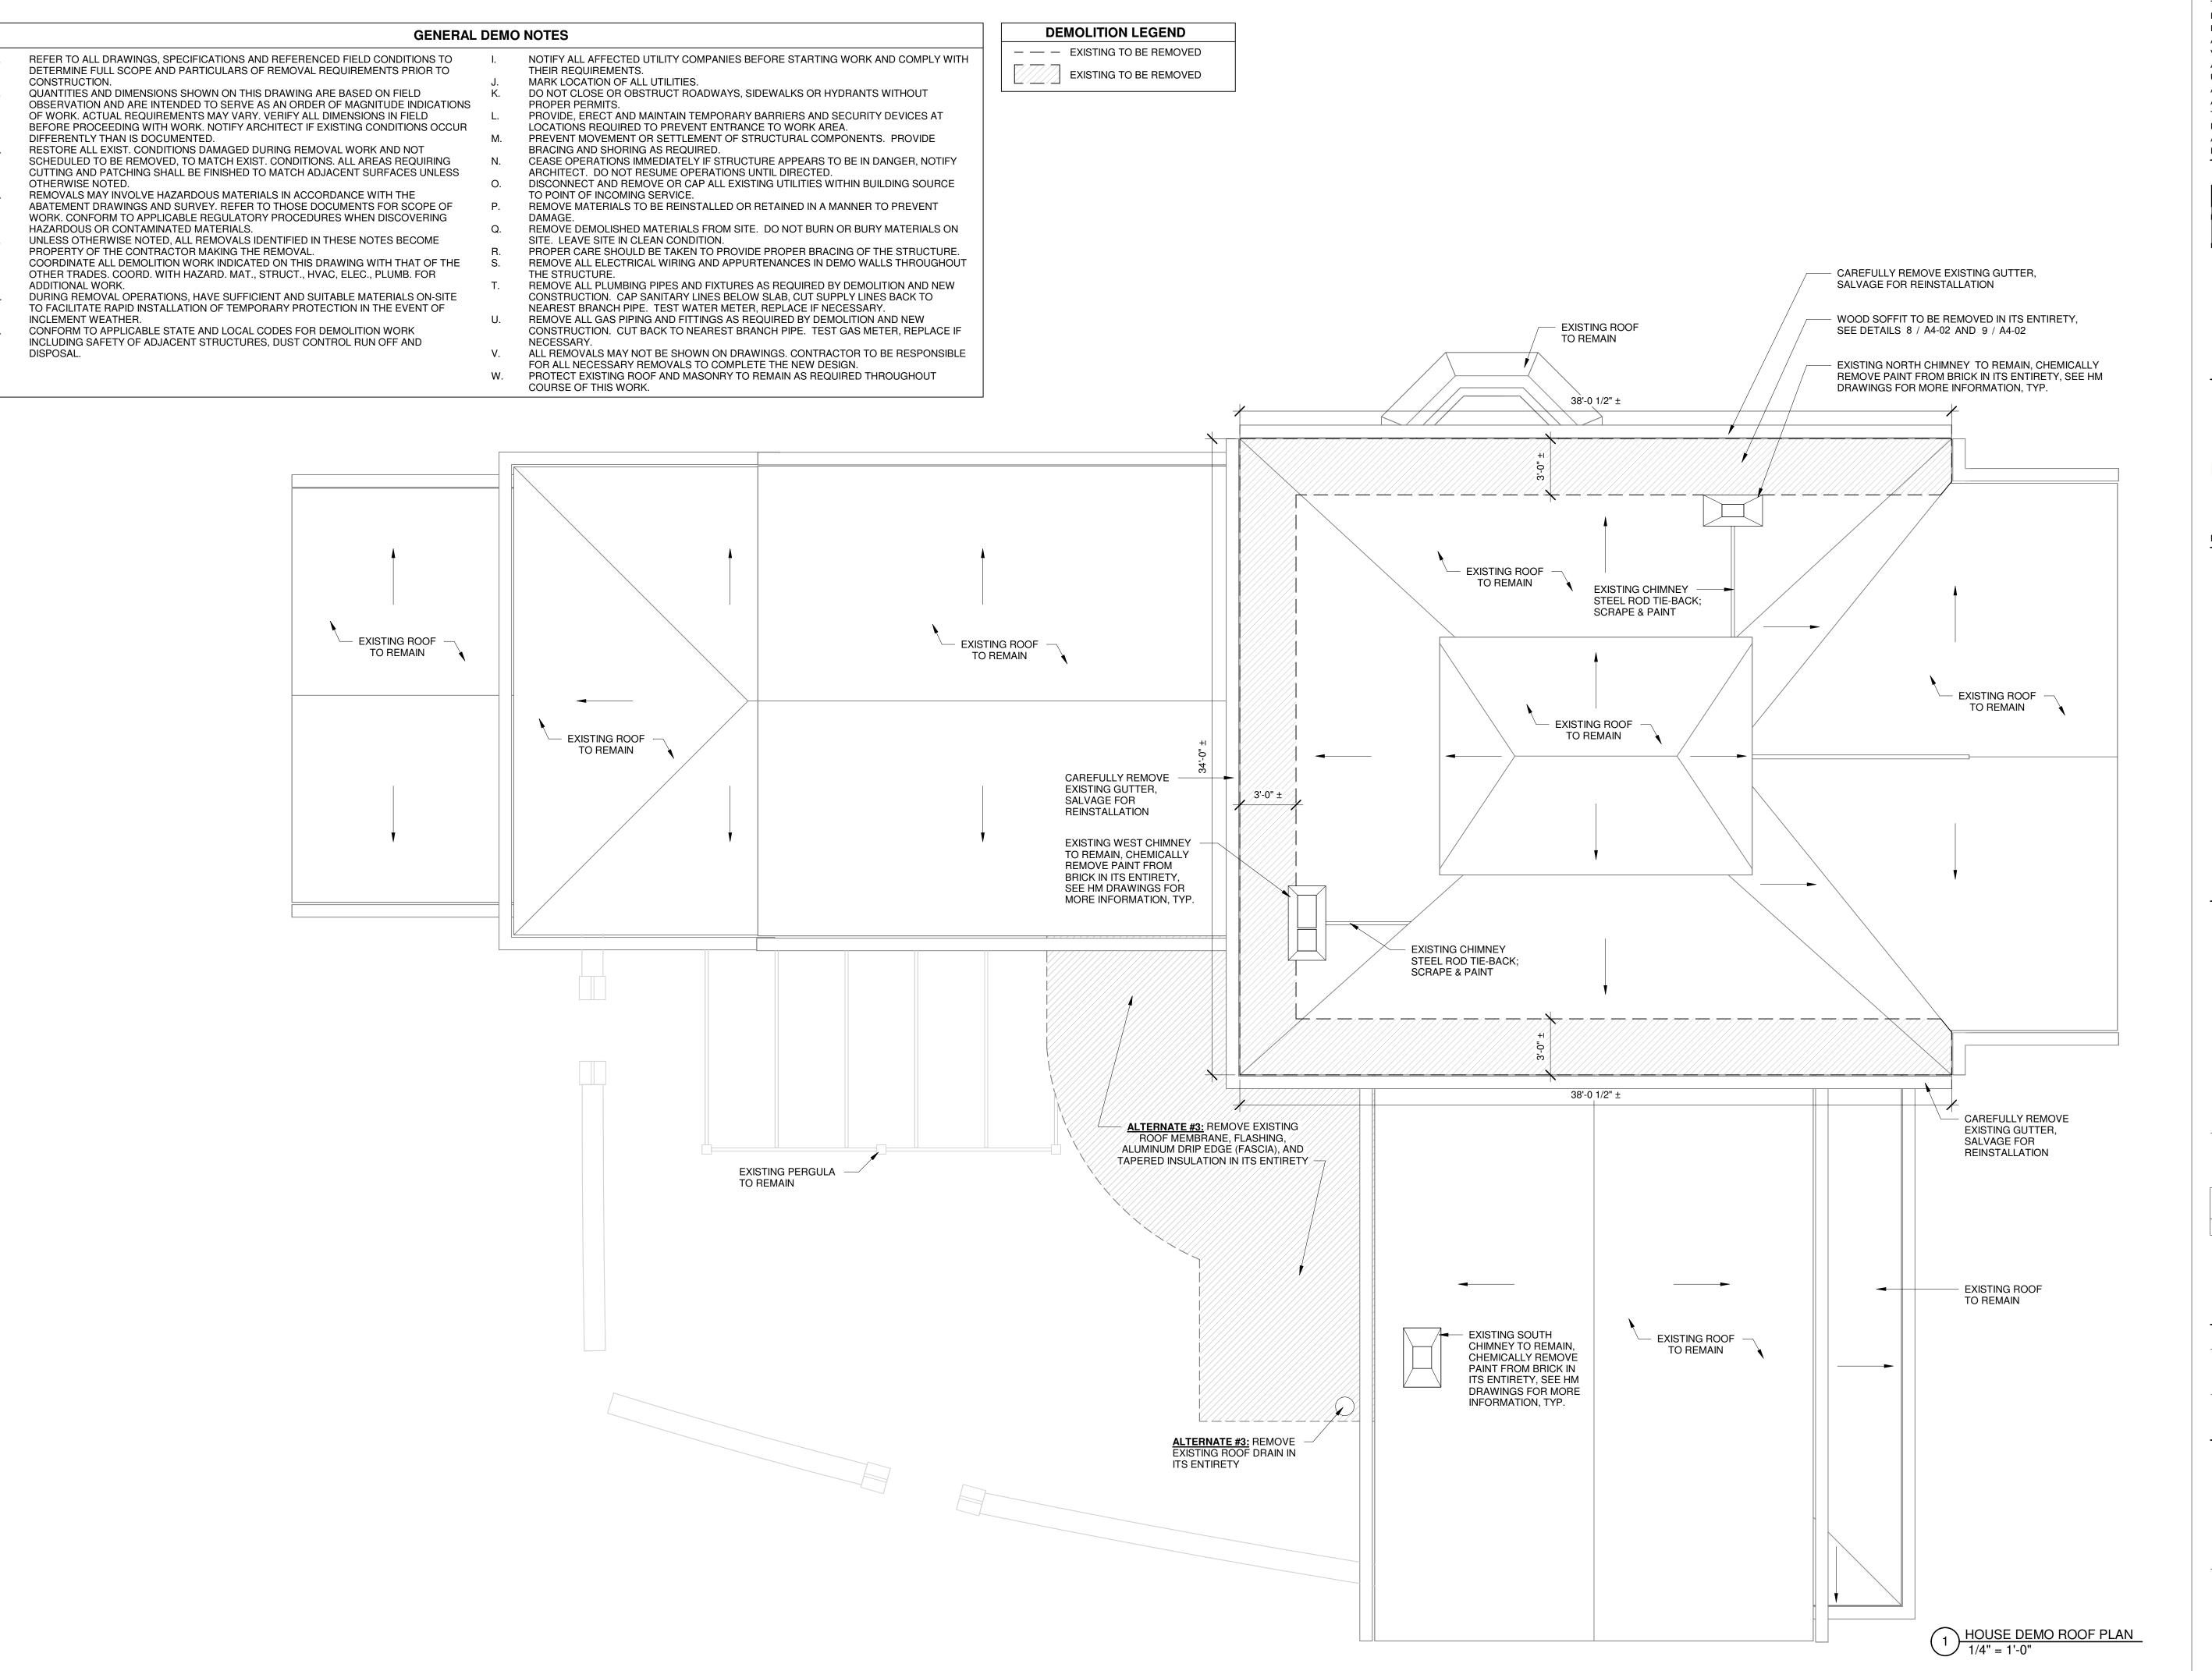
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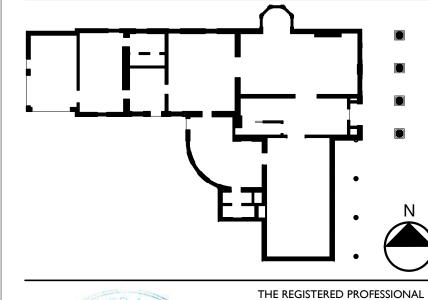
Drawing Title

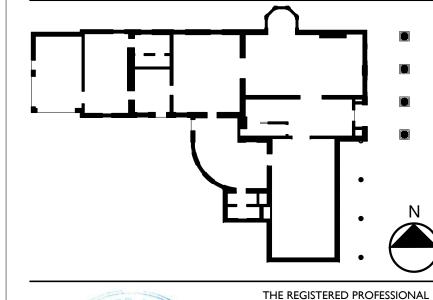GARAGE DEMO ELEVATIONS







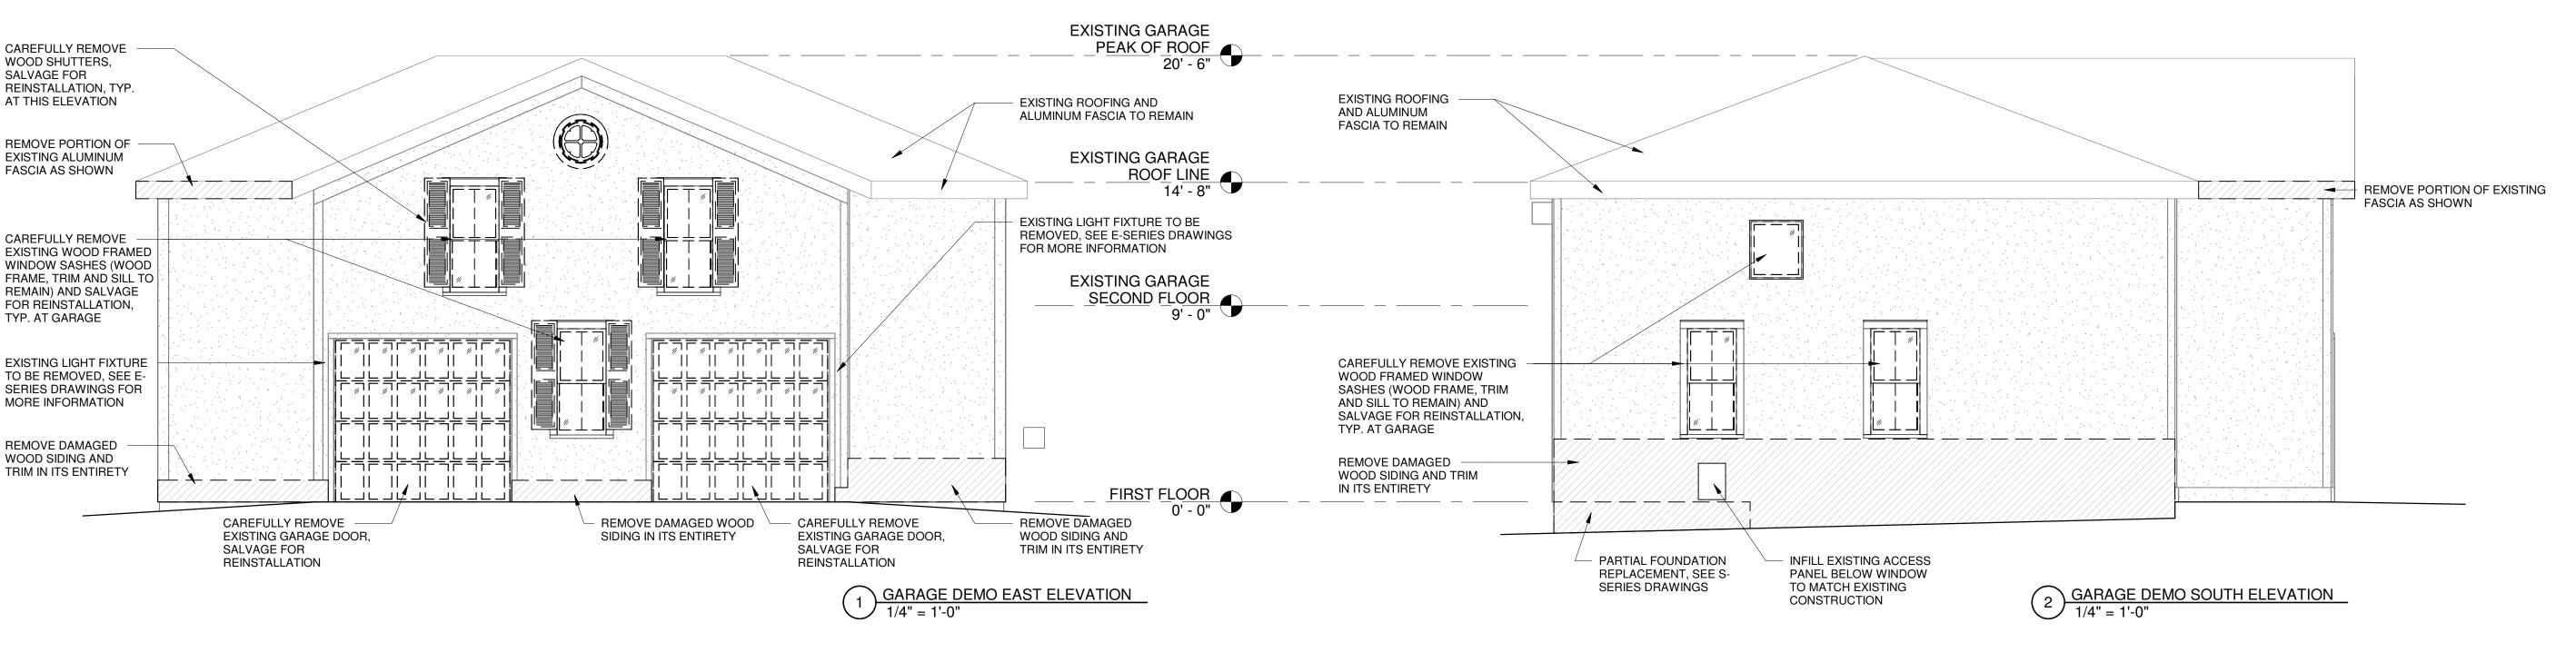



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PROJECT NO. 051037 LANFORD REHAB PHASE II EXTERIOR

194 CENTRAL AVENUE FREDONIA, NEW YORK 14063

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Revision Schedule		
Revision Number	Date	Description

DRAWING ISSUED: 10/1/2024

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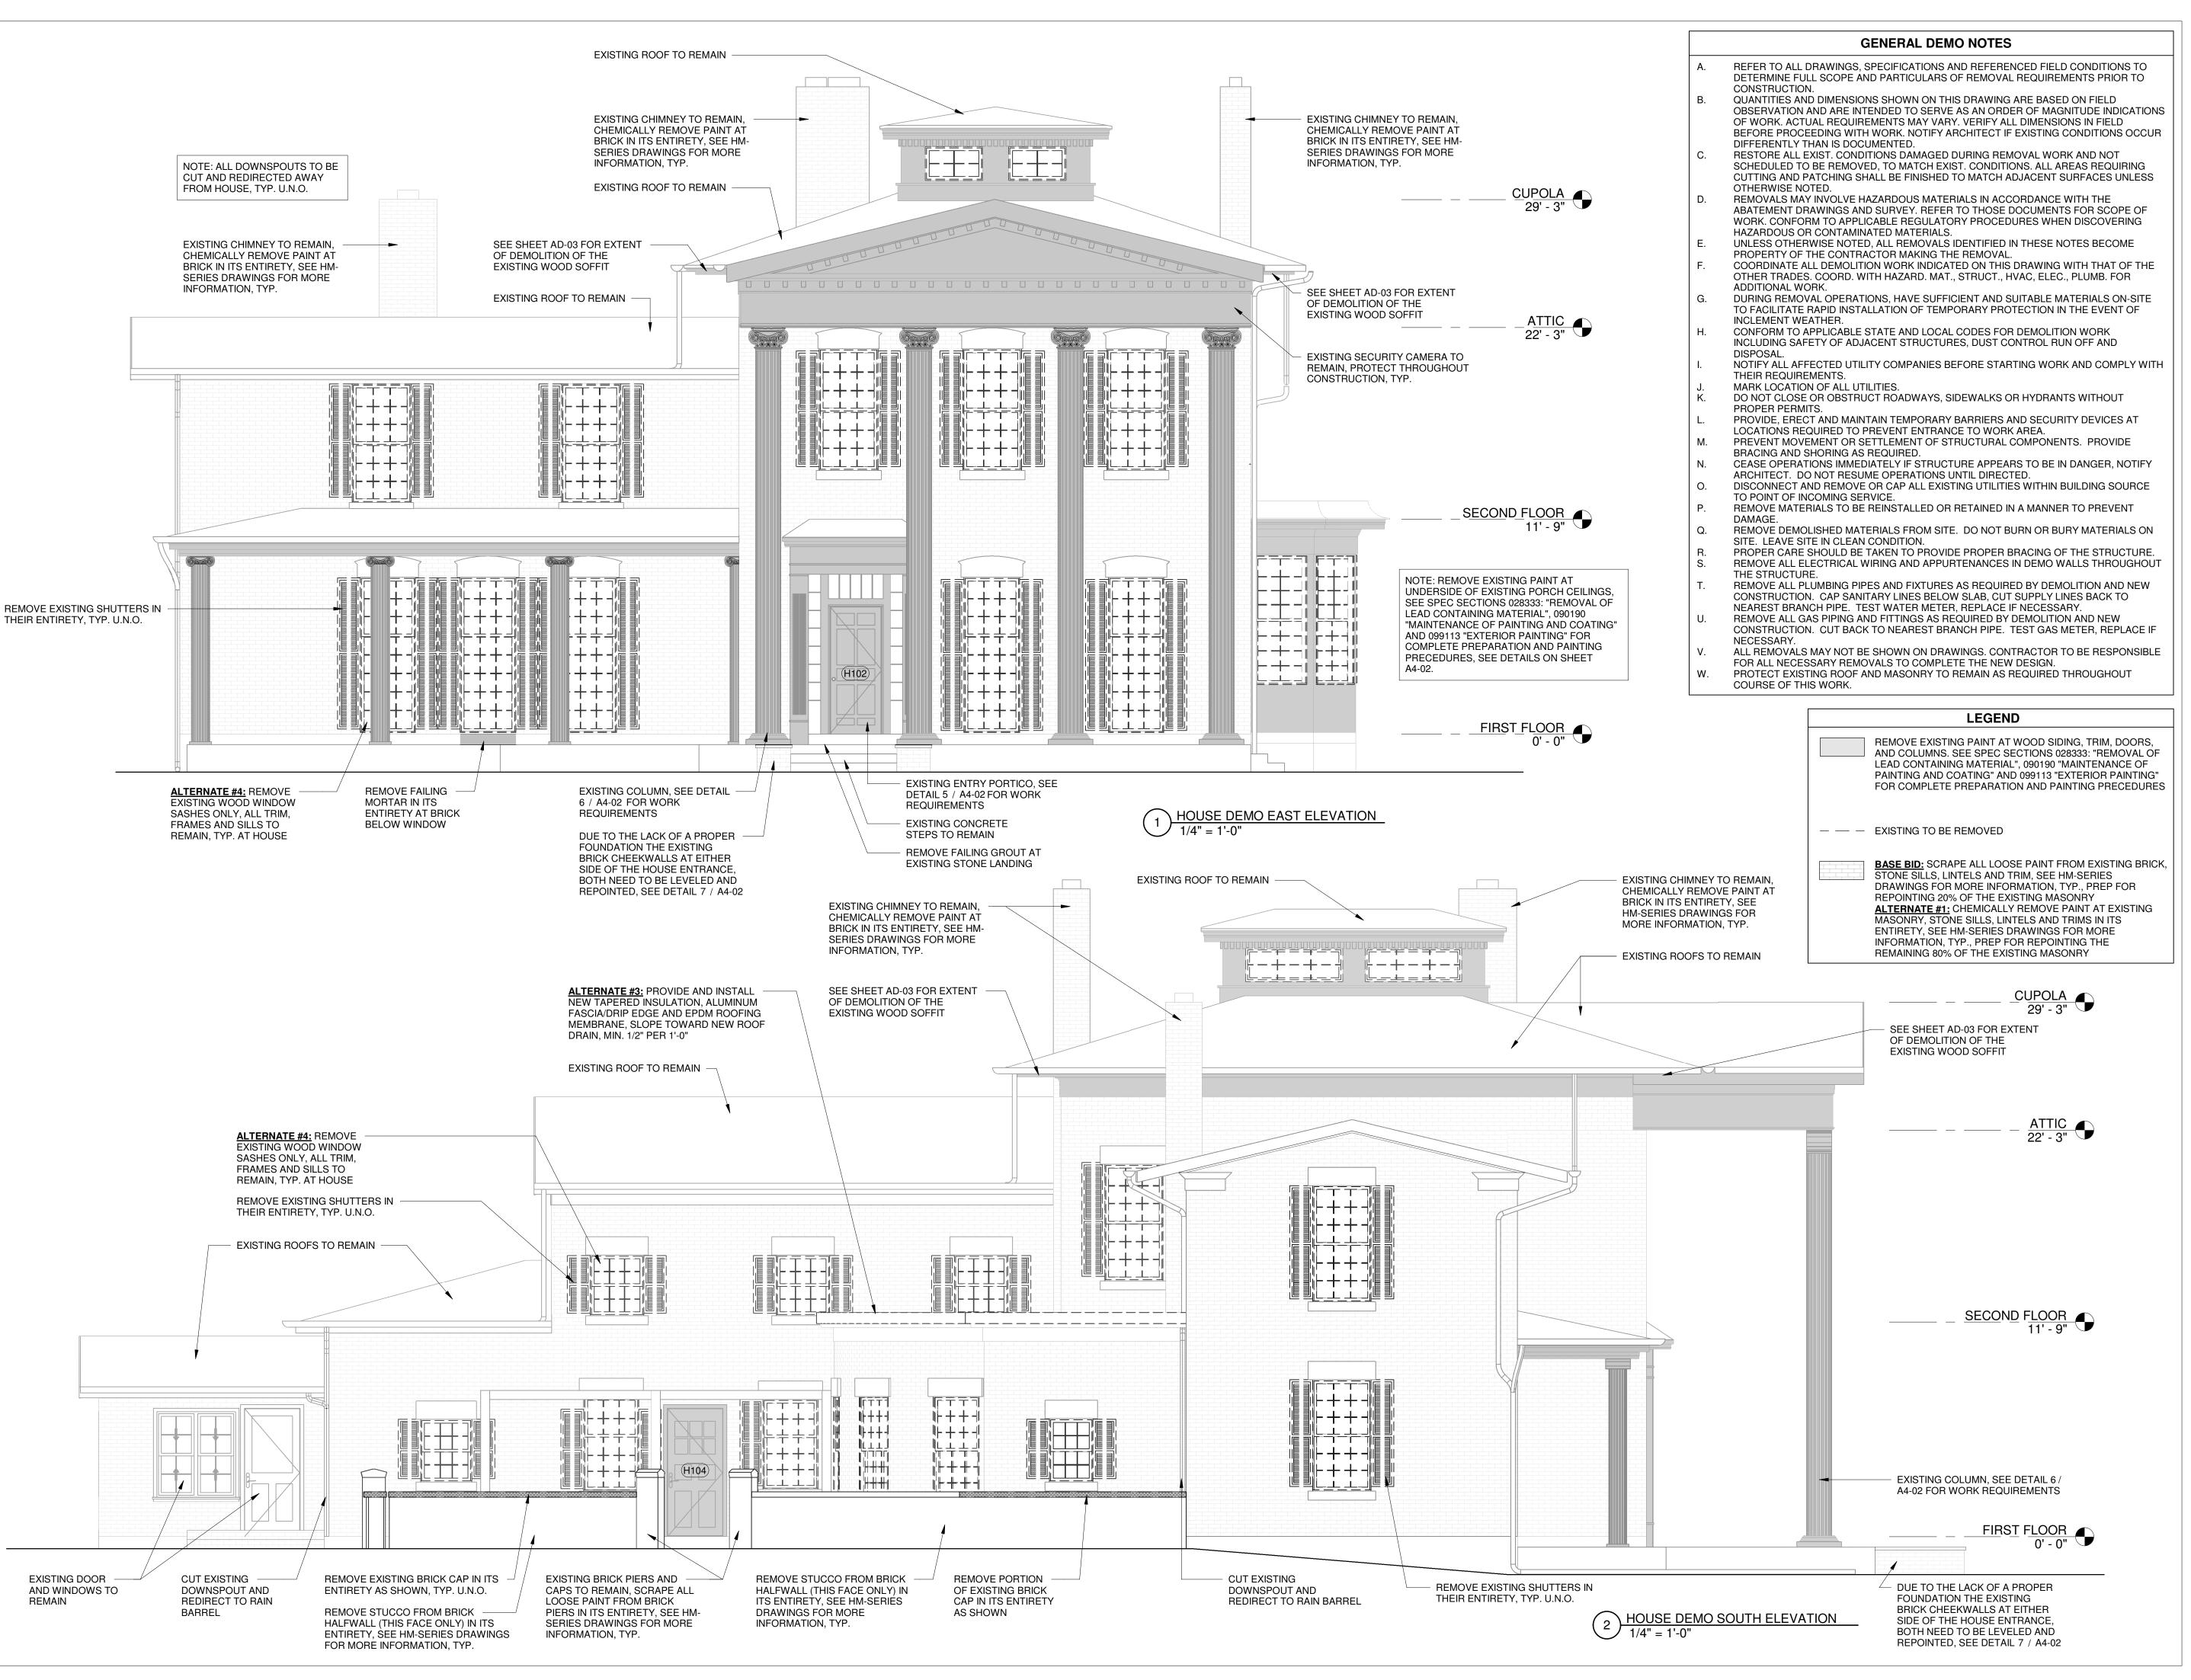
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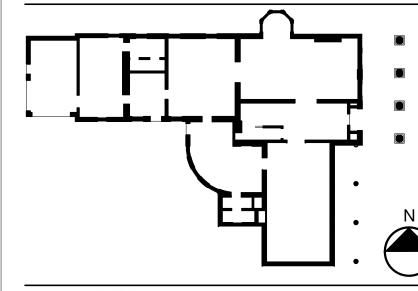
Drawing Title

HOUSE DEMO ROOF PLAN

Drawing Number

AD-03





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PROJECT NO. 051037 LANFORD REHAB

PHASE II EXTERIOR

FREDONIA, NEW YORK 14063

194 CENTRAL AVENUE


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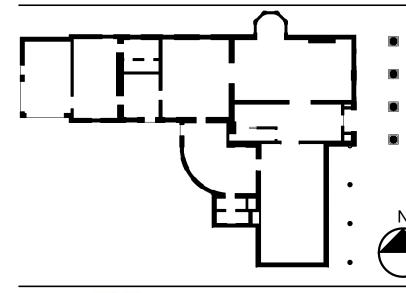
Revision Schedule		
Revision Number	Date	Description

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Drawing Title

HOUSE DEMO EAST AND SOUTH **ELEVATIONS**





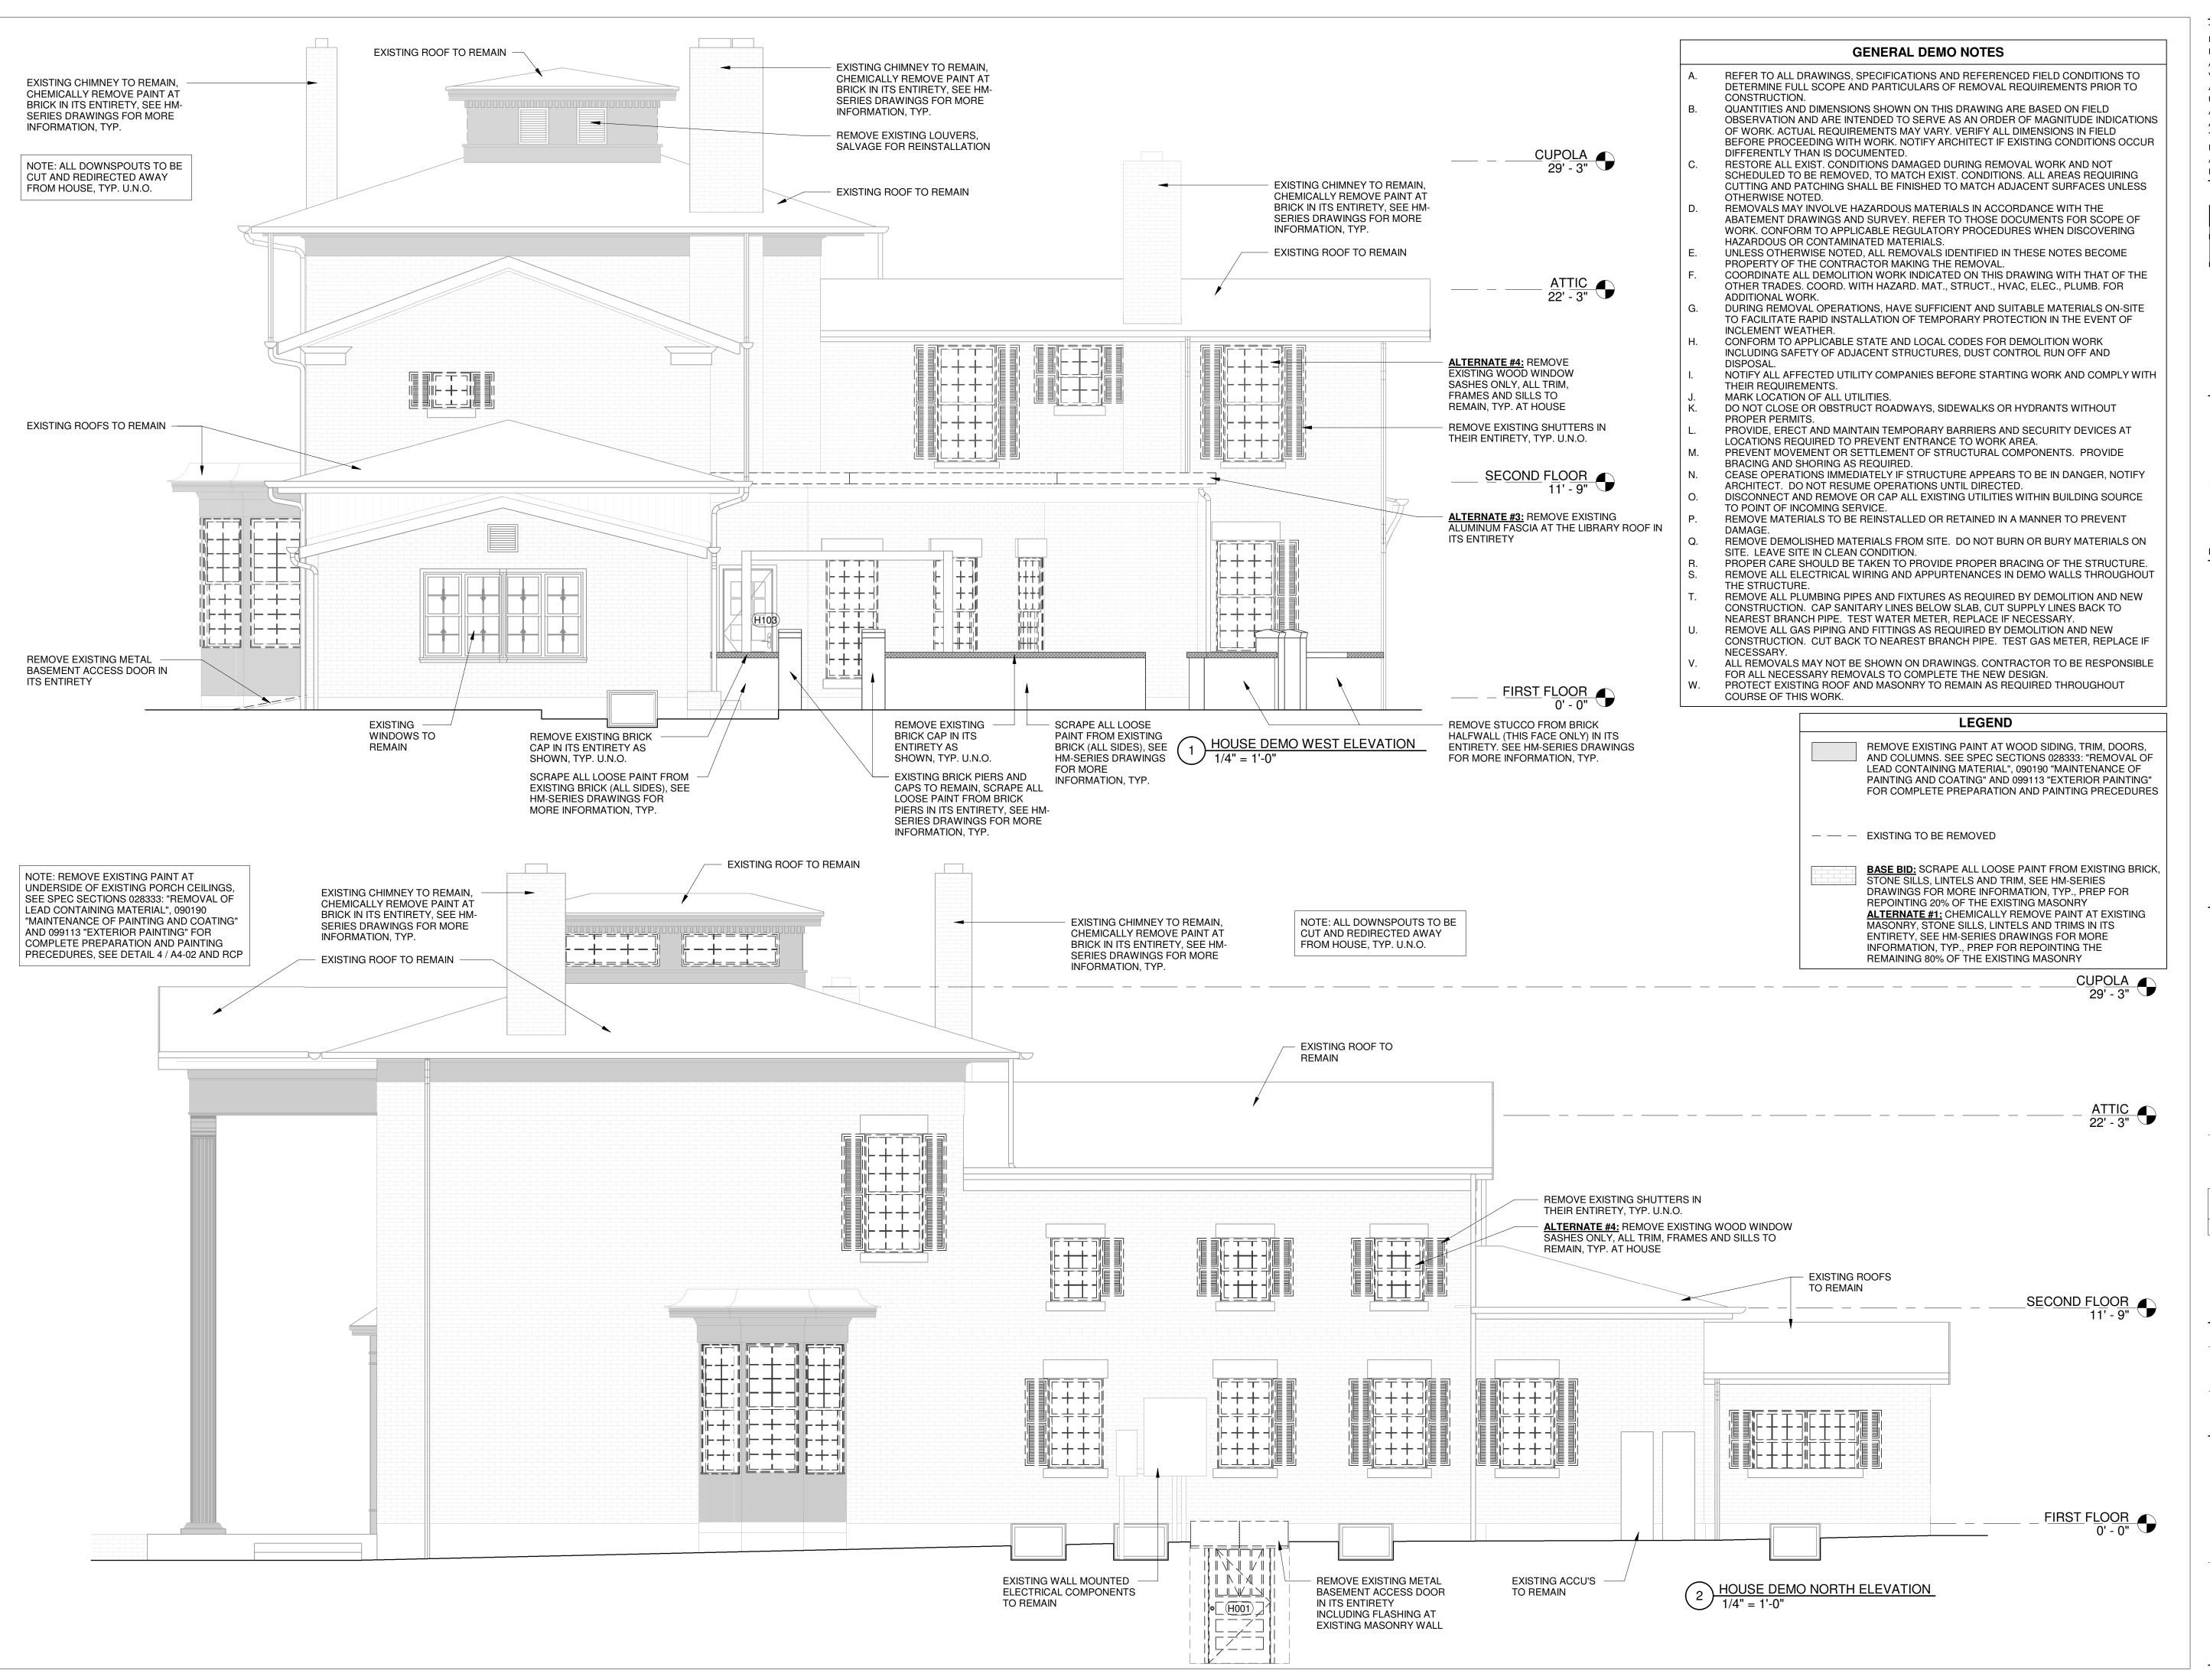

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194 CENTRAL AVENUE FREDONIA, NEW YORK 14063


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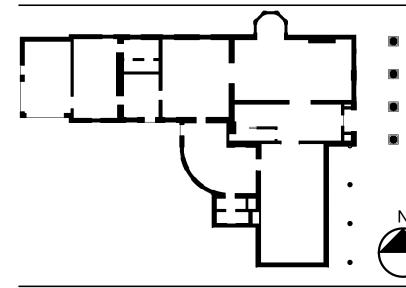
Revision Schedule		
Revision Number	Date	Description

DRAWING ISSUED: 10/1/2024 Scale: **Project Number:** 1/4" = 1'-0" FBA PROJECT #00388.00 Drawn By: Checked By:

Drawing Title

HOUSE DEMO WEST AND NORTH **ELEVATIONS**



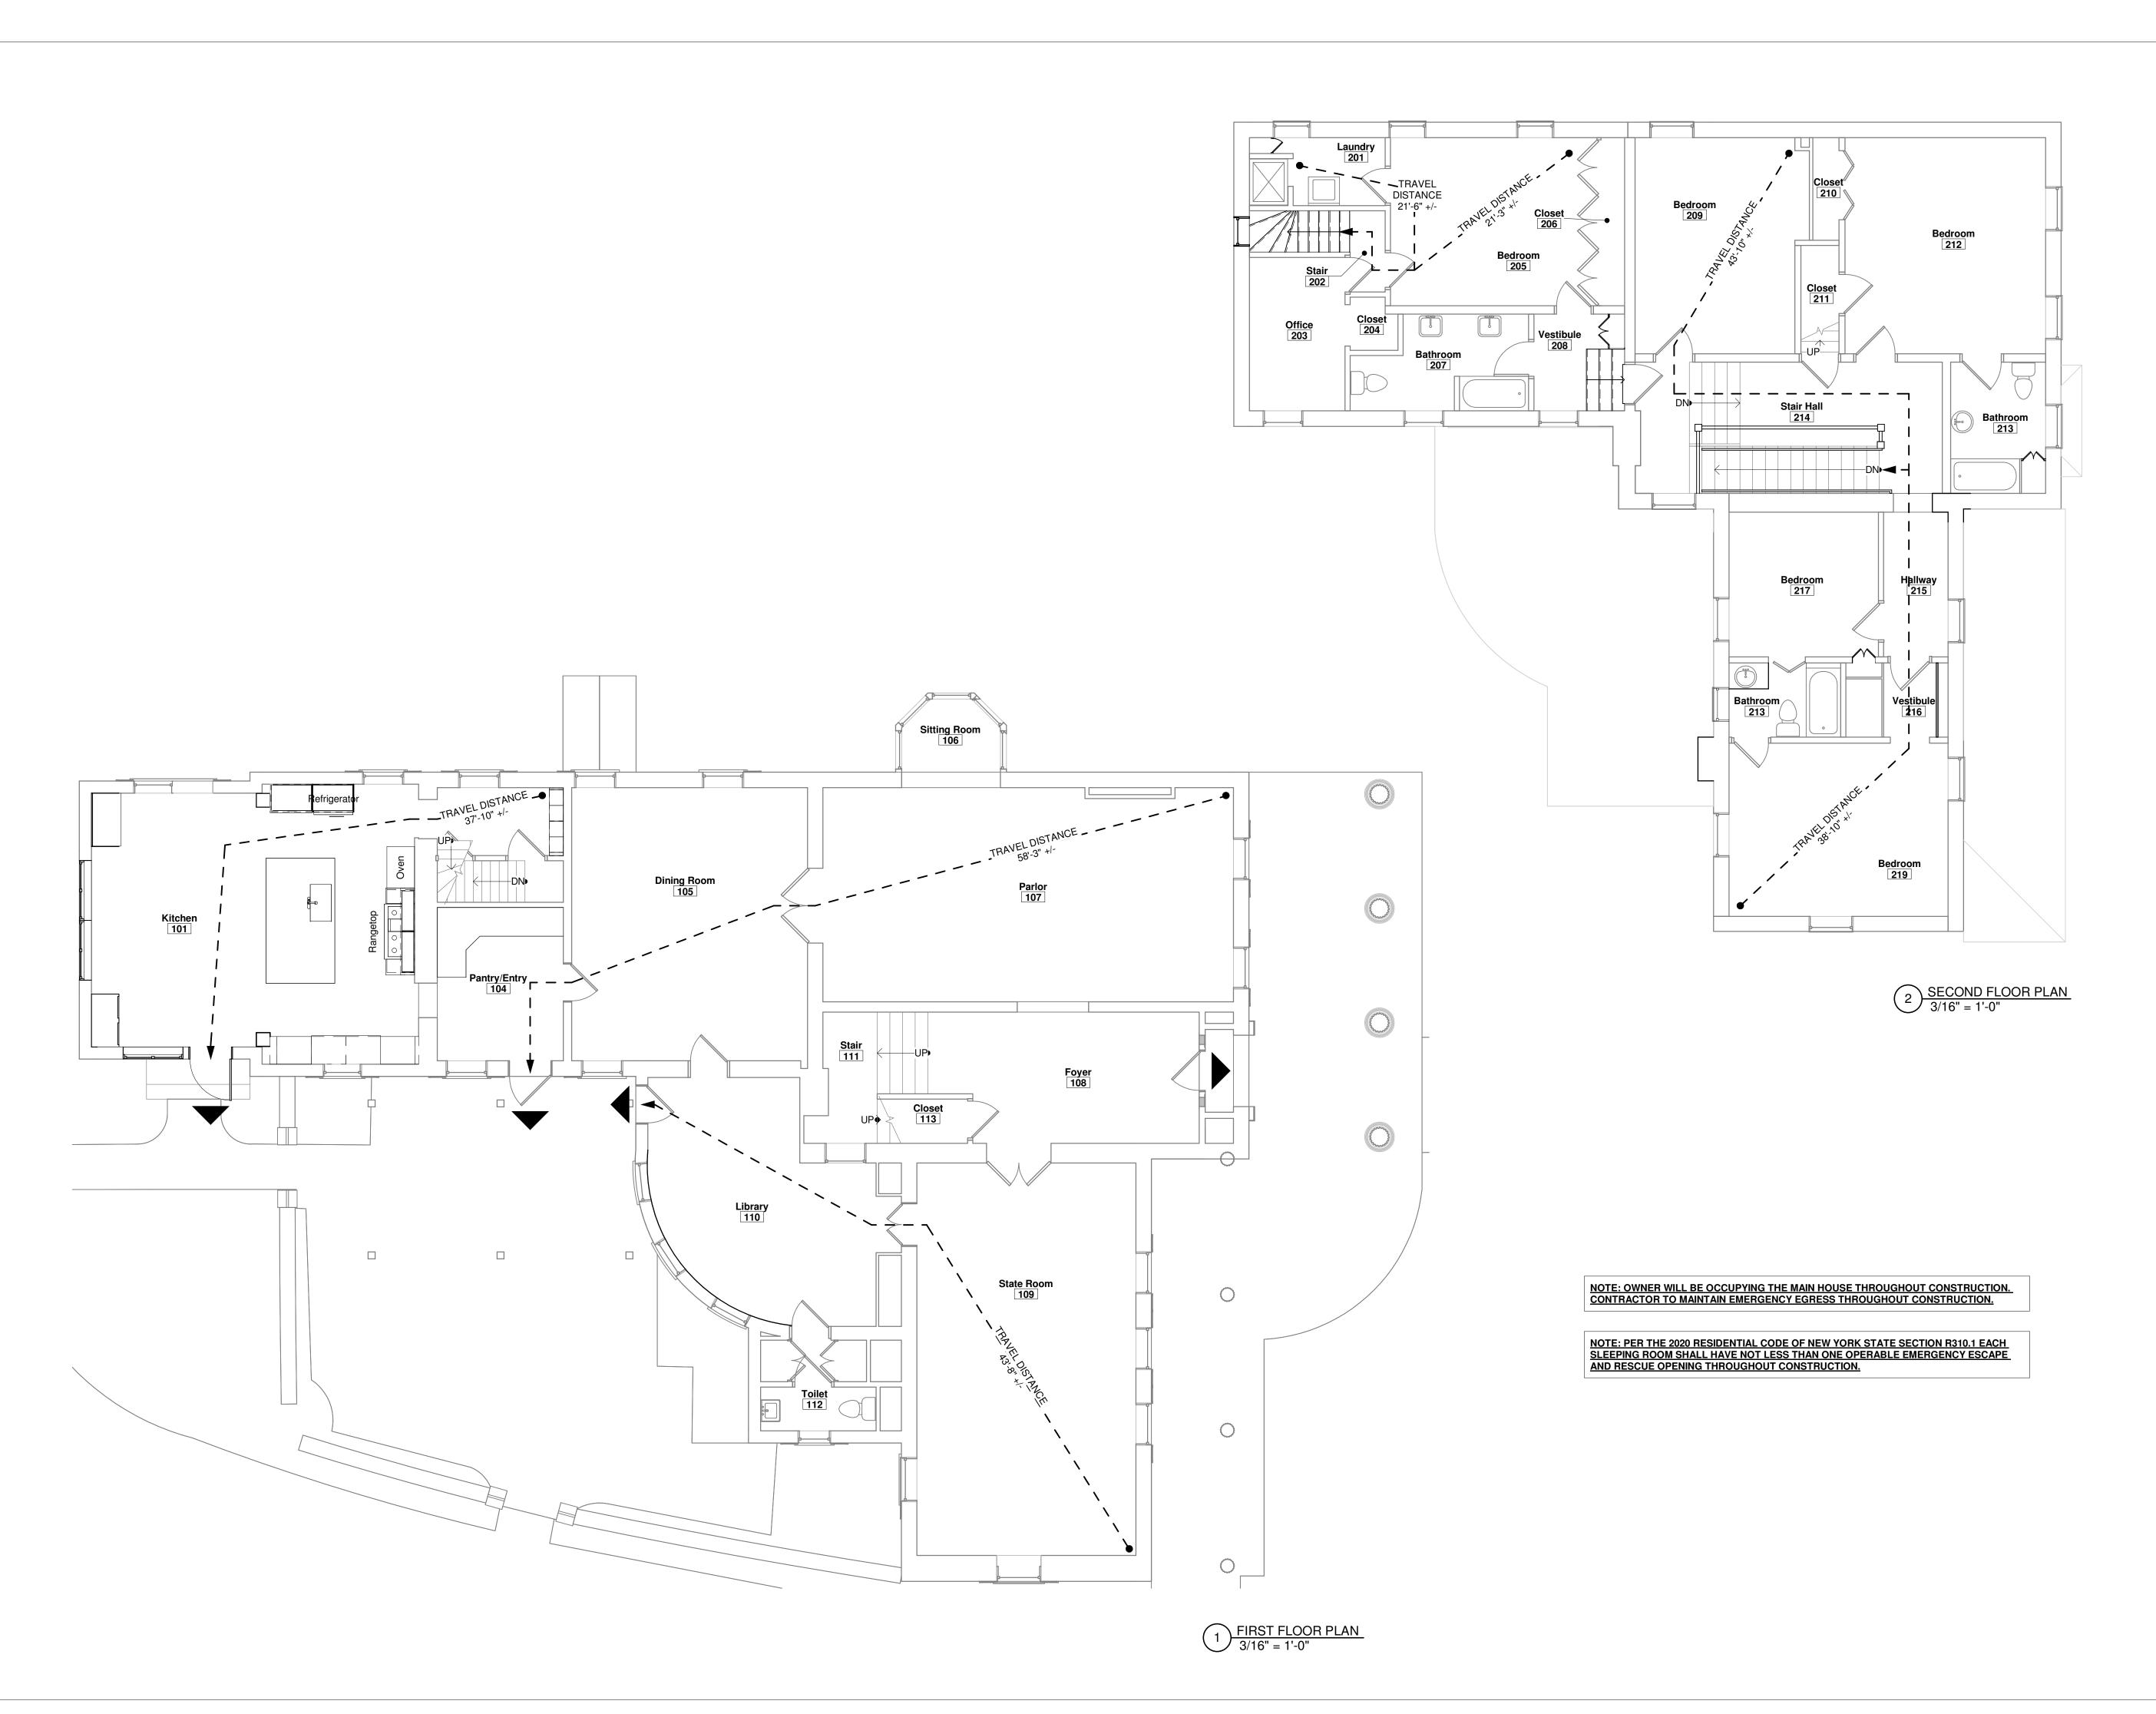



WITH: THE BUILDING CODE OF NEW YORK STATE AND THE ENERGY CONSERVATION CODE OF NEW YORK STATE AND APPLICABLE FEDERAL LAWS AND REGULATIONS AND TO THE BEST OF MY KNOWLEDGE AND BELIEF, THESE CONSTRUCTION DOCUMENTS ARE IN CONFORMANCE THEREWITH.

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194 CENTRAL AVENUE FREDONIA, NEW YORK 14063

100% CONSTRUCTION DOCUMENT SET


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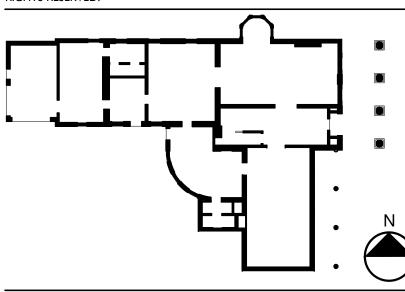
Drawing Title

CODE CONFORMANCE PLANS

Drawing Number

CC-01



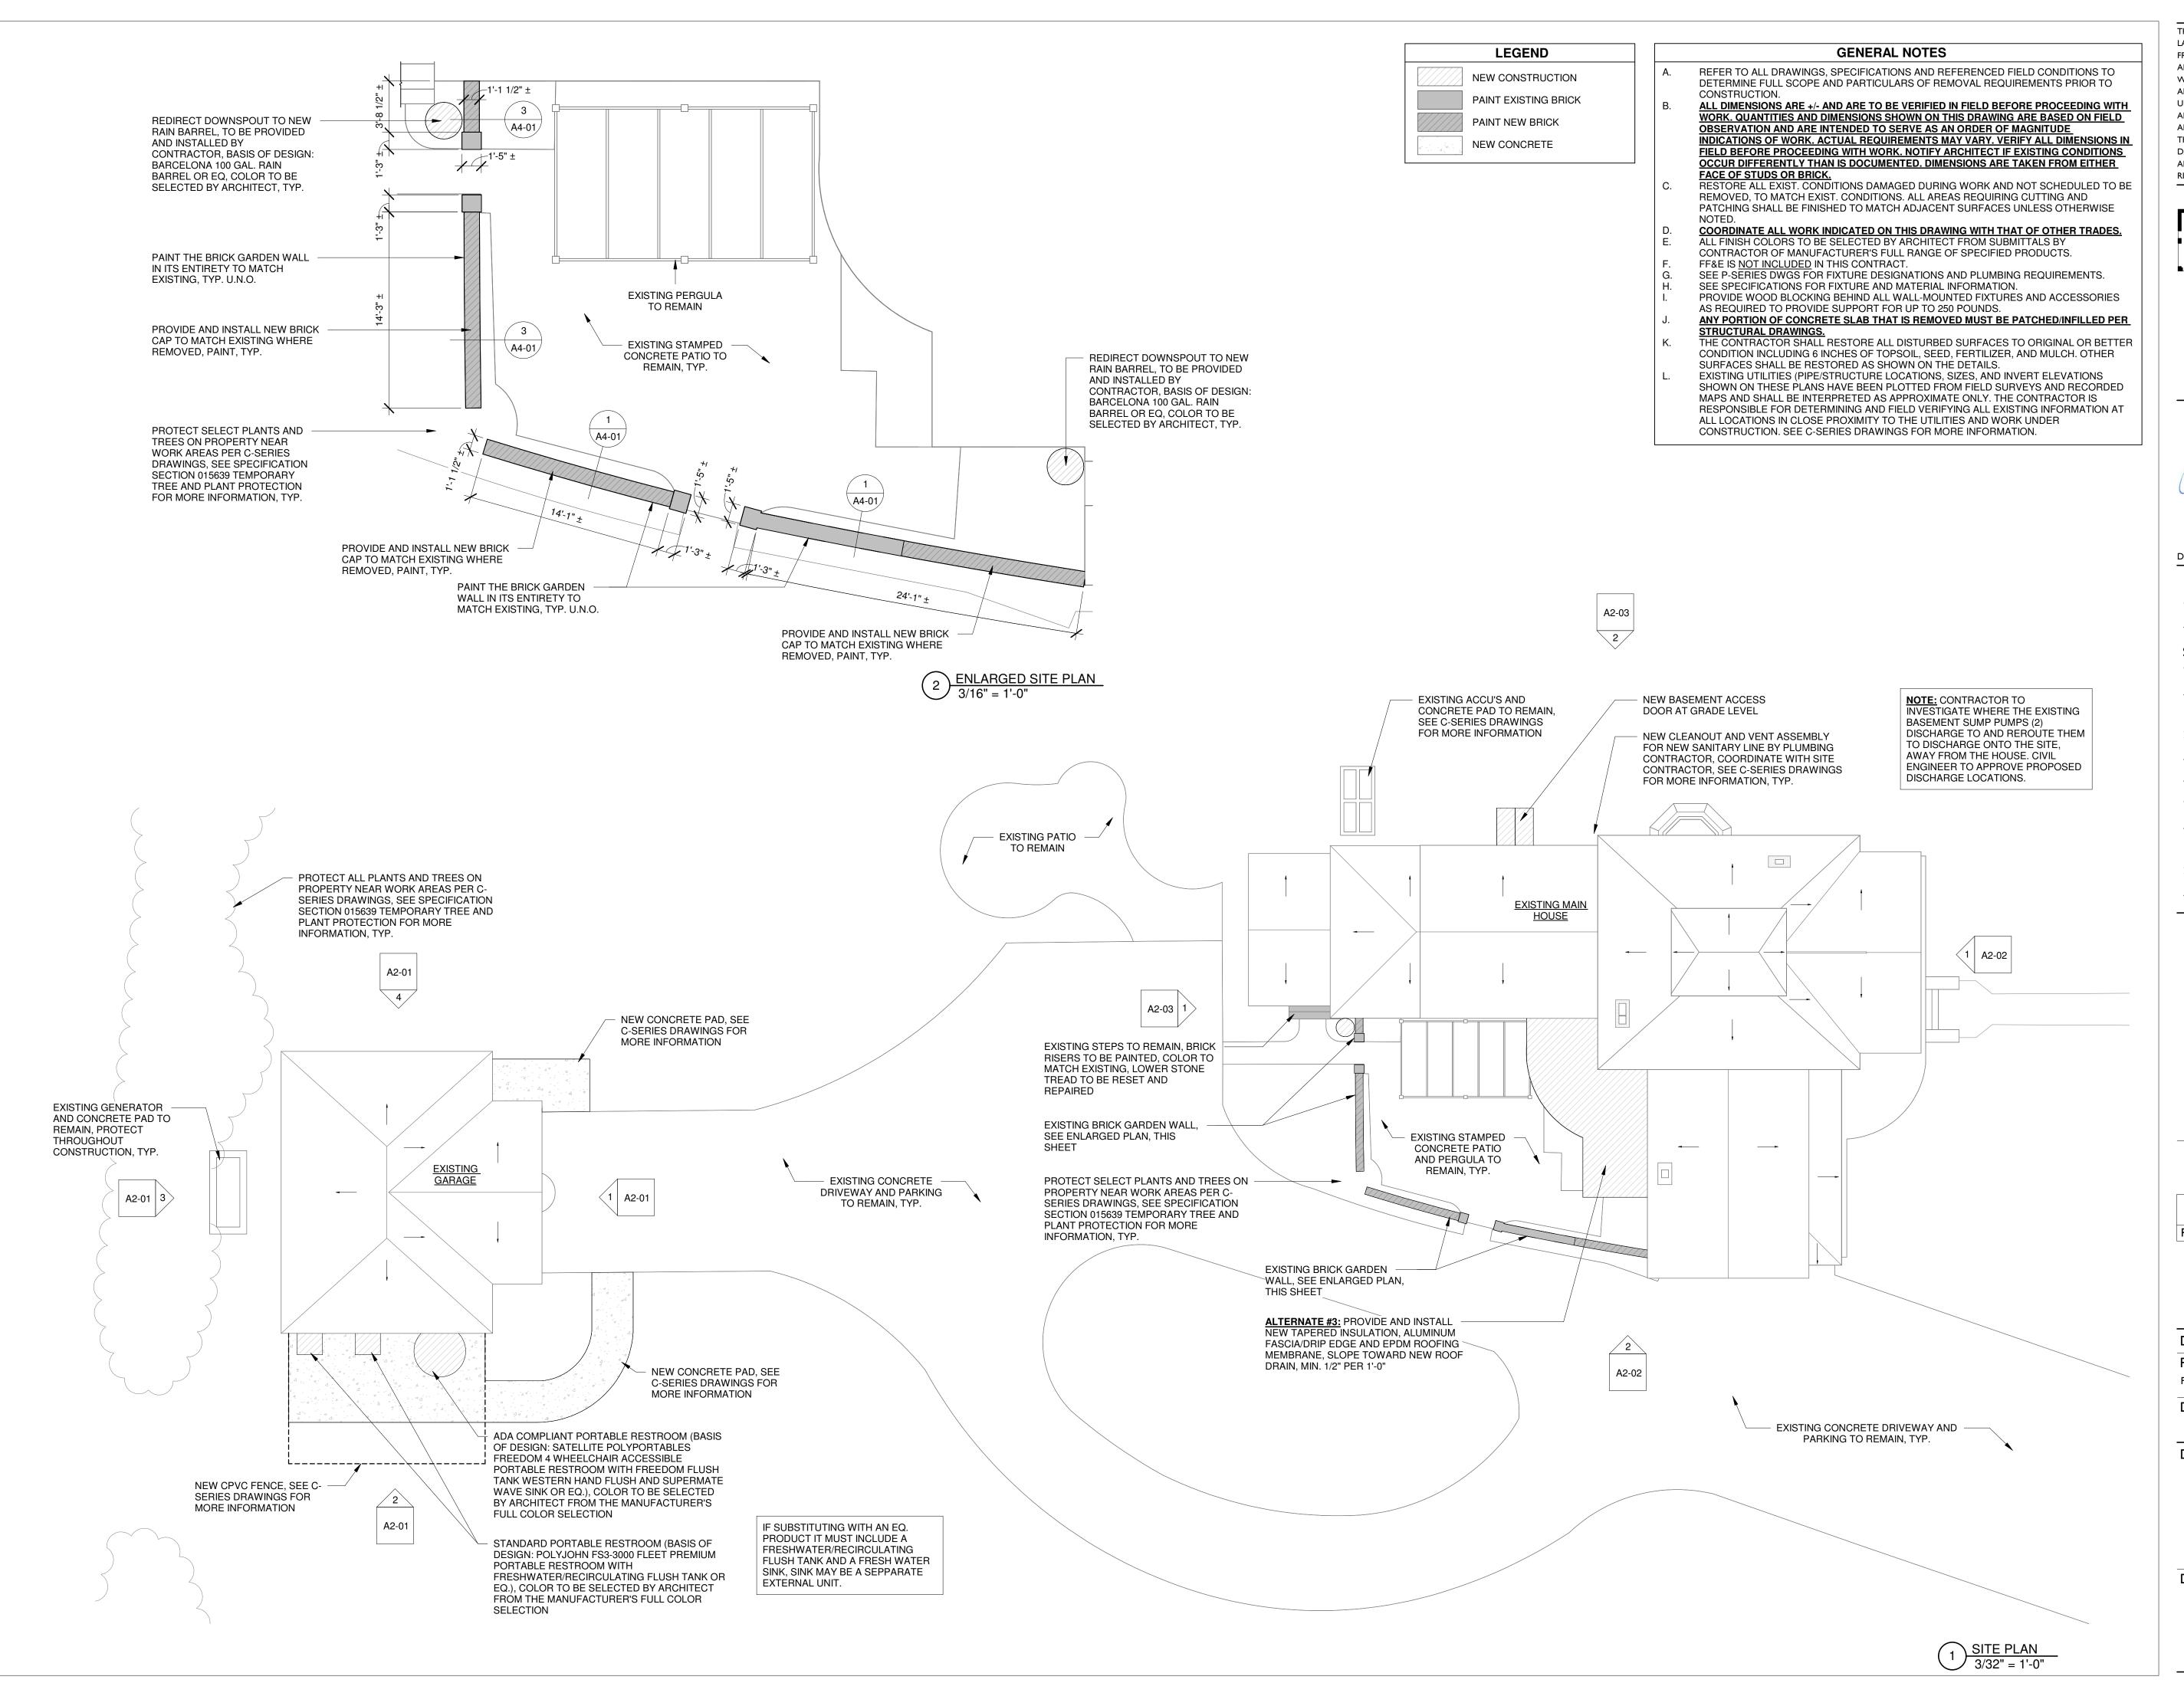

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194 CENTRAL AVENUE FREDONIA, NEW YORK 14063


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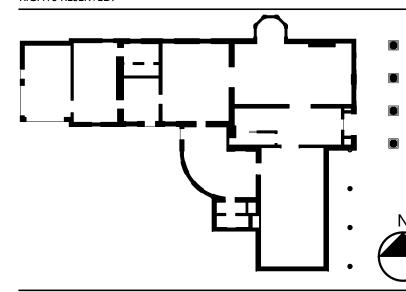
Revision Schedule		
Revision Number	Date	Description

DRAWING ISSUED: 10/1/2024 Scale: **Project Number:** As indicated FBA PROJECT #00388.00 Drawn By: Checked By:

Drawing Title

SITE PLAN



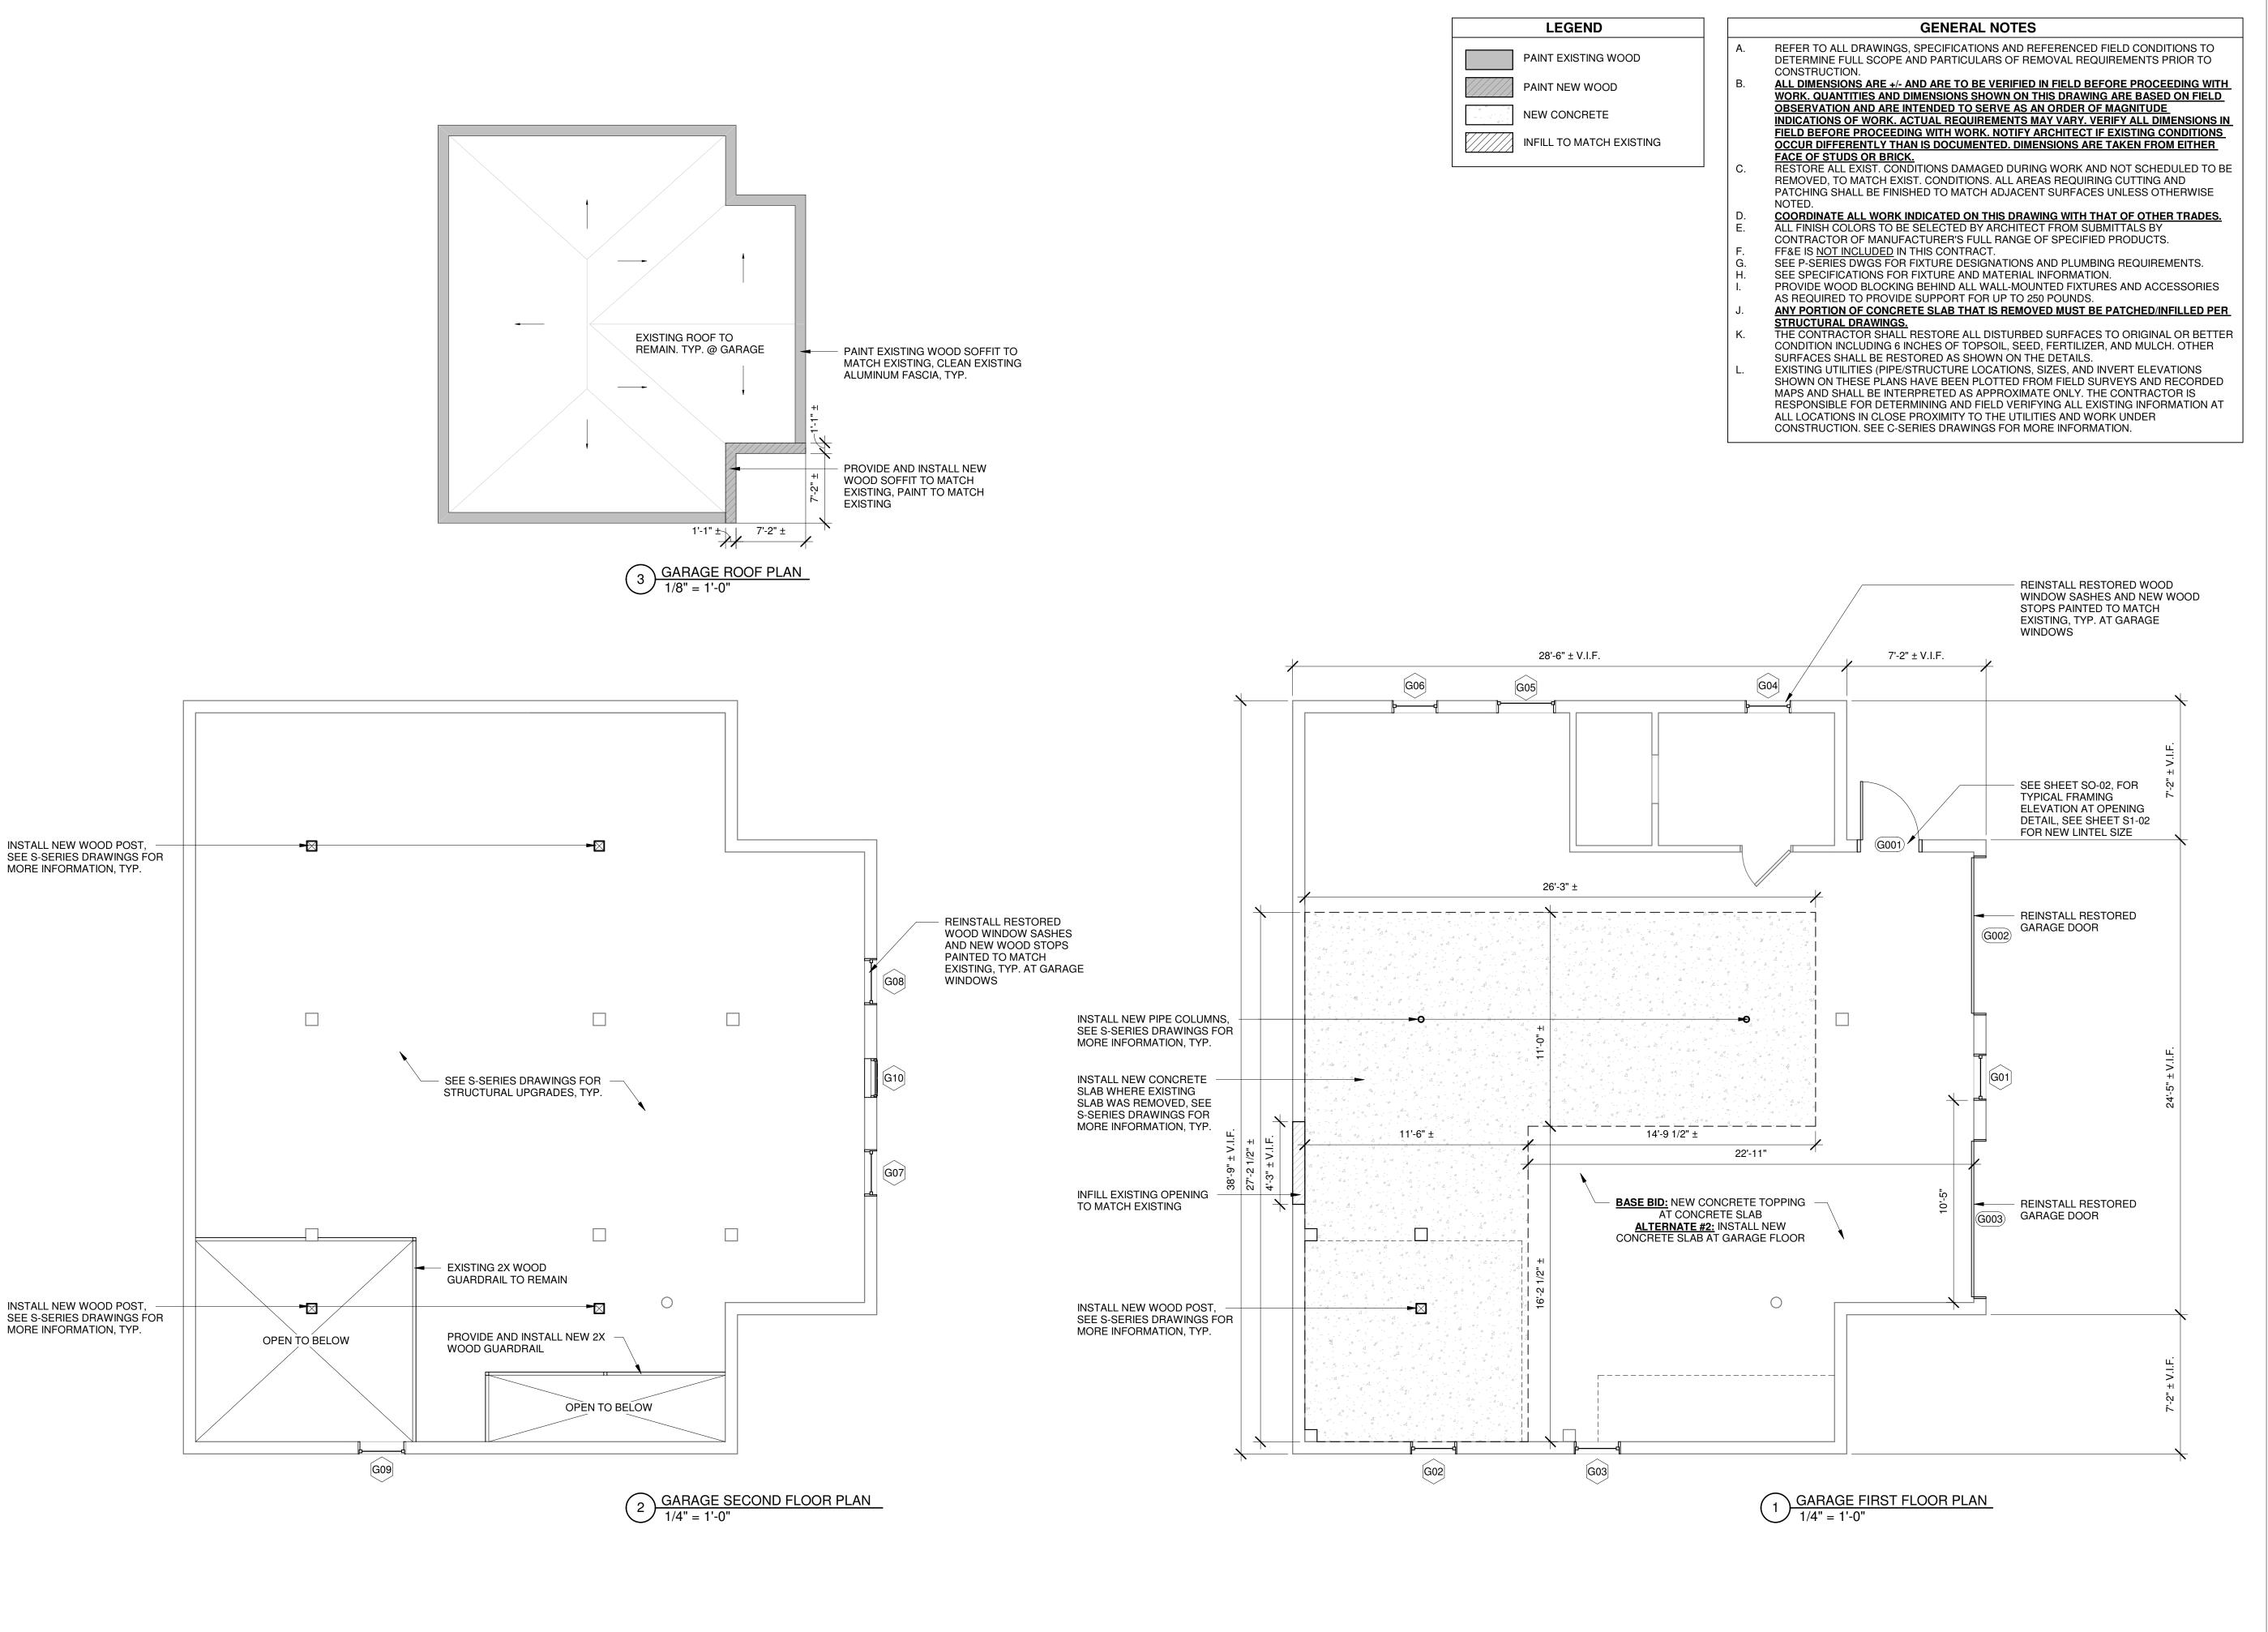



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194 CENTRAL AVENUE FREDONIA, NEW YORK 14063


100% CONSTRUCTION DOCUMENT SET

Revision Schedule		
Date	Description	

DRAWING ISSUED: 10/1/2024 Scale: Project Number: As indicated FBA PROJECT #00388.00 Drawn By: Checked By:

Drawing Title

GARAGE PLANS

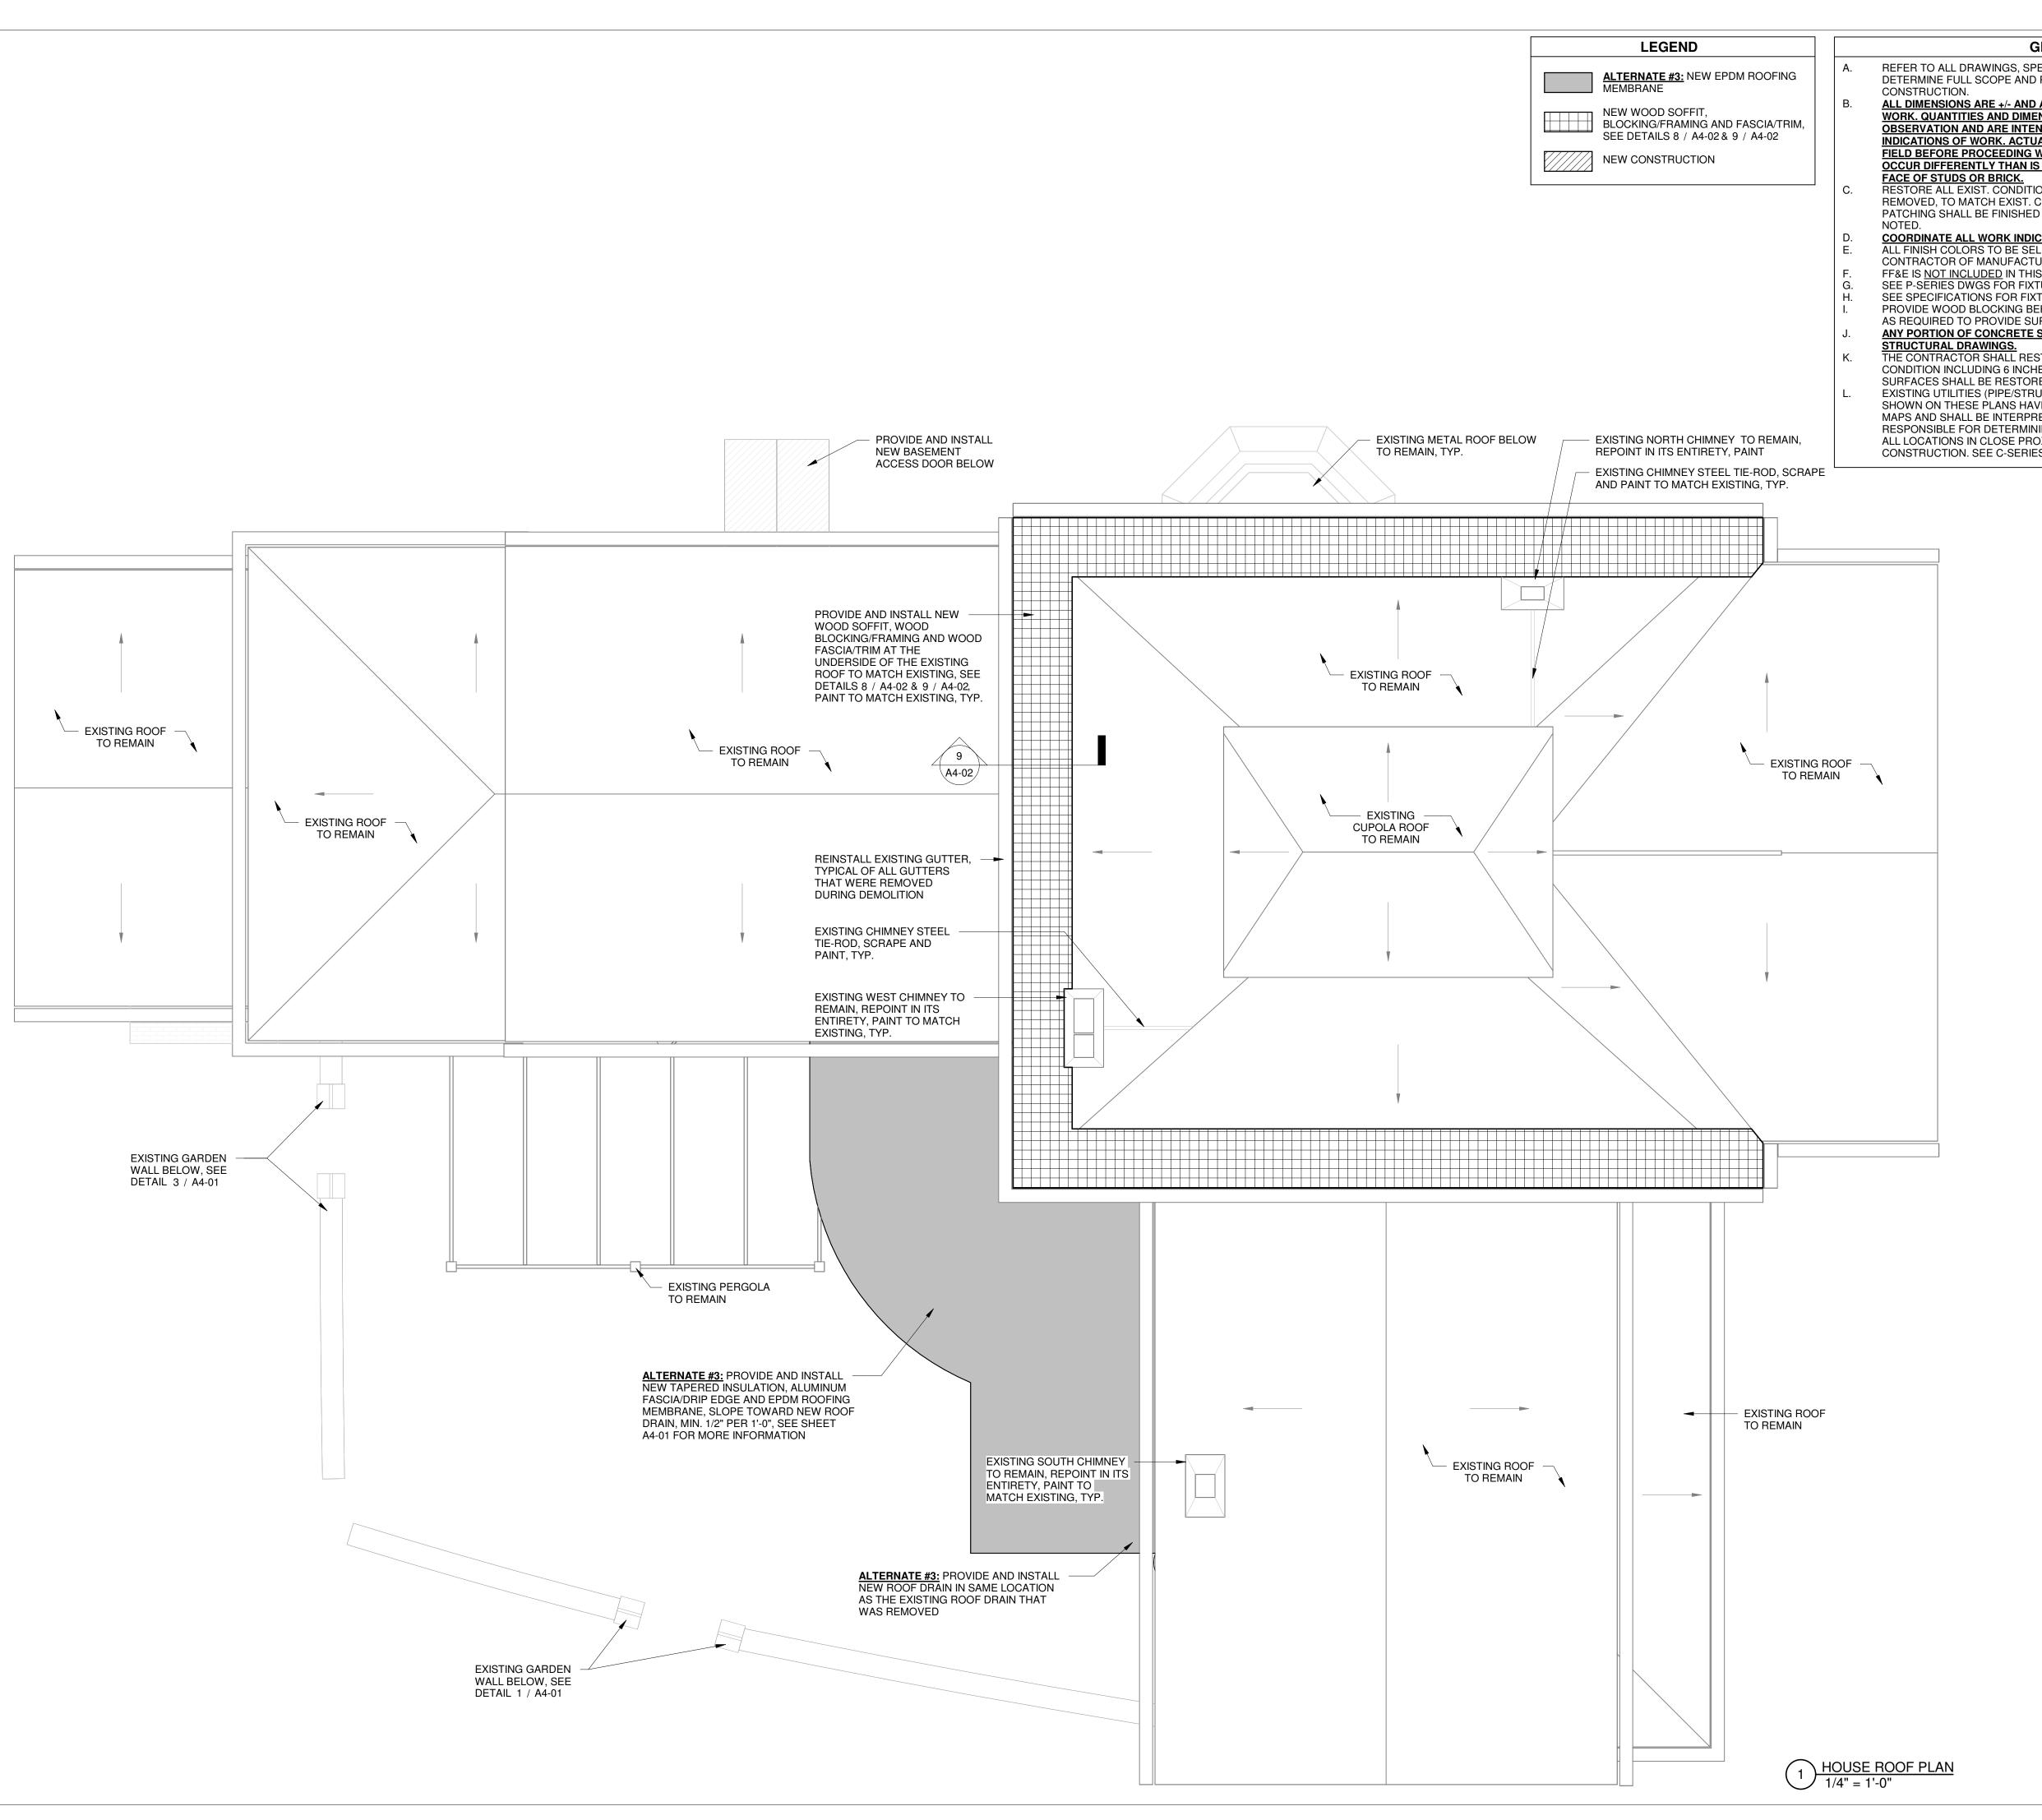

GENERAL NOTES

REFER TO ALL DRAWINGS, SPECIFICATIONS AND REFERENCED FIELD CONDITIONS TO DETERMINE FULL SCOPE AND PARTICULARS OF REMOVAL REQUIREMENTS PRIOR TO CONSTRUCTION

ALL DIMENSIONS ARE +/- AND ARE TO BE VERIFIED IN FIELD BEFORE PROCEEDING WITH WORK. QUANTITIES AND DIMENSIONS SHOWN ON THIS DRAWING ARE BASED ON FIELD OBSERVATION AND ARE INTENDED TO SERVE AS AN ORDER OF MAGNITUDE INDICATIONS OF WORK. ACTUAL REQUIREMENTS MAY VARY. VERIFY ALL DIMENSIONS IN FIELD BEFORE PROCEEDING WITH WORK. NOTIFY ARCHITECT IF EXISTING CONDITIONS OCCUR DIFFERENTLY THAN IS DOCUMENTED. DIMENSIONS ARE TAKEN FROM EITHER

RESTORE ALL EXIST. CONDITIONS DAMAGED DURING WORK AND NOT SCHEDULED TO BE REMOVED, TO MATCH EXIST. CONDITIONS. ALL AREAS REQUIRING CUTTING AND PATCHING SHALL BE FINISHED TO MATCH ADJACENT SURFACES UNLESS OTHERWISE

COORDINATE ALL WORK INDICATED ON THIS DRAWING WITH THAT OF OTHER TRADES.

ALL FINISH COLORS TO BE SELECTED BY ARCHITECT FROM SUBMITTALS BY CONTRACTOR OF MANUFACTURER'S FULL RANGE OF SPECIFIED PRODUCTS.

FF&E IS <u>NOT INCLUDED</u> IN THIS CONTRACT.

SEE P-SERIES DWGS FOR FIXTURE DESIGNATIONS AND PLUMBING REQUIREMENTS.

SEE SPECIFICATIONS FOR FIXTURE AND MATERIAL INFORMATION.

PROVIDE WOOD BLOCKING BEHIND ALL WALL-MOUNTED FIXTURES AND ACCESSORIES AS REQUIRED TO PROVIDE SUPPORT FOR UP TO 250 POUNDS.


ANY PORTION OF CONCRETE SLAB THAT IS REMOVED MUST BE PATCHED/INFILLED PER

STRUCTURAL DRAWINGS.

THE CONTRACTOR SHALL RESTORE ALL DISTURBED SURFACES TO ORIGINAL OR BETTER CONDITION INCLUDING 6 INCHES OF TOPSOIL, SEED, FERTILIZER, AND MULCH. OTHER SURFACES SHALL BE RESTORED AS SHOWN ON THE DETAILS.

EXISTING UTILITIES (PIPE/STRUCTURE LOCATIONS, SIZES, AND INVERT ELEVATIONS SHOWN ON THESE PLANS HAVE BEEN PLOTTED FROM FIELD SURVEYS AND RECORDED MAPS AND SHALL BE INTERPRETED AS APPROXIMATE ONLY. THE CONTRACTOR IS RESPONSIBLE FOR DETERMINING AND FIELD VERIFYING ALL EXISTING INFORMATION AT ALL LOCATIONS IN CLOSE PROXIMITY TO THE UTILITIES AND WORK UNDER CONSTRUCTION. SEE C-SERIES DRAWINGS FOR MORE INFORMATION.

THESE DOCUMENTS, SUBMITTED FOR THE SPECIFIC PROJECT NAMELY LANFORD HOUSE EXTERIOR REHAB, STATE UNIVERSITY OF NEW YORK AT FREDONIA, FREDONIA, NEW YORK ARE AN INSTRUMENT OF SERVICE AND ARE NOT TO BE ALTERED, COPIED, OR USED FOR ANY OTHER PROJECT WITHOUT THE EXPRESSED WRITTEN PERMISSION OF FLYNN BATTAGLIA ARCHITECTS, DPC. IT IS A VIOLATION OF THE LAW FOR ANY PERSON, UNLESS UNDER THE DIRECTION OF A LICENSED ARCHITECT OR ENGINEER, TO ALTER ANY ITEMS IN THESE DOCUMENTS IN ANY WAY. IF ANY ITEM IS ALTERED, THE ALTERING ARCHITECT/ENGINEER SHALL AFFIX HIS/HER SEAL ALONG WITH THE NOTATION "ALTERED BY" FOLLOWED BY HIS/HER SIGNATURE AND THE DATE OF SUCH ALTERATION, AND A SPECIFIC DESCRIPTION OF THE ALTERATION. COPYRIGHT 2024 FLYNN BATTAGLIA ARCHITECTS, DPC, ALL RIGHTS RESERVED.

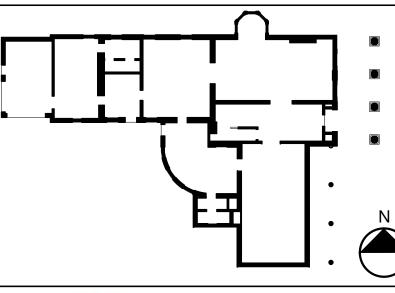



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PROJECT NO. 051037 LANFORD REHAB PHASE II EXTERIOR

194 CENTRAL AVENUE FREDONIA, NEW YORK 14063

100% CONSTRUCTION DOCUMENT SET

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Revision Number	Date	Description


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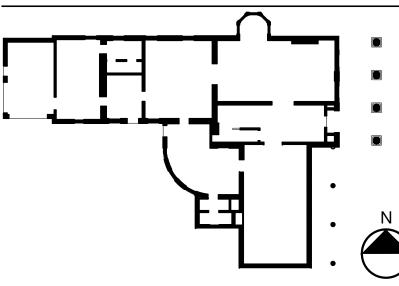
Drawing Title

HOUSE ROOF PLAN

Drawing Number

A1-02



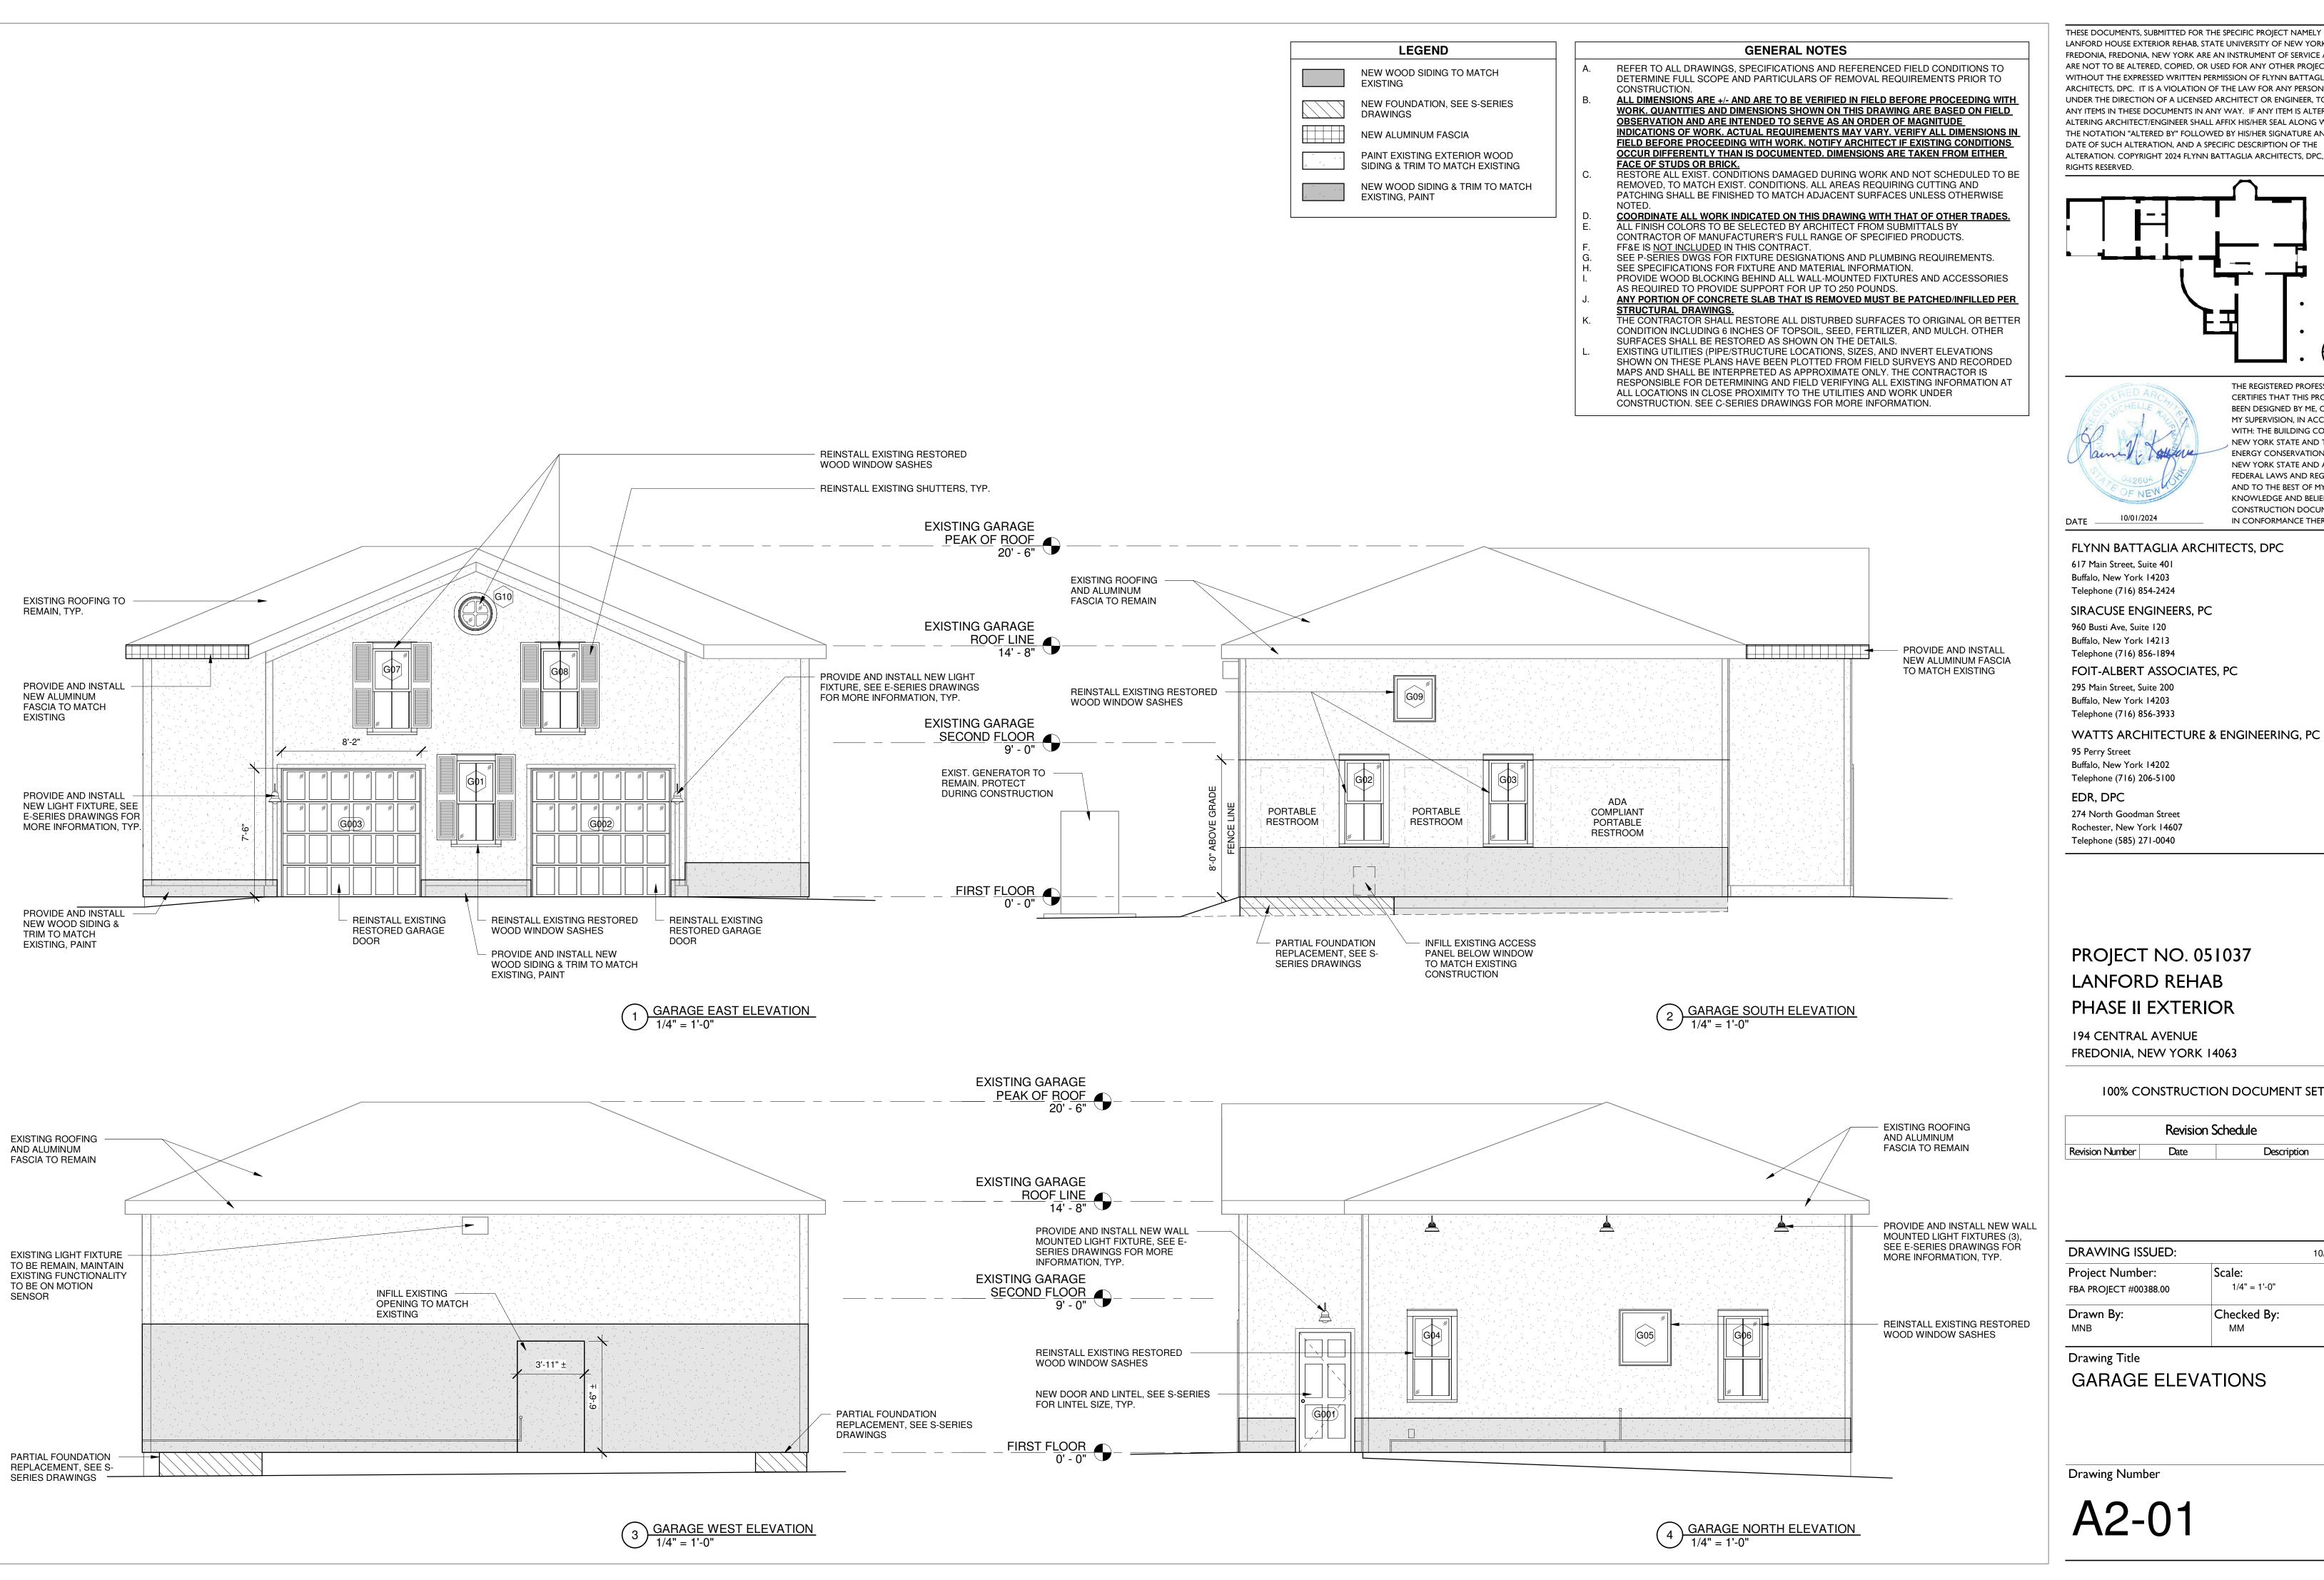

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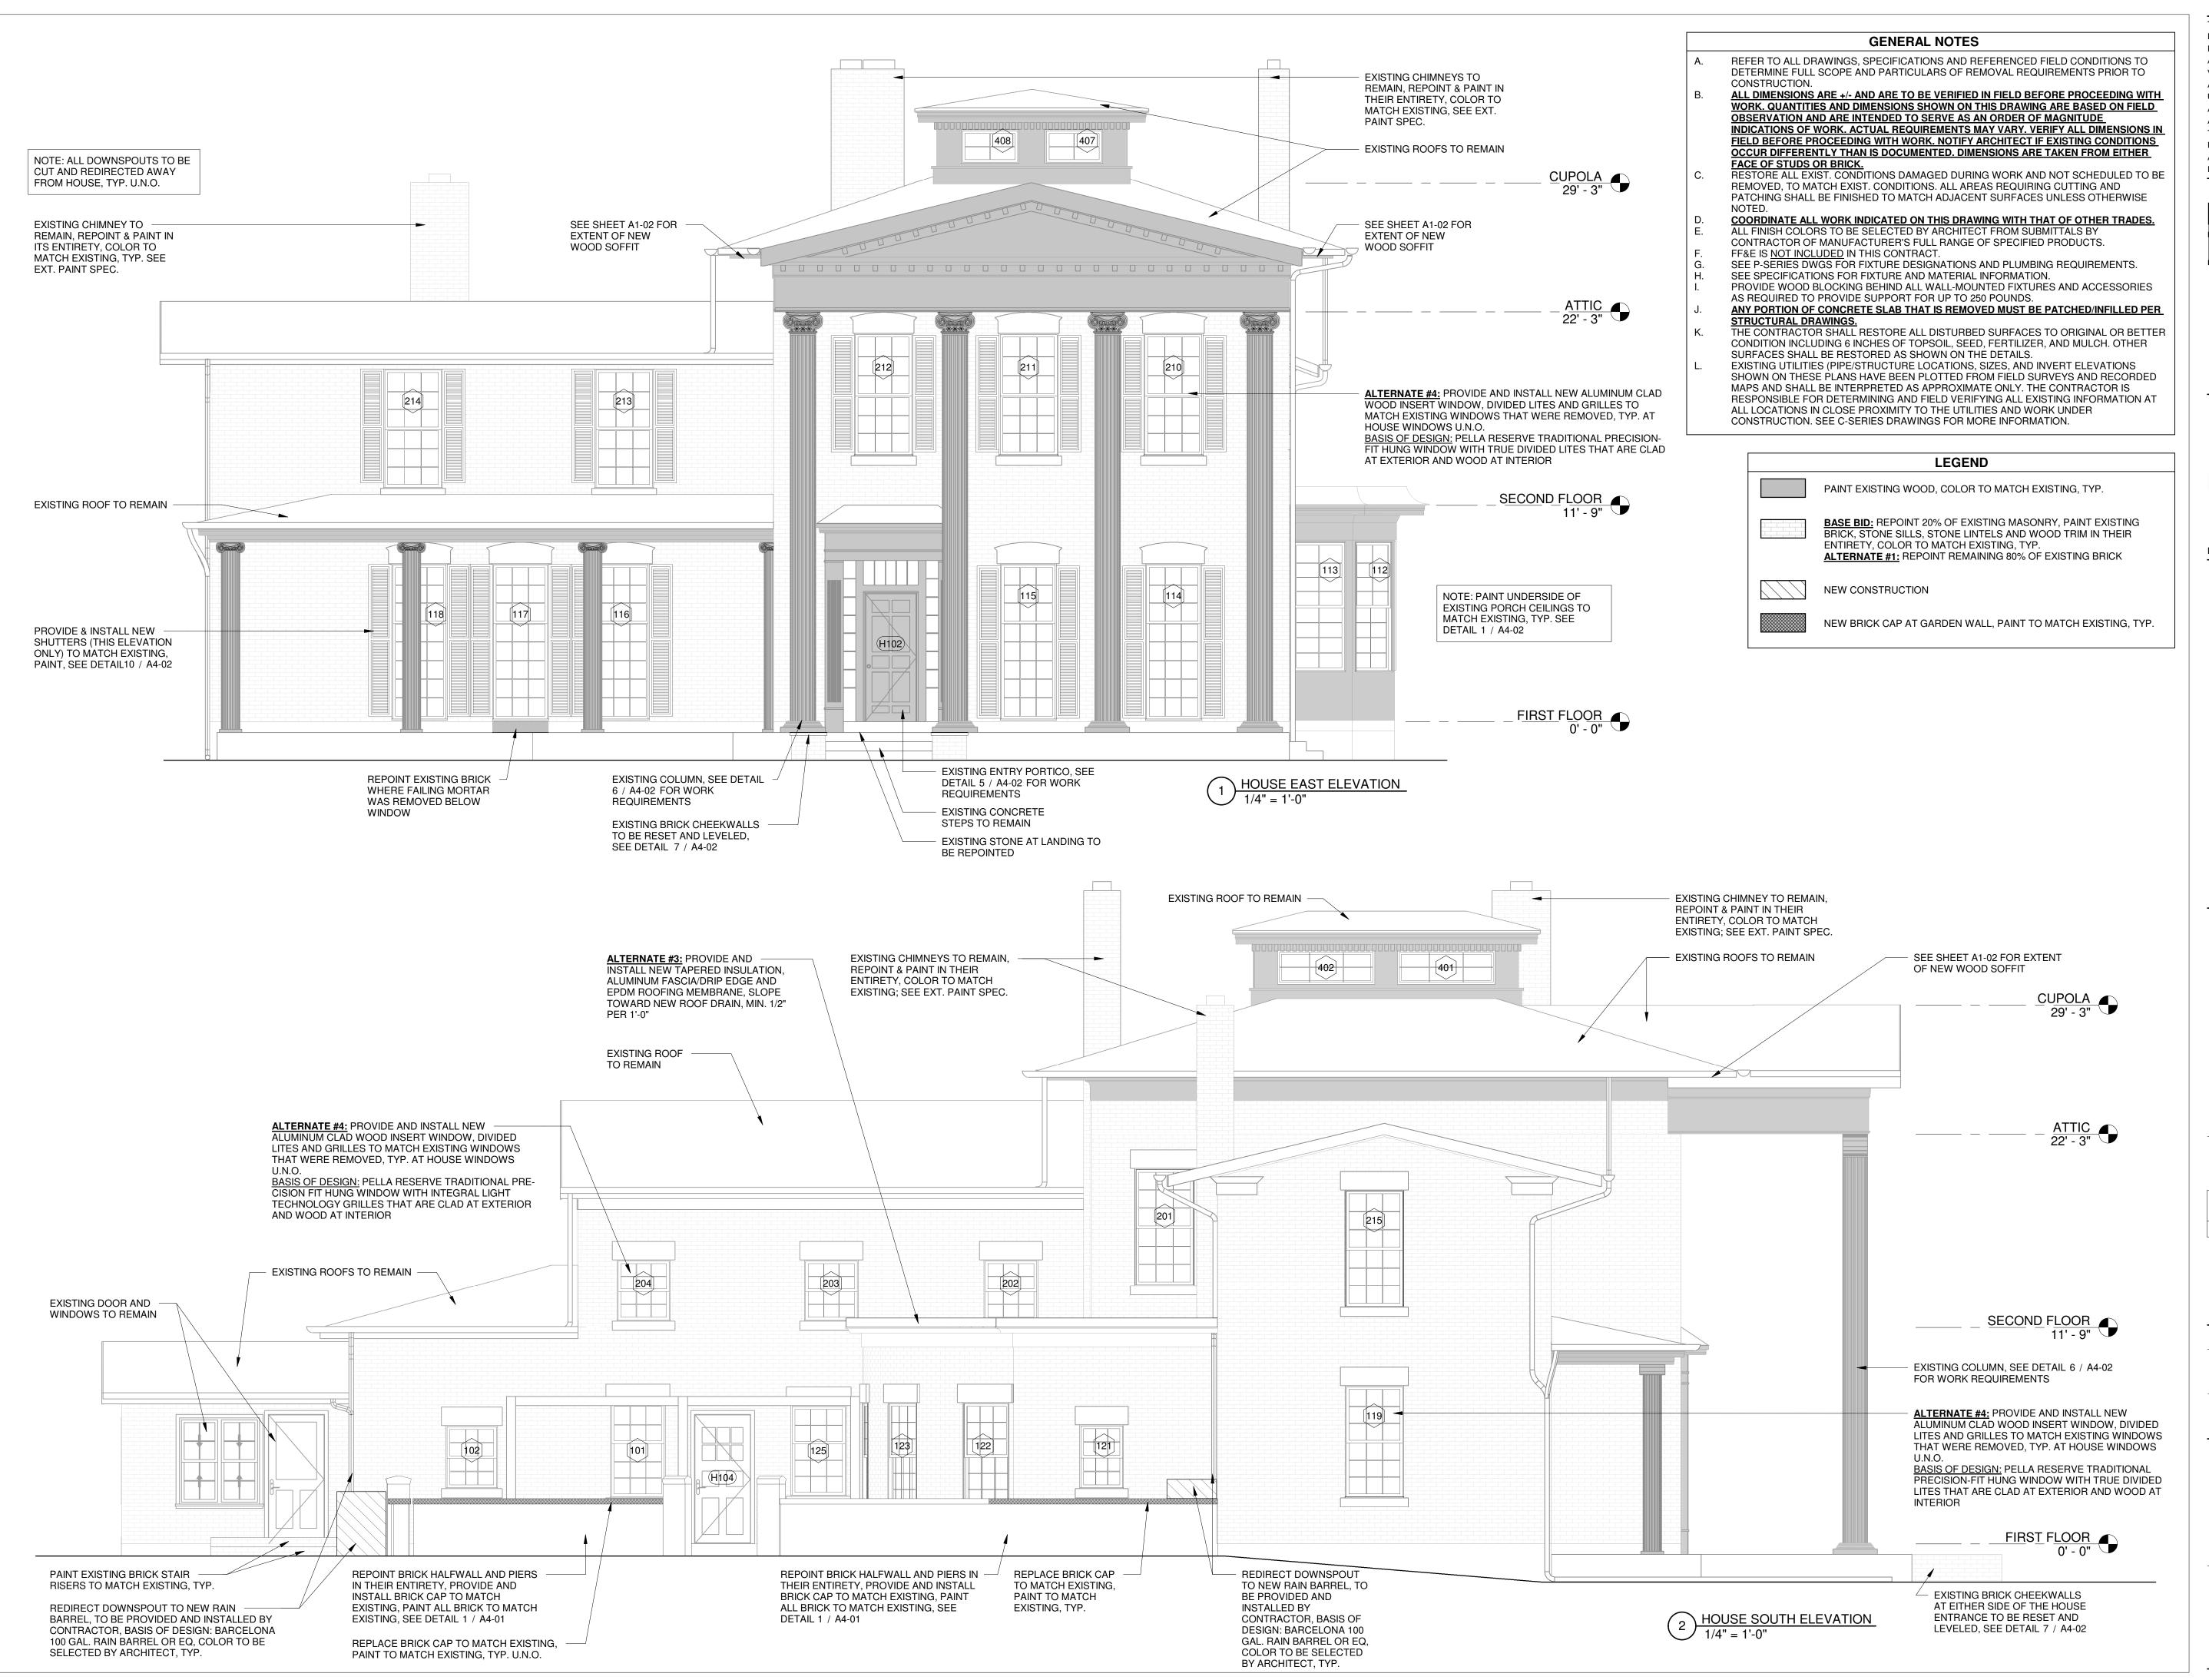
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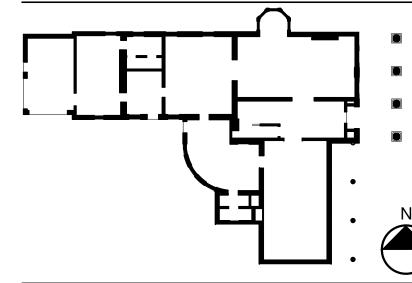
Revision Schedule		
Revision Number	Date	Description

DRAWING ISSUED:	10/1/2024
Project Number: FBA PROJECT #00388.00	Scale: 1/4" = 1'-0"
Drawn By:	Checked By:

Drawing Title

GARAGE ELEVATIONS





DATE 10/01/2024

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194 CENTRAL AVENUE FREDONIA, NEW YORK 14063

100% CONSTRUCTION DOCUMENT SET

Revision Schedule		
Revision Number	Date	Description

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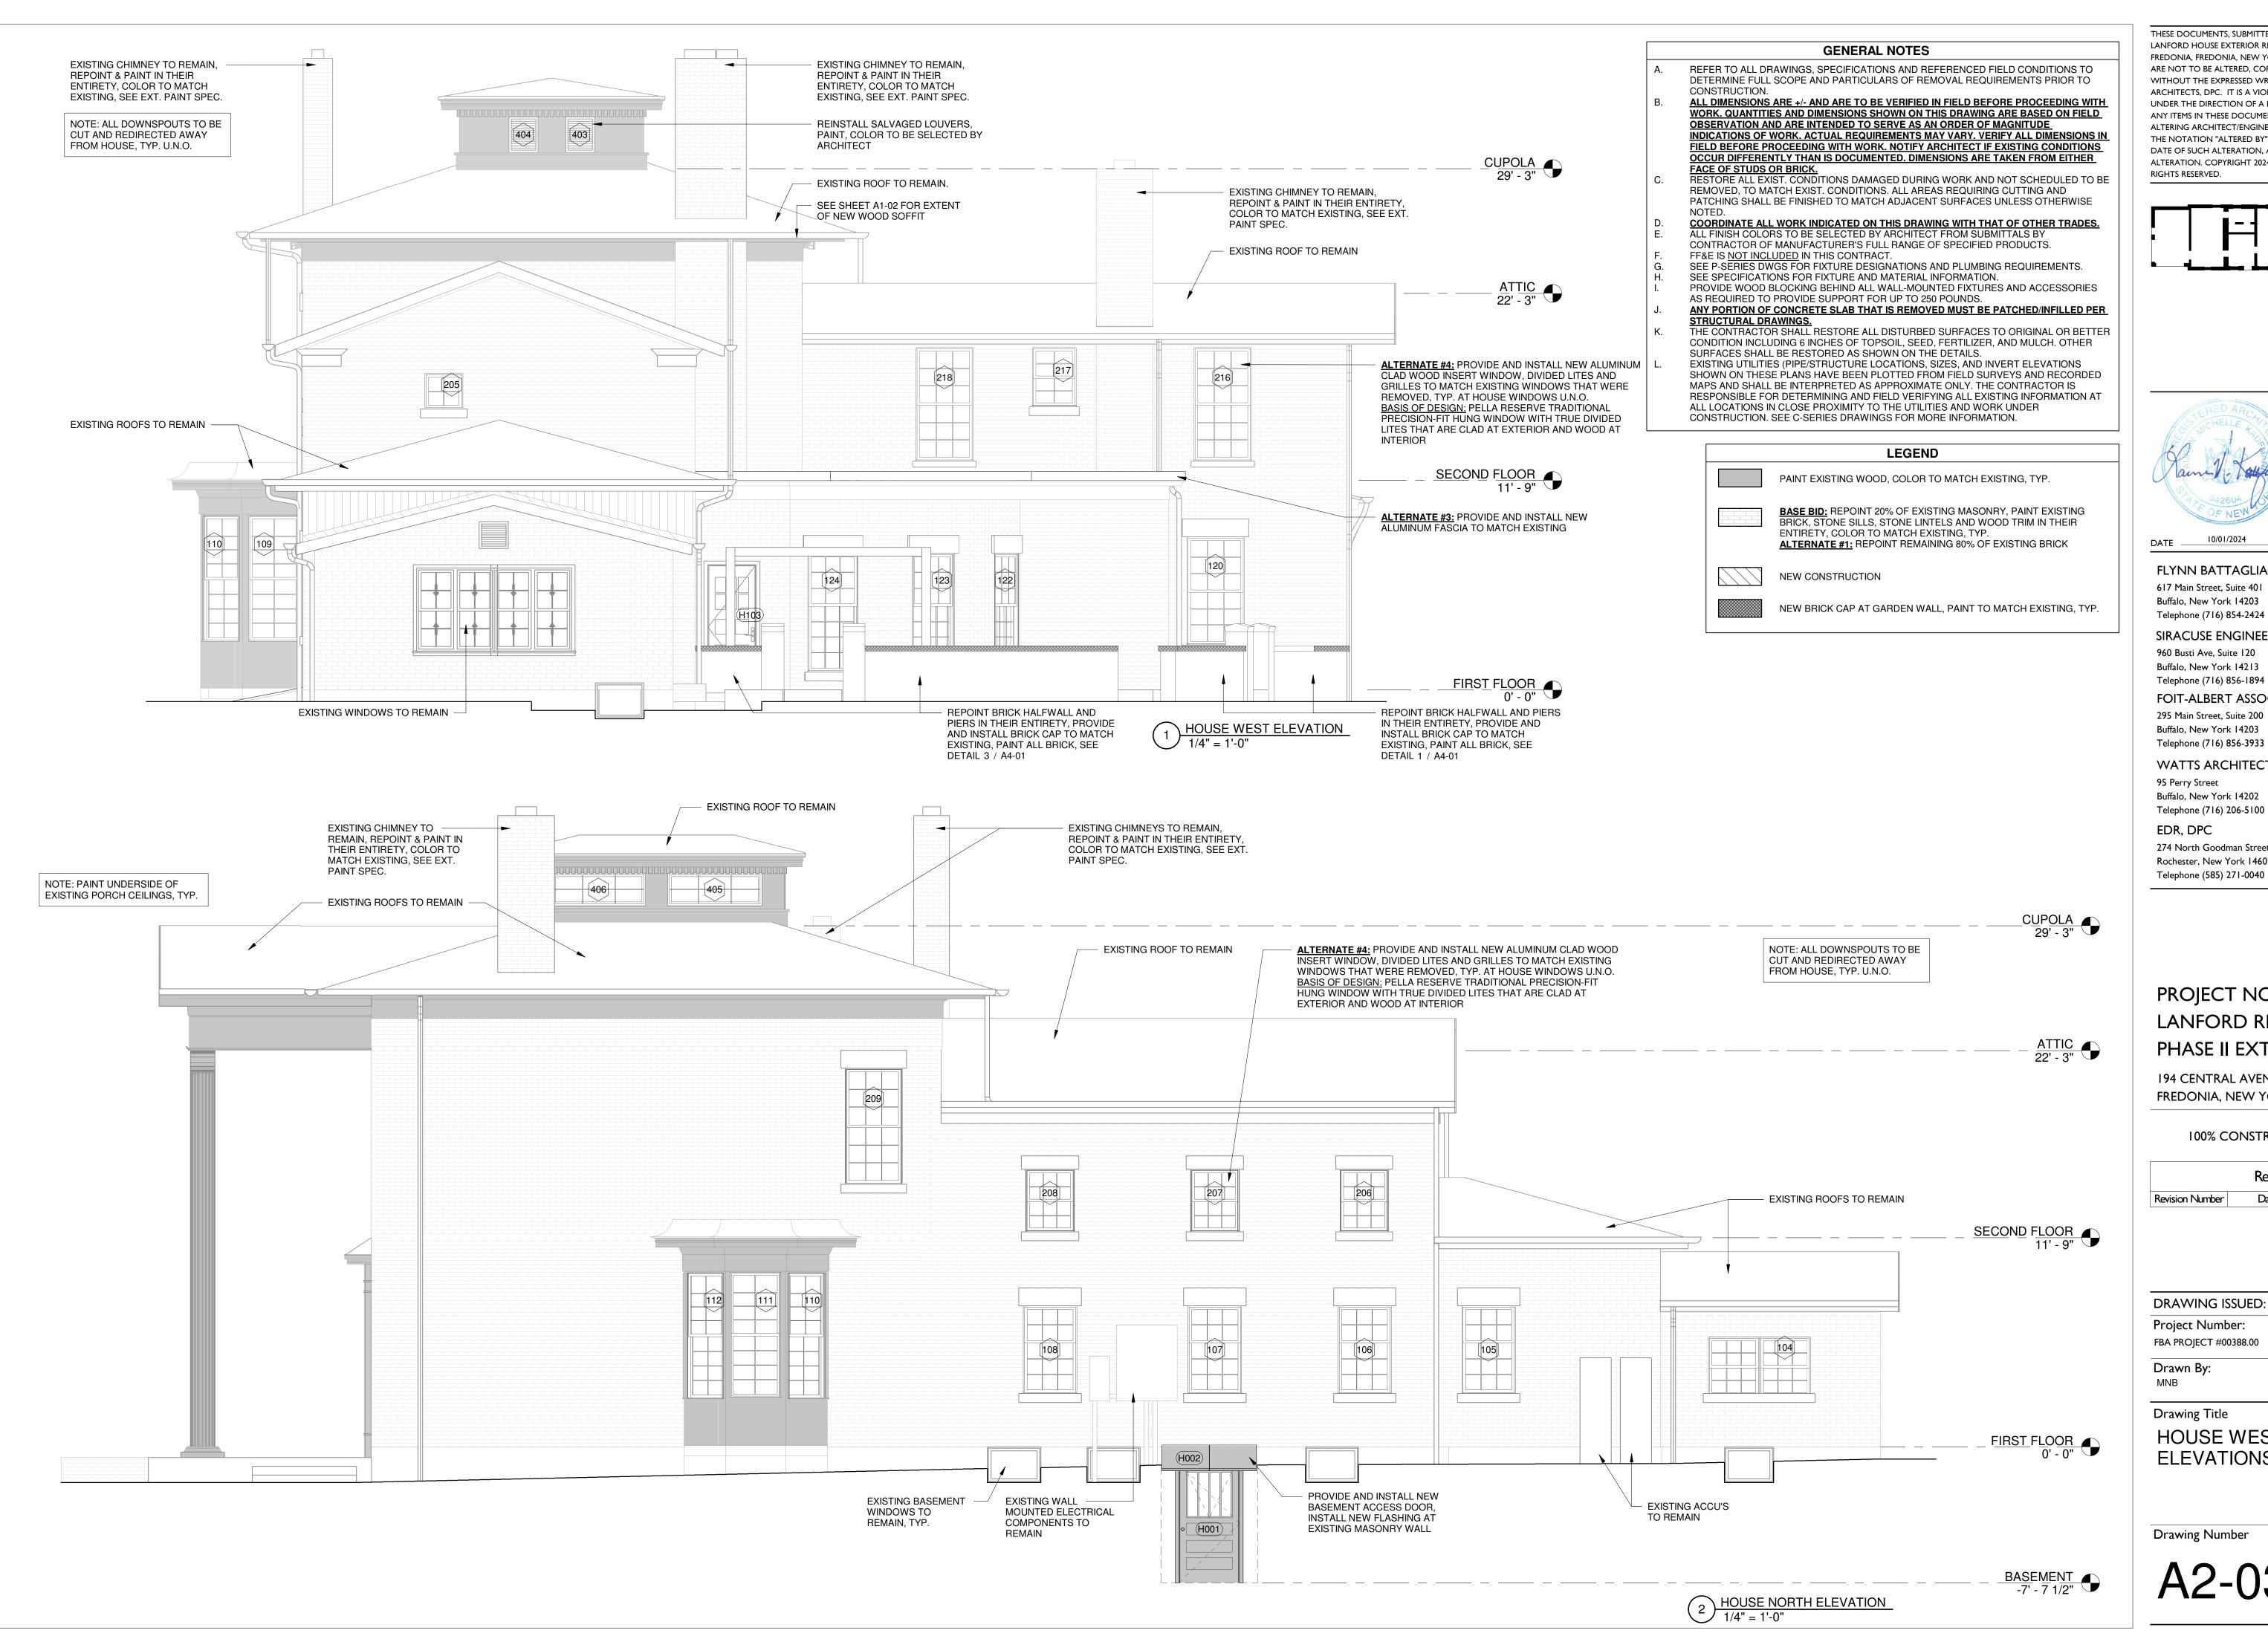
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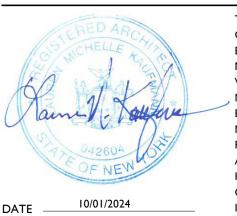
HOUSE EAST AND SOUTH ELEVATIONS

Drawing Number

A2-02



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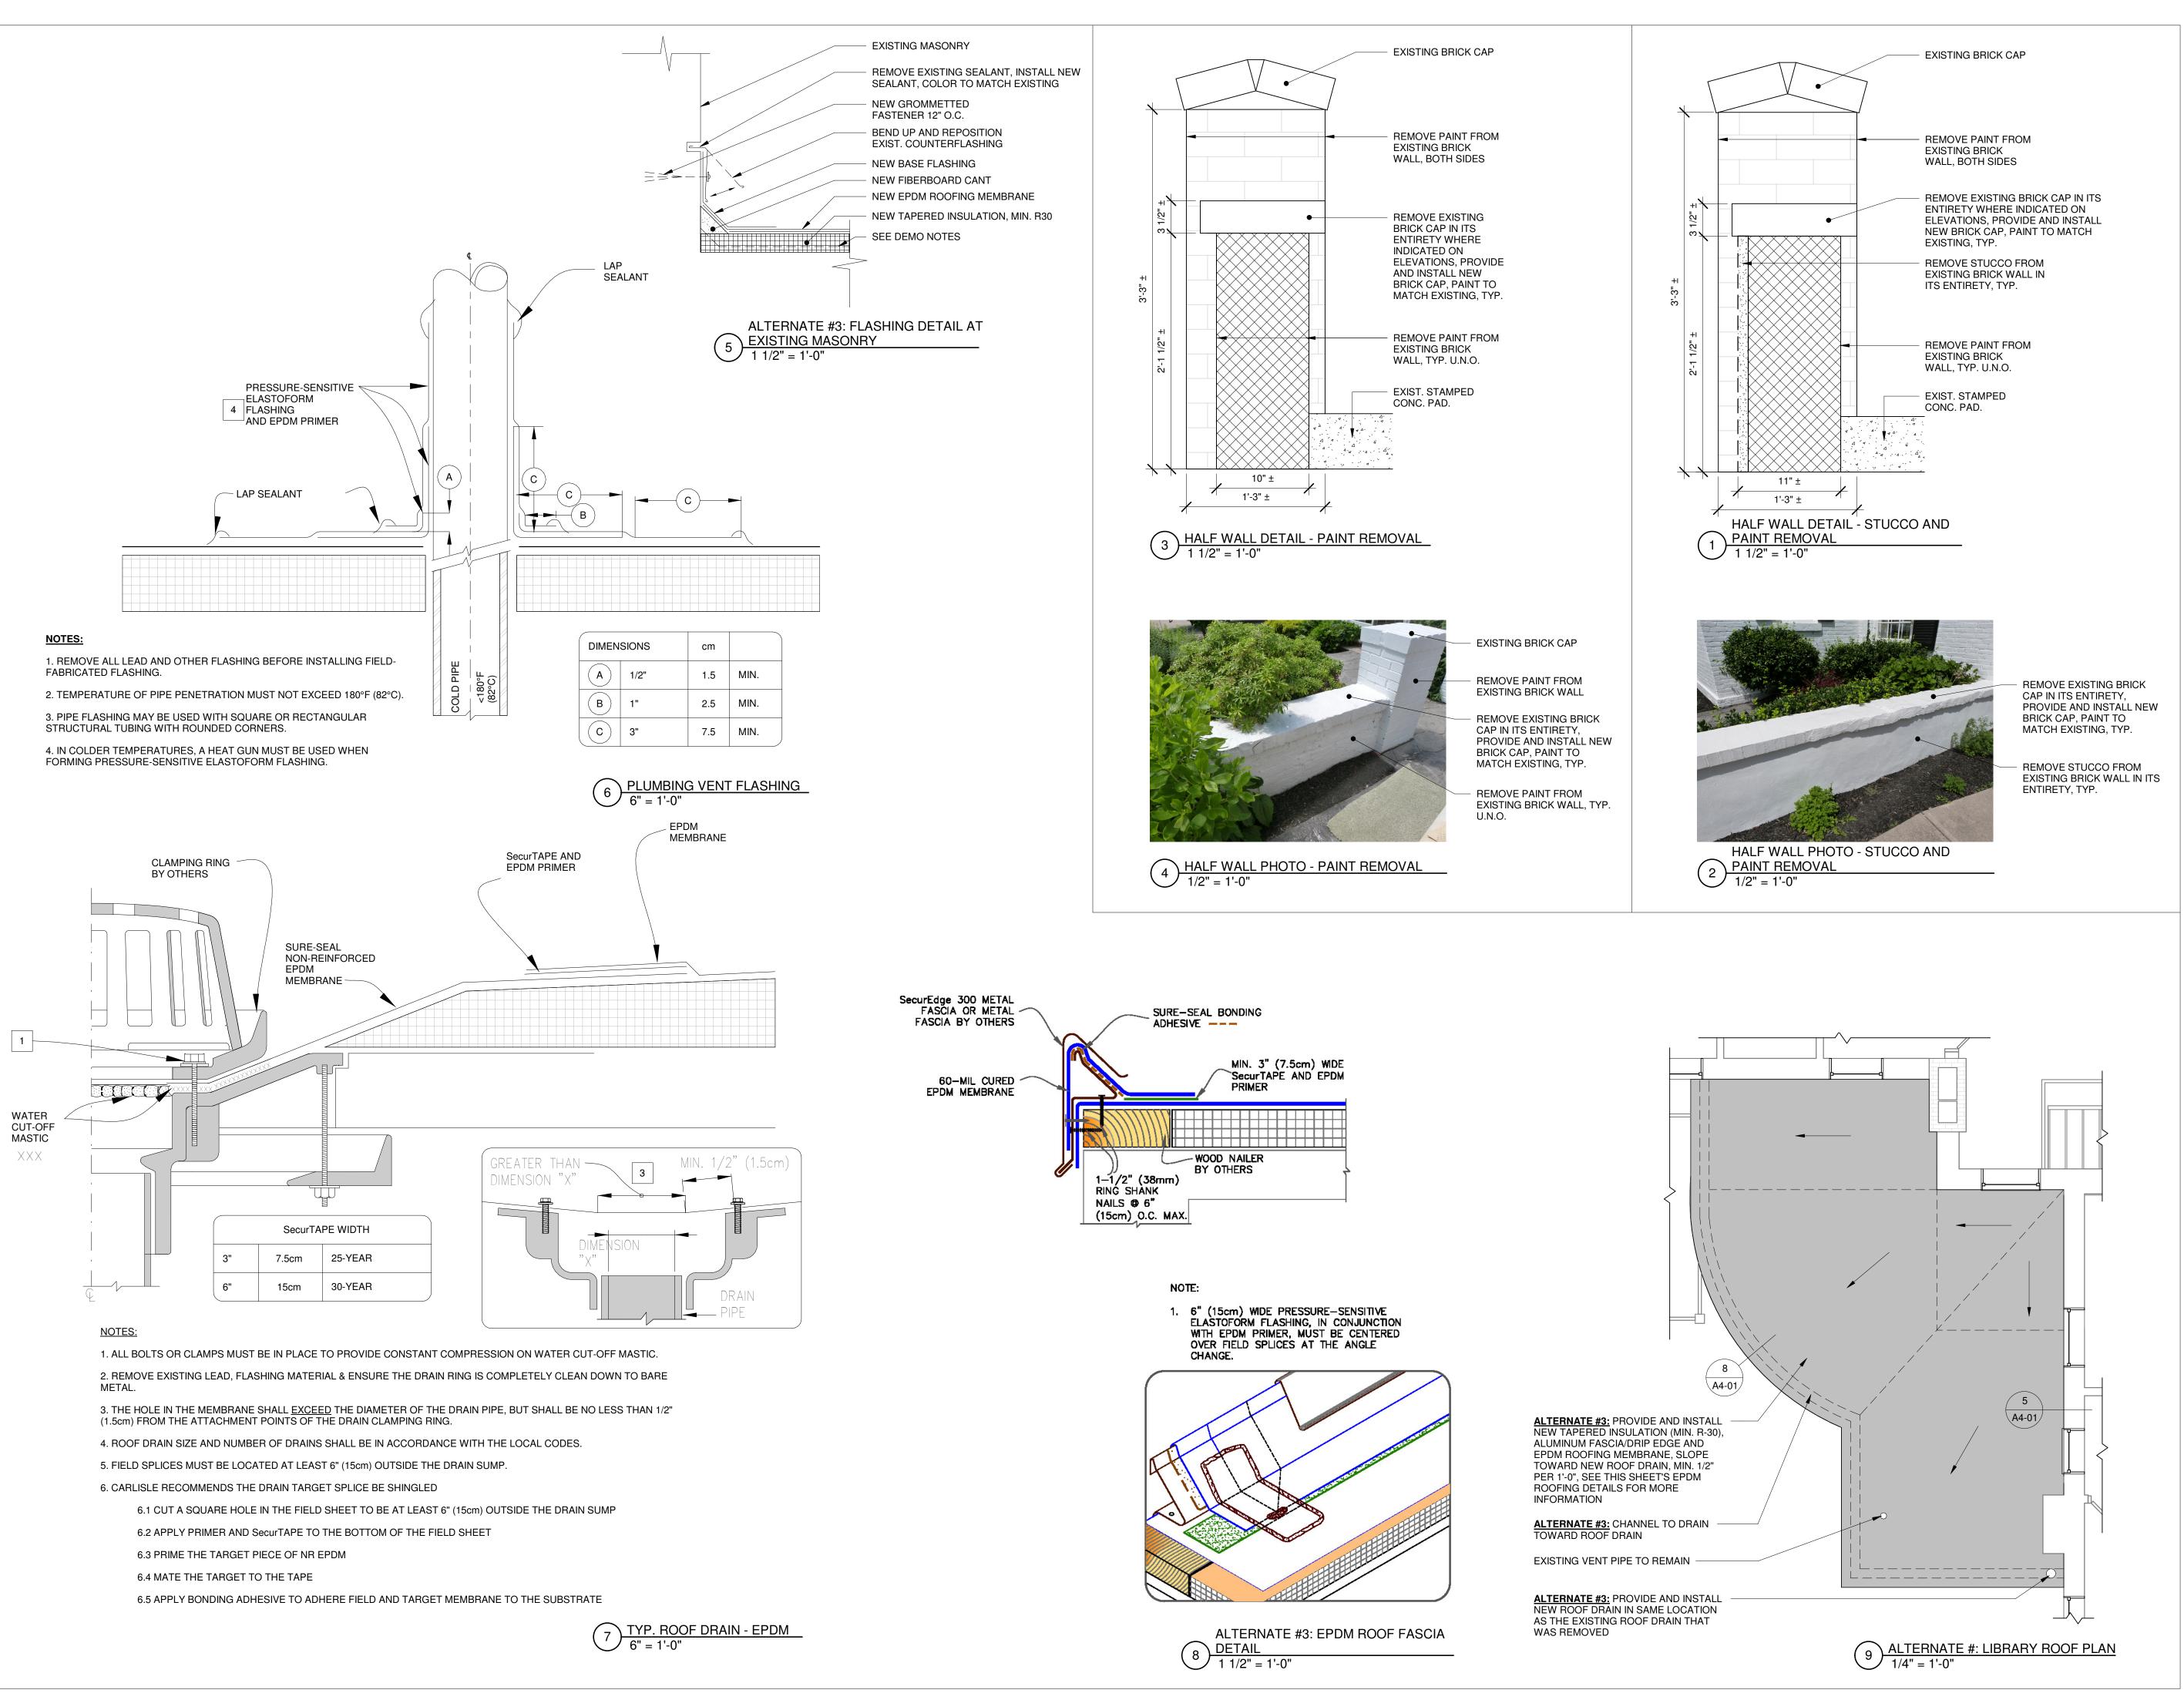
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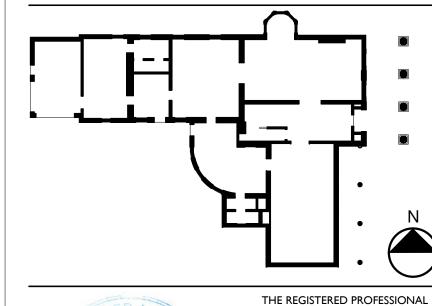
Revision Schedule		
Revision Number	Date	Description

DRAWING ISSUED: 10/1/2024 Scale: Project Number: 1/4" = 1'-0" FBA PROJECT #00388.00 Drawn By: Checked By:

Drawing Title

HOUSE WEST AND NORTH **ELEVATIONS**





DATE 10/01/2024

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194 CENTRAL AVENUE FREDONIA, NEW YORK 14063

100% CONSTRUCTION DOCUMENT SET

	Revision Sch	nedule
Revision Number	Date	Description

Project Number:

FBA PROJECT #00388.00

Drawn By:
MNB

Checked By:
MM

Drawing Title

HOUSE EXTERIOR DETAILS

Drawing Number

A4-01




EXISTING CHIMNEYS TO REMAIN, CHEMICALLY REMOVE EXISTING PAINT IN ITS ENTIRETY, REPOINT & REPAINT BRICK TO MATCH **EXISTING**

REMOVE EXISTING GUTTER AND STORE FOR REINSTALLATION AFTER COMPLETION OF WORK

REMOVE EXISTING DAMAGED WOOD SOFFIT, REPLACE TO MATCH EXISTING, PAINT TO MATCH EXISTING, TYP.

CAREFULLY REMOVE EXISTING WOOD TRIM, RESTORE AND REINSTALL, TYP.



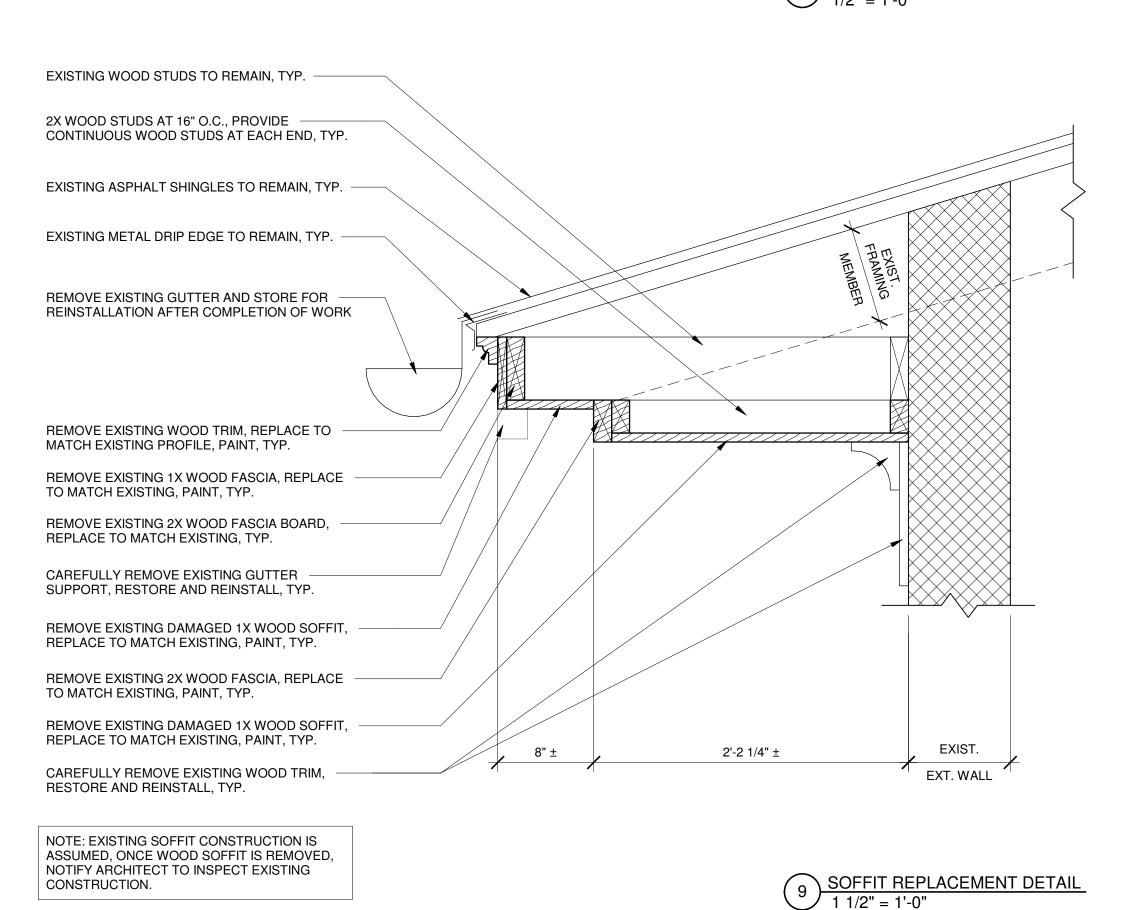



EXISTING CHIMNEYS TO REMAIN, CHEMICALLY REMOVE EXISTING PAINT IN ITS ENTIRETY, REPOINT & REPAINT BRICK TO MATCH EXISTING

REMOVE EXISTING PAINT & REPAINT TO MATCH EXISTING, SEE DETAILS ON THIS SHEET & HM-SERIES DRAWINGS FOR MORE INFORMATION


ALTERNATE #?: CHEMICALLY REMOVE PAINT AT EXISTING MASONRY, STONE SILLS, LINTELS AND TRIM, SEE HM-SERIES DRAWINGS FOR MORE INFORMATION, TYP. REPAINT TO MATCH EXISTING

REMOVE EXISTING PAINT &

REPAINT TO MATCH EXISTING,

SEE HM-SERIES DRAWINGS

FOR MORE INFORMATION

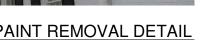

3 PORCH CEILING B 1/2" = 1'-0"



SEE HM-SERIES DRAWINGS FOR MORE INFORMATION

LEGEND FOR PORCH REFLECTED CEILING PLAN

COLOR TO MATCH EXISTING, TYP.

REMOVE EXISTING PAINT AT UNDERSIDE OF

EXISTING PORCH CEILINGS, SEE SPEC SECTIONS

028333: "REMOVAL OF LEAD CONTAINING MATERIAL"


090190 "MAINTENANCE OF PAINTING AND COATING"

AND 099113 "EXTERIOR PAINTING" FOR COMPLETE

PREPARATION AND PAINTING PRECEDURES, SEE

HM-SERIES DRAWINGS FOR MORE INFORMATION. PAINT UNDERSIDE OF EXISTING PORCH CEILINGS,



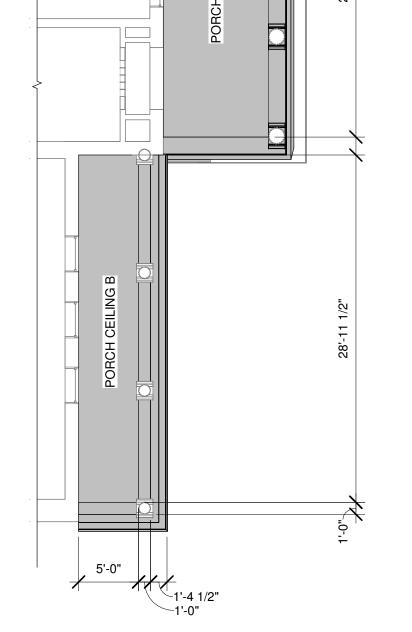

1) PORCH REFLECTED CEILING PLAN 1/8" = 1'-0"

REMOVE EXIST. PAINT & REPAINT TO MATCH EXIST. REPAIR WOOD

EXIST, SEE HM-SERIES DRAWINGS

EXIST. ENTRY DOOR, TRANSOM, & SIDELIGHTS TO REMAIN. CLEAN

GLAZING. REMOVE PAINT FROM

MATCH EXIST, SEE HM-SERIES


FRAME & TRIM, REPAINT TO

DRAWINGS FOR MORE


INFORMATION

TRIM AS REQUIRED TO MATCH

FOR MORE INFORMATION

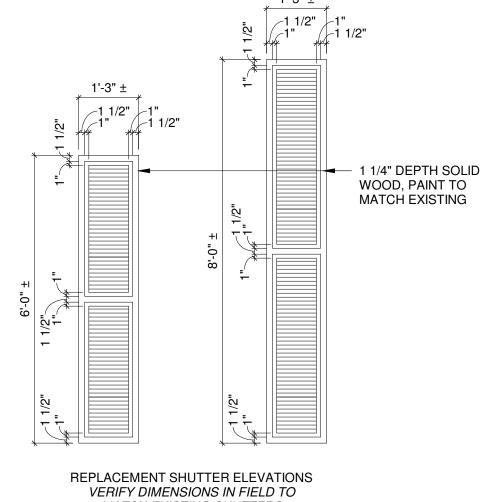

MATCH EXISTING SHUTTERS 10 SHUTTER DETAIL
1/2" = 1'-0"

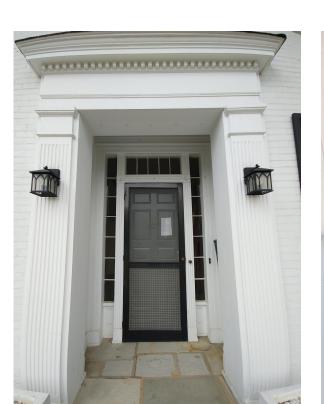

5 ENTRY PORTICO DETAIL
1/2" = 1'-0"

FREDONIA, NEW YORK 14063 100% CONSTRUCTION DOCUMENT SET

Revision Schedule



REMOVE EXIST. PAINT & REPAINT TO MATCH EXIST. REPAIR WOOD TRIM AS REQUIRED TO MATCH EXIST. TYP. FOR ALL (8) COLUMNS, SEE HM-SERIES DRAWINGS FOR MORE INFORMATION






REMOVE EXIST. PAINT & REPAINT TO MATCH EXIST. REPAIR WOOD TRIM AS REQUIRED TO MATCH EXIST. TYP. FOR ALL (8) COLUMNS, SEE HM-SERIES DRAWINGS FOR MORE INFORMATION

DUE TO THE LACK OF A PROPER FOUNDATION THE EXISTING BRICK CHEEKWALLS AT EITHER SIDE OF THE HOUSE ENTRANCE, BOTH NEED TO BE LEVELED AND REPOINTED



7 CHEEKWALL DETAIL
1/2" = 1'-0"

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MY SUPERVISION, IN ACCORDANCE WITH: THE BUILDING CODE OF NEW YORK STATE AND THE ENERGY CONSERVATION CODE OF NEW YORK STATE AND APPLICABLE FEDERAL LAWS AND REGULATIONS AND TO THE BEST OF MY KNOWLEDGE AND BELIEF, THESE CONSTRUCTION DOCUMENTS ARE IN CONFORMANCE THEREWITH.
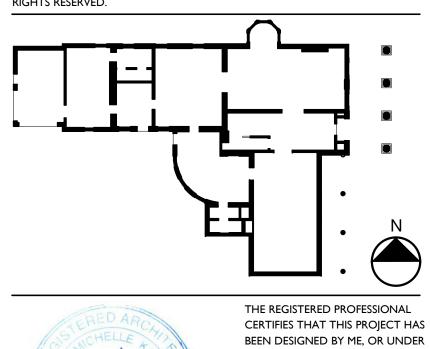
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PROJECT NO. 051037 LANFORD REHAB PHASE II EXTERIOR

194 CENTRAL AVENUE

evision Number	Date	Description
		<u> </u>

Scale: Project Number: As indicated FBA PROJECT #00388.00 Drawn By: Checked By:

10/1/2024

Drawing Title

DRAWING ISSUED:

HOUSE EXTERIOR DETAILS

GENERAL NOTE:

1. DOOR, WINDOW & FRAME SIZES ARE TO BE VERIFIED IN FIELD. ANY CONDITIONS MAKING INSTALLATION OF REPLACEMENT DOORS/WINDOWS DIFFICULT AND/OR IMPOSSIBLE SHALL BE REPORTED TO THE ARCHITECT IMMEDIATELY.

SPECIFIC NOTES FOR GARAGE WINDOWS ONLY

- CAREFULLY REMOVE PAINT AT EXIST. WOOD WINDOWS AND SHUTTERS IN THEIR ENTIRETY. SEE HM-SERIES DRAWINGS FOR MORE INFORMATION.
 PREP, PRIME AND PAINT WINDOW. PAINT EDGES OF WINDOW TRIM SAME
- COLOR AS FACE.

 REPLACE BROKEN WINDOW HARDWARE IN KIND. PREP, PRIME AND PAINT
- WINDOW. PAINT EDGES OF WINDOW TRIM SAME COLOR AS FACE.

 4. REPLACE WOOD STOPS AT EACH WINDOW TO MATCH EXISTING, PAINT TO MATCH EXISTING, TYP.

SPECIFIC NOTES FOR HOUSE WINDOWS ONLY - ALTERNATE #4


CAREFULLY REMOVE PAINT AT EXIST. WINDOW FRAME AND TRIM THAT IS TO REMAIN IN ITS ENTIRETY. SEE HM-SERIES DRAWINGS FOR MORE INFORMATION. PREP, PRIME AND PAINT EXISTING WINDOW FRAMES AND TRIM TO MATCH EXISTING.

DR WIDTH PER SCHED.	DOOR WIDTH PER SCHED.	DOOR WIDTH PER SCHED.	DOOR WIDTH PER SCHED.	DOOR WIDTH PER SCHED.	DOOR WIDTH PER SCHED.
TYPE A EXISTING WOOD/GLASS DOOR	TYPE B NEW WOOD DOOR	TYPE C EXISTING WOOD/GLASS DOOR	TYPE D NEW METAL DOOR	TYPE E EXISTING WOOD DOOR	TYPE F EXISTING WOOD/GLASS DOOR
					1 DOOR TYPES 1/4" = 1'-0"

			WINDOW SCHEDULE				
WINDOW NUMBER	LOCATION	DIMENSIONS-W (JAMB TO JAMB) X H (SILL TO HEADER)	MATERIAL	WINDOW TYPE	DIVIDED LIGHT CONFIGURATION	SILL	SILL HEIGHT
101	BUTLER'S PANTRY	3'-1/2" X 5'-1"±	ALUMINUM CLAD WOOD	DH	6 OVER 9	PLAM. COUNTER	31.25"±
102	KITCHEN	2'-3" X 3'-5"±	ALUMINUM CLAD WOOD	DH	6 OVER 6	PTD. WD.	39.75"±
104	FAMILY ROOM	(2'-9" X 3'-5"±)X2	ALUMINUM CLAD WOOD	DH	6 OVER 6	PTD. WD.	39.5"±
105	KITCHEN	2'-9 5/8" X 4'-11"±	ALUMINUM CLAD WOOD	DH	6 OVER 9	PTD. WD.	31.5"±
106	CORRIDOR	3'-1/2" X 5'-1/2"±	ALUMINUM CLAD WOOD	DH	6 OVER 9	PTD. WD.	30.5"±
107	DINING	2'-9 1/2" X 5'-1"±	ALUMINUM CLAD WOOD	DH	6 OVER 9	PTD. WD.	30.5"±
108	DINING	2'-9 1/2" X 5'-1"±	ALUMINUM CLAD WOOD	DH	9 OVER A/C	PTD. WD.	30.5"±
109	SITTING ROOM	2'-3" X 7'-2"±	ALUMINUM CLAD WOOD	DH	8 OVER 8	PTD. WD.	22.5"±
110	SITTING ROOM	2'-3 1/4" X 7'-2"±	ALUMINUM CLAD WOOD	DH	8 OVER 8	PTD. WD.	22.5"±
111	SITTING ROOM	2'-3 1/4" X 7'-2"±	ALUMINUM CLAD WOOD	DH	8 OVER 8	PTD. WD.	22.5"±
112	SITTING ROOM	2'-3 1/4" X 7'-2"±	ALUMINUM CLAD WOOD	DH	8 OVER 8	PTD. WD.	22.5"±
113	SITTING ROOM	2'-3" X 7'-2"±	ALUMINUM CLAD WOOD	DH	8 OVER 8	PTD. WD.	22.5"±
114	PARLOR	2'-9 1/2" X 8'-7"±	ALUMINUM CLAD WOOD	DH	9 OVER 15		
115	PARLOR	2'-9 1/2" X 8'-7"±	ALUMINUM CLAD WOOD	DH	9 OVER 15		
116	STATE ROOM	2'-9 1/2" X 8'-8"±	ALUMINUM CLAD WOOD	DH	9 OVER 15		
117	STATE ROOM	2'-9 1/2" X 8'-8"±	ALUMINUM CLAD WOOD	DH	9 OVER 15		
118	STATE ROOM	2'-9 1/2" X 8'-8"±	ALUMINUM CLAD WOOD	DH	9 OVER 15	DTD MD	
119	STATE ROOM	2'-10" X 6'-2"±	ALUMINUM CLAD WOOD	DH	9 OVER 9	PTD. WD.	30.5"±
120	STATE ROOM	2'-10" X 6'-2"±	ALUMINUM CLAD WOOD ALUMINUM CLAD WOOD	DH	9 OVER 9	PTD. WD.	30.5"±
121	BATHROOM	2'-2" X 3'-5"±		DH	6 OVER 6	PTD. WD.	45.5"±
122 123	LIBRARY	2'-7 1/2" X 6'-9 1/2"±	ALUMINUM CLAD WOOD ALUMINUM CLAD WOOD	DH DH	9 OVER 12	PTD. WD.	14.5"± 14.5"±
123	LIBRARY	2'-7 1/2" X 6'-9 1/2"± 2'-7 1/2" X 6'-9 1/2"±	ALUMINUM CLAD WOOD ALUMINUM CLAD WOOD	DH	9 OVER 12 9 OVER 12	PTD. WD.	
125	DINING	2'-9 3/4" X 5'-1"±	ALUMINUM CLAD WOOD ALUMINUM CLAD WOOD	DH	9 OVER 12 9 OVER 9	PTD. WD.	14.5"± 29"±
201	STAIR HALL	2'-10" X 6'-7"±	ALUMINUM CLAD WOOD	DH	9 OVER 9	PTD. WD.	29 ±
201	VESTIBULE	2'-9" X 3'-7"±	ALUMINUM CLAD WOOD	DH	6 OVER 6	PTD. WD.	4"±
203	BATHROOM	2'-9" X 3'-5 1/2"±	ALUMINUM CLAD WOOD	DH	6 OVER 6	PTD. WD.	28.5"±
204	OFFICE	2'-9" X 3'-5"±	ALUMINUM CLAD WOOD	DH	6 OVER 6	PTD. WD.	28"±
205	STAIR HALL	NOT ACCESSIBLE	ALUMINUM CLAD WOOD	FIXED	4 LIGHTS/FIXED	PTD. WD.	NOT ACCESS.
206	LAUNDRY	2'-9" X 3'-5 1/2"±	ALUMINUM CLAD WOOD	DH	6 OVER 6	PTD. WD.	28"±
207	BEDROOM	2'-9" X 3'-5"±	ALUMINUM CLAD WOOD	DH	6 OVER 6	PTD. WD.	27"±
208	BEDROOM	2'-9" X 3'-5"±	ALUMINUM CLAD WOOD	DH	6 OVER 6	PTD. WD.	27"±
209	BEDROOM	2'-10" X 6'-6"±	ALUMINUM CLAD WOOD	DH	9 OVER 9	PTD. WD.	24"±
210	BEDROOM	2'-10" X 6'-6"±	ALUMINUM CLAD WOOD	DH	9 OVER 9	PTD. WD.	21"±
211	BEDROOM	2'-10" X 6'-6"±	ALUMINUM CLAD WOOD	DH	9 OVER 9	PTD. WD.	21"±
212	BATHROOM	2'-10" X 6'-6"±	ALUMINUM CLAD WOOD	DH	9 OVER 9	PTD. WD.	22"±
213	HALLWAY	2'-10" X 6'-6"±	ALUMINUM CLAD WOOD	DH	9 OVER 9	PTD. WD.	14"±
214	BEDROOM	2'-10" X 6'-6"±	ALUMINUM CLAD WOOD	DH	9 OVER 9	PTD. WD.	12"±
215	BEDROOM	2'-10" X 6'-6"±	ALUMINUM CLAD WOOD	DH	9 OVER 9	PTD. WD.	13"±
216	BEDROOM	2'-10" X 6'-6"±	ALUMINUM CLAD WOOD	DH	9 OVER 9	PTD. WD.	13.5"±
217	BATHROOM	2'-2 1/2" X 3'-5 1/2"±	ALUMINUM CLAD WOOD	DH	6 OVER 6	PTD. WD.	51"±
218	BEDROOM	2'-10" X 6'-6"±	ALUMINUM CLAD WOOD	DH	9 OVER 9	PTD. WD.	14"±
401	CUPOLA	5'-3.5" X 1'-10"±	ALUMINUM CLAD WOOD	FIXED	6 LIGHTS/FIXED		13.5"±
402	CUPOLA	5'-3.5" X 1'-10"±	ALUMINUM CLAD WOOD	FIXED	6 LIGHTS/FIXED		13.5"±
403	CUPOLA	1'-6" X 1'-8.5"±	EXISTING	LOUVER			12"±
404	CUPOLA	1'-6" X 1'-8.5"±	EXISTING	LOUVER			12"±
405							13.5"±
	CUPOLA	5'-3.5" X 1'-10"±	ALUMINUM CLAD WOOD	FIXED	6 LIGHTS/FIXED		10.0 _
406	CUPOLA CUPOLA	5'-3.5" X 1'-10"± 5'-3.5" X 1'-10"±	ALUMINUM CLAD WOOD ALUMINUM CLAD WOOD	FIXED FIXED	6 LIGHTS/FIXED 6 LIGHTS/FIXED		13.5"±
406 407							
	CUPOLA	5'-3.5" X 1'-10"±	ALUMINUM CLAD WOOD	FIXED	6 LIGHTS/FIXED		13.5"±
407	CUPOLA CUPOLA	5'-3.5" X 1'-10"± 3'-1.5" X 1'-10"±	ALUMINUM CLAD WOOD ALUMINUM CLAD WOOD	FIXED FIXED	6 LIGHTS/FIXED 4 LIGHTS/FIXED		13.5"± 12.5"±
407 408	CUPOLA CUPOLA CUPOLA	5'-3.5" X 1'-10"± 3'-1.5" X 1'-10"± 3'-1.5" X 1'-10"±	ALUMINUM CLAD WOOD ALUMINUM CLAD WOOD ALUMINUM CLAD WOOD	FIXED FIXED FIXED	6 LIGHTS/FIXED 4 LIGHTS/FIXED 4 LIGHTS/FIXED		13.5"± 12.5"± 12.5"±
407 408 G01	CUPOLA CUPOLA CUPOLA GARAGE	5'-3.5" X 1'-10"± 3'-1.5" X 1'-10"± 3'-1.5" X 1'-10"± 2'-4.5" X 5'-0"±	ALUMINUM CLAD WOOD ALUMINUM CLAD WOOD ALUMINUM CLAD WOOD EXISTING WOOD	FIXED FIXED FIXED SH	6 LIGHTS/FIXED 4 LIGHTS/FIXED 4 LIGHTS/FIXED 2 OVER 2	 	13.5"± 12.5"± 12.5"± 36"±
407 408 G01 G02	CUPOLA CUPOLA CUPOLA GARAGE GARAGE	5'-3.5" X 1'-10"± 3'-1.5" X 1'-10"± 3'-1.5" X 1'-10"± 2'-4.5" X 5'-0"± 2'-4.5" X 5'-0"±	ALUMINUM CLAD WOOD ALUMINUM CLAD WOOD ALUMINUM CLAD WOOD EXISTING WOOD EXISTING WOOD EXISTING WOOD EXISTING WOOD EXISTING WOOD	FIXED FIXED SH SH SH SH SH	6 LIGHTS/FIXED 4 LIGHTS/FIXED 4 LIGHTS/FIXED 2 OVER 2 2 OVER 2	 	13.5"± 12.5"± 12.5"± 36"± 36"±
407 408 G01 G02 G03	CUPOLA CUPOLA CUPOLA GARAGE GARAGE GARAGE	5'-3.5" X 1'-10"± 3'-1.5" X 1'-10"± 3'-1.5" X 1'-10"± 2'-4.5" X 5'-0"± 2'-4.5" X 5'-0"± 2'-4.5" X 5'-0"±	ALUMINUM CLAD WOOD ALUMINUM CLAD WOOD ALUMINUM CLAD WOOD EXISTING WOOD EXISTING WOOD EXISTING WOOD	FIXED FIXED SH SH SH SH SH SH FIXED	6 LIGHTS/FIXED 4 LIGHTS/FIXED 4 LIGHTS/FIXED 2 OVER 2 2 OVER 2 2 OVER 2	 	13.5"± 12.5"± 12.5"± 36"± 36"± 36"± 36"± 60"±
407 408 G01 G02 G03 G04 G05 G06	CUPOLA CUPOLA CUPOLA GARAGE GARAGE GARAGE GARAGE GARAGE GARAGE GARAGE	5'-3.5" X 1'-10"± 3'-1.5" X 1'-10"± 3'-1.5" X 1'-10"± 2'-4.5" X 5'-0"±	ALUMINUM CLAD WOOD ALUMINUM CLAD WOOD ALUMINUM CLAD WOOD EXISTING WOOD	FIXED FIXED SH FIXED	6 LIGHTS/FIXED 4 LIGHTS/FIXED 4 LIGHTS/FIXED 2 OVER 2 2 OVER 2 2 OVER 2 2 OVER 2 FIXED 2 OVER 2	 	13.5"± 12.5"± 12.5"± 36"± 36"± 36"± 36"± 60"± 36"±
407 408 G01 G02 G03 G04 G05 G06 G07	CUPOLA CUPOLA CUPOLA GARAGE GARAGE GARAGE GARAGE GARAGE GARAGE GARAGE GARAGE GARAGE	5'-3.5" X 1'-10"± 3'-1.5" X 1'-10"± 3'-1.5" X 1'-10"± 2'-4.5" X 5'-0"± 2'-4.5" X 5'-0"± 2'-4.5" X 5'-0"± 3'-3.5" X 3'-0.5"± 2'-4.5" X 5'-0"± 2'-4.5" X 5'-0"±	ALUMINUM CLAD WOOD ALUMINUM CLAD WOOD ALUMINUM CLAD WOOD EXISTING WOOD	FIXED FIXED SH SH SH SH FIXED SH SH SH SH SH SH SH	6 LIGHTS/FIXED 4 LIGHTS/FIXED 4 LIGHTS/FIXED 2 OVER 2 2 OVER 2 2 OVER 2 2 OVER 2 FIXED 2 OVER 2 2 OVER 2	 	13.5"± 12.5"± 12.5"± 36"± 36"± 36"± 36"± 60"± 36"± 605"±
407 408 G01 G02 G03 G04 G05 G06 G07 G08	CUPOLA CUPOLA CUPOLA GARAGE	5'-3.5" X 1'-10"± 3'-1.5" X 1'-10"± 3'-1.5" X 1'-10"± 2'-4.5" X 5'-0"± 2'-4.5" X 5'-0"± 2'-4.5" X 5'-0"± 3'-3.5" X 3'-0.5"± 2'-4.5" X 5'-0"± 2'-4.5" X 5'-0"±	ALUMINUM CLAD WOOD ALUMINUM CLAD WOOD ALUMINUM CLAD WOOD EXISTING WOOD	FIXED FIXED SH SH SH FIXED SH SH SH SH SH SH SH SH	6 LIGHTS/FIXED 4 LIGHTS/FIXED 4 LIGHTS/FIXED 2 OVER 2 2 OVER 2 2 OVER 2 2 OVER 2 FIXED 2 OVER 2	 	13.5"± 12.5"± 12.5"± 36"± 36"± 36"± 36"± 60"± 36"± 6.5"± 6.5"±
407 408 G01 G02 G03 G04 G05 G06 G07	CUPOLA CUPOLA CUPOLA GARAGE GARAGE GARAGE GARAGE GARAGE GARAGE GARAGE GARAGE GARAGE	5'-3.5" X 1'-10"± 3'-1.5" X 1'-10"± 3'-1.5" X 1'-10"± 2'-4.5" X 5'-0"± 2'-4.5" X 5'-0"± 2'-4.5" X 5'-0"± 3'-3.5" X 3'-0.5"± 2'-4.5" X 5'-0"± 2'-4.5" X 5'-0"±	ALUMINUM CLAD WOOD ALUMINUM CLAD WOOD ALUMINUM CLAD WOOD EXISTING WOOD	FIXED FIXED SH SH SH SH FIXED SH SH SH SH SH SH SH	6 LIGHTS/FIXED 4 LIGHTS/FIXED 4 LIGHTS/FIXED 2 OVER 2 2 OVER 2 2 OVER 2 2 OVER 2 FIXED 2 OVER 2 2 OVER 2	 	13.5"± 12.5"± 12.5"± 36"± 36"± 36"± 36"± 60"± 36"± 6.5"±

	DOOR SCHEDULE											
											Door Hardware	
Door Number	Location	Door Type	Door Width	Door Height	Door Thickness	Door Material	Door Finish	Frame Material	Frame Finish	Existing Conditions Notes	Set	Work Notes
G001	NORTH ENTRANCE TO GARAGE	В	3'-0"	7'-0"	1 3/4"	WOOD	PAINT	WOOD	PAINT	N/A	1.0	NEW WOOD DOOR, NEW HARDWARE
G002	GARAGE DOOR	Α	8'-0"	7'-6"		WOOD	PAINT	WOOD	PAINT	PAINTED WOOD		RESTORE EXISTING DOOR, NEW HARDWARE
G003	GARAGE DOOR	Α	8'-0"	7'-6"		WOOD	PAINT	WOOD	PAINT	PAINTED WOOD		RESTORE EXISTING DOOR, NEW HARDWARE
H001	NORTH ENTRANCE TO BASEMENT	С	3'-6"	5'-7"	1 3/4"	WOOD	PAINT	WOOD	PAINT	PAINTED WOOD	1.0	RESTORE EXISTING DOOR, NEW HARDWARE
H002	HOUSE BASEMENT ACCESS	D	6'-0"	7'-0"		METAL	PREFIN	METAL	PREFIN	N/A		NEW BASEMENT ACCESS DOOR
H102	FRONT ENTRANCE DOOR TO HOUSE	Е	3'-0"	7'-0"	1 3/4"	WOOD	PAINT	WOOD	PAINT	W/ STORM DOOR, PAINTED WOOD	1.0	RESTORE EXISTING DOOR, NEW HARDWARE?, NEW FULL GLASS STORM DOOR?
H103	SOUTH PATIO ENTRANCE	F	3'-0"	7'-0"	1 3/4"	WOOD	PAINT	WOOD	PAINT	W/ STORM DOOR, PAINTED WOOD		NO WORK OR FLIP ORIENTATION?
H104	ENTRANCE TO LIBRARY	F	3'-0"	7'-0"	1 3/4"	WOOD	PAINT	WOOD	PAINT	W/ STORM DOOR, PAINTED WOOD	1.0	RESTORE EXISTING DOOR, NEW HARDWARE

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CERTIFIES THAT THIS PROJECT HAS
BEEN DESIGNED BY ME, OR UNDER
MY SUPERVISION, IN ACCORDANCE
WITH: THE BUILDING CODE OF
NEW YORK STATE AND THE
ENERGY CONSERVATION CODE OF
NEW YORK STATE AND APPLICABLE
FEDERAL LAWS AND REGULATIONS
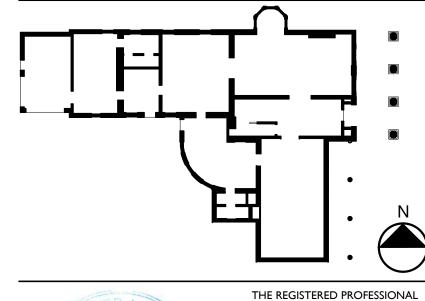
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PROJECT NO. 051037 LANFORD REHAB PHASE II EXTERIOR

194 CENTRAL AVENUE FREDONIA, NEW YORK 14063

100% CONSTRUCTION DOCUMENT SET

Revision Schedule			
Revision Number	Date	Description	

DRAWING ISSUED:		10/1/2024
Project Number: FBA PROJECT #00388.00	Scale: 1/4" = 1'-0"	
Drawn By:	Checked By:	

Drawing Title

GARAGE AND HOUSE WINDOW AND DOOR SCHEDULES

Drawing Number

A6-01

ELECTRICAL SYMBOL LIST

GENERAL					
	EXISTING WIRING OR EQUIPMENT (LIGHT SOLID).				
	NEW WIRING OR EQUIPMENT (HEAVY SOLID).				
	EXISTING WIRING OR EQUIPMENT TO BE REMOVED (DASHED).				
#	DEMOLITION KEYED DRAWING NOTE.				
#	NEW CONSTRUCTION KEYED DRAWING NOTE.				
	AREA LIMIT LINE.				
#	DETAIL CALL OUT. "#" INDICATES DETAIL NUMBER WITHIN IDENTIFIED SHEET, "Y" INDICATES SHEET NUMBER.				

	BRANCH WIRING
1 3 HI LLPB	BRANCH CIRCUIT TO PANELBOARD, WHEN SHOWN, LETTERING INDICATES PANELBOARD DESIGNATIONS. QUANTITY OF ARROWHEADS INDICATE QUANTITY OF BRANCH CIRCUITS. PROTECT EACH BRANCH CIRCUIT WITH A 20 AMPERE, 1-POLE OVERCURRENT DEVICE UNLESS OTHER SIZE INDICATED. TYPICAL DESIGNATION, (2#12,1#12G-3/4"C,20A-1P.)
-# -	RACEWAY OR CABLES IN WALLS, ABOVE CEILINGS, WITH CONDUCTORS AS NOTED.
11 \(\infty \) \[\begin{pmatrix} 32 \\ \ \ \ \ \ \ \ \ \ \ \ \ \ \ \ \ \	ON BRANCH CIRCUITRY WHERE ONLY THE CIRCUIT NUMBER IS SHOWN, CIRCUIT DEVICE/FIXTURE WITH THE SAME NUMBER TO THE CIRCUIT INDICATED WITH A HOMERUN TO EACH NUMBERED GROUP. CONNECT TO A 20A-1P CIRCUIT BREAKER, OR AS NOTED.
	RACEWAY ROUTED UP, SOME NOT SHOWN.
	RACEWAY ROUTED DOWN, SOME NOT SHOWN.
SM	SURFACE MOUNTED RACEWAY.
	CABLE TRAY.
<u></u>	GROUNDING ELECTRODE CONDUCTOR.
<u></u>	JUNCTION BOX, SIZED PER NEC OR AS INDICATED.

LIGHTING					
A,a,1 A,a,1 A,a,1 A,a,1	LIGHTING FIXTURE. UPPER CASE LETTER INDICATES FIXTURE TYPE AS DESCRIBED IN LIGHTING FIXTURE SCHEDULE. LOWER CASE LETTER(S) INDICATE SWITCHING. NUMBER INDICATES CIRCUIT NUMBER OF POWER SOURCE. HATCHING INDICATES AN EMERGENCY POWERED LIGHT FIXTURE.				
A,a,1	EXTERIOR WALL MOUNTED LIGHTING FIXTURE. UPPER CASE LETTER INDICATES FIXTURE TYPE AS DESCRIBED IN LIGHTING FIXTURE SCHEDULE. LOWER CASE LETTER(S) INDICATE SWITCHING. NUMBER INDICATES CIRCUIT NUMBER OF POWER SOURCE. HATCHING INDICATES AN EMERGENCY POWERED LIGHT FIXTURE.				
●	EXTERIOR POLE MOUNTED LIGHT FIXTURE. UPPER CASE LETTER INDICATES FIXTURE TYPE AS DESCRIBED IN LIGHTING FIXTURE SCHEDULE. LOWER CASE LETTER(S) INDICATE SWITCHING. NUMBER INDICATES CIRCUIT NUMBER OF POWER SOURCE. HATCHING INDICATES AN EMERGENCY POWERED LIGHT FIXTURE.				
	EMERGENCY LIGHTING UNIT. REFER TO LIGHTING FIXTURE SCHEDULE FOR ADDITIONAL INFORMATION.				
H⊠	EXIT SIGN, WALL MOUNTED. ARROW(S) INDICATE DIRECTIONAL CHEVRONS. REFER TO LIGHTING FIXTURE SCHEDULE FOR ADDITIONAL INFORMATION.				
\otimes	EXIT SIGN, CEILING MOUNTED.				
®	PHOTOCELL.				
C	LIGHTING CONTACTOR.				

DIST	DISTRIBUTION AND MOTOR EQUIPMENT					
	BRANCH CIRCUIT PANELBOARD. REFER TO PANEL BOARD SCHEDULE.					
	EXISTING BRANCH CIRCUIT PANELBOARD. REFER TO PANEL BOARD SCHEDULE.					
//	ELECTRICAL MOTOR.					
30 [3R] ¹ 20	DISCONNECT SWITCH, 3R INDICATES WEATHERPROOF (NEMA 3R). 30—INDICATES SWITCH AMPERE RATING. 20—INDICATES FUSE SIZE, "" INDICATES NON FUSED.					
\boxtimes	MAGNETIC MOTOR STARTER. VOLTAGE AMPERE RATING AND NEMA SIZE TO MATCH MOTOR SERVED. OVERCURRENT RATING IF INDICATED. NEMA 1 UNLESS OTHERWISE NOTED.					
30 2	COMBINATION MAGNETIC MOTOR STARTER WITH INTEGRAL DISCONNECT. 3R INDICATES WEATHER PROOF (NEMA 3R). 30—INDICATES OVERCURRENT RATING. 00—INDICATES STARTER NEMA SIZE.					
VFD	VARIABLE FREQUENCY DRIVE.					
Ê	EMERGENCY POWER OFF STATION.					
\$ ^{MT} \$ ^M	MOTOR SWITCH. "MT" INDICATES WITH THERMAL OVERLOADS. "M" INDICATES WITHOUT THERMAL OVERLOADS.					
•	PUSH BUTTON STATION.					
+	ELECTRICAL CONNECTION. CONTRACTOR SHALL PROVIDE A COMPLETE CONNECTION INCLUDING ALL REQUIRED FITTINGS AND ACCESSORIES. ELECTRICAL CONNECTION IDENTIFICATION TAG ASSOCIATED WITH ELECTRICAL CONNECTION SYMBOL. REFER TO ASSOCIATED ITEM					
# 4	NUMBER WITHIN THE EQUIPMENT CONNECTION SCHEDULE FOR ADDITIONAL INFORMATION REGARDING ELECTRICAL CONNECTION. COORDINATE REQUIREMENTS WITH OTHER TRADES. EQUIPMENT IDENTIFICATION TAG ASSOCIATED WITH ELECTRICAL					
XX - #	CONNECTION SYMBOL. REFER TO EQUIPMENT CONNECTION SCHEDULE.					

	DEVICES
φ	DUPLEX RECEPTACLE - UPPER CASE LETTERS INDICATE TYPE AS FOLLOWS: IG - ISOLATED GROUND AF - ARC FAULT INTERRUPTER TR - TAMPER RESISTANT SM - SURFACE MOUNTED OC - ABOVE COUNTER WP - WEATHER PROOF BOX TVSS - TRANSIENT VOLTAGE SURGE SUPPRESSION
#	DUPLEX RECEPTACLE, GFCI TYPE.
φ	SINGLE RECEPTACLE.
#	QUAD RECEPTACLE.
•	DUPLEX RECEPTACLE, USB TYPE.
Ф	SWITCHED DUPLEX RECEPTACLE.

NOTE: ABBREVIATIONS AND SYMBOLS ON THIS DRAWING ARE FOR REFERENCE ONLY, AND MAY NOT BE USED IN THE FOLLOWING DOCUMENTS.

ASBESTOS AWARENESS NOTE:

A PRE-RENOVATION ASBESTOS SURVEY HAS BEEN PERFORMED AND A REPORT IS AVAILABLE FOR REVIEW. All CONTRACTORS SHALL BE AWARE THAT ASBESTOS-CONTAINING MATERIALS (ACM) HAVE BEEN IDENTIFIED.

THE LIST IN THE REPORT IS NOT COMPREHENSIVE OF ALL ACM WITHIN THE BUILDING. ALL CONTRACTORS ARE RESPONSIBLE FOR MAKING THEMSELVES AND THEIR EMPLOYEES AWARE OF THE PRESENCE, LOCATION, AND QUANTITY OF EXISTING ASBESTOS-CONTAINING BUILDING MATERIALS, AND TO WARN THEIR EMPLOYEES OF THE POTENTIAL DANGERS OF EXPOSURE TO ASBESTOS.

ANY DISTURBANCE OF ASBESTOS-CONTAINING MATERIALS SHALL BE PERFORMED AS AN ASBESTOS ABATEMENT PROJECT UTILIZING A LICENSED ASBESTOS ABATEMENT CONTRACTOR EMPLOYING CERTIFIED WORKERS IN ACCORDANCE WITH NYS CODE RULE 56.


ANY QUESTIONABLE MATERIAL OR MATERIAL SUSPECTED TO CONTAIN ASBESTOS SHALL NOT BE DISTURBED AND SHALL BE BROUGHT TO THE ATTENTION OF THE OWNER OR THE OWNER'S REPRESENTATIVE FOR AN ACCURATE INTERPRETATION AND/OR SAMPLING AND ANALYSIS.

ELECTRICAL GENERAL NOTES LIST

- A. TAKE FIELD MEASUREMENTS AS REQUIRED AND BE RESPONSIBLE FOR FITTING NEW CONSTRUCTION TO EXISTING CONSTRUCTION. REPAIR ANY EXISTING CONDITIONS DISTURBED OR DAMAGED DURING CONSTRUCTION (TO MATCH EXISTING).
- B. PERFORM SITE INVESTIGATION PRIOR TO START OF WORK TO REVEAL EXISTING CONDITIONS.
- C. EXAMINE ALL DRAWINGS AND SPECIFICATIONS AND COORDINATE WORK WITH ALL OTHER CONTRACTORS.
- D. CONTRACTOR SHALL PROVIDE ALL CUTTING, PATCHING AND REPAIRING OF MATERIALS AND FINISHES DISTURBED BY THEIR TRADES.
- E. FIELD VERIFY ALL EXISTING CONDITIONS BEFORE STARTING DEMOLITION AND INSTALLATION.
- F. COORDINATE WITH THE MECHANICAL CONTRACTOR FOR POWER CONNECTIONS TO ALL MECHANICAL EQUIPMENT.


ELECTRICAL ABBREVIATIONS LIST

Α	AMPERAGE OR AMPS	NEMA	NATIONAL ELECTRICAL MANUFACTURERS ASSOCIATION
AFF	ABOVE FINISHED FLOOR	NIC	NOT IN CONTRACT
AFG	ABOVE FINISHED GRADE	NL	NIGHT LIGHT
ARA	AREA OF RESCUE ASSISTANCE	ос	OVER THE COUNTER
BMS	BUILDING MANAGEMENT SYSTEM	PA	PUBLIC ADDRESS
С	CONDUIT	PBB	PRIMARY BUS BAR
CCTV	CLOSED CIRCUIT TELEVISION	PDU	POWER DISTRIBUTION UNIT
cd	CANDELA	PG	POLYCARBONATE GUARD
CM	CEILING MOUNTED	PTZ	PAN, TILT, ZOOM
CKT	CIRCUIT	PVC	POLYVINYL CHLORIDE
CT	CURRENT TRANSFORMER	REC	RECESSED
DISC	DISCONNECT	SBB	SECONDARY BUS BAR
EC	ELECTRICAL CONTRACTOR	SCH	SCHEDULE
EMT	ELECTRICAL METALLIC TUBING	SM	SURFACE MOUNTED
ETR	EXISTING TO REMAIN	SPD	SURGE PROTECTIVE DEVICE
EWC	ELECTRIC WATER COOLER	SQ	SQUARE
FBO	FURNISHED BY OTHERS	SWBD	SWITCHBOARD
FMC	FLEXIBLE METAL CONDUIT	TBB	TELECOMMUNICATION BONDING BACKBONE
FT	FEET	TBC	TELECOMMUNICATION BONDING CONDUCTOR
GFCI	GROUND FAULT CIRCUIT INTERRUPTER	TSP	TWISTED SHIELDED PAIR
GND	GROUND	TVSS	TRANSIENT VOLTAGE SURGE SUPPRESSION
GRC	GALVANIZED RIGID CONDUIT	Tx/Rx	TRANSMITTER/RECEIVER
HDMI	HIGH-DEFINITION MULTIMEDIA INTERFACE	uc	UNDER COUNTER
IG	ISOLATED GROUND	UF	UNDERFLOOR
IN	INCHES	UG	UNDERGROUND
KW	KILOWATTS	UTP	UNSHIELDED TWISTED PAIR
LFMC	LIQUID TIGHT FLEXIBLE METAL CONDUIT	V	VOLTAGE OR VOLTS
MAX	MAXIMUM	VAC	VOLTAGE ALTERNATING CURRENT
MCB	MAIN CIRCUIT BREAKER	VDC	VOLTAGE DIRECT CURRENT
MDP	MAIN DISTRIBUTION PANEL	VFD	VARIABLE FREQUENCY DRIVE
MIN	MINIMUM	W	WATTAGE OR WATTS
MLO	MAIN LUG ONLY	WG	WIRE GUARD
MTD	MOUNTED	WP	WATERPROOF OR WEATHERPROOF
NEC	NATIONAL ELECTRICAL CODE	XFMR	TRANSFORMER
		ı	

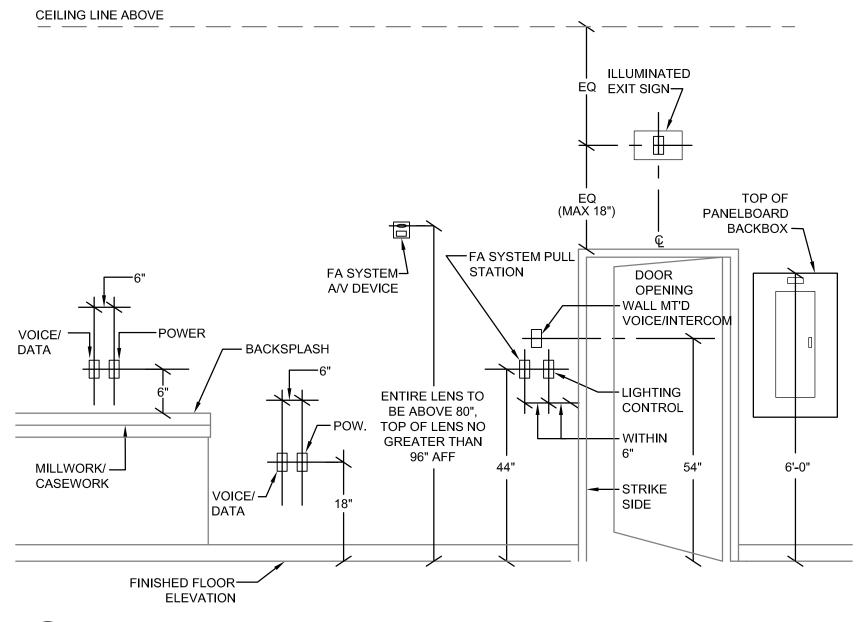

TYPICAL ROUGH-IN HEIGHTS FOR ELECTRIC WORK

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PROJECT NO. 051037 LANFORD REHAB PHASE II EXTERIOR

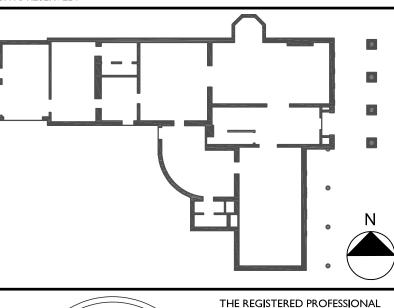194 CENTRAL AVENUE FREDONIA, NEW YORK 14063

100% CONSTRUCTION DOCUMENT SET

	Revision	Schedule
Revision Number	Date	Description

DRAWING ISSUED:	10/01/2024
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Drawing Title


ELECTRICAL SYMBOLS, NOTES AND ABBREVIATIONS

Drawing Number

E-000

GENERAL NOTES:

- A. COORDINATE ALL WORK WITH OTHER TRADES PRIOR TO INSTALLATION.
- B. USE OF ROMEX CABLE SHALL BE PERMITTED INDOORS.
- C. PREMISES CONTAINS KNOB AND TUBE WIRING. DISCONNECT AND REMOVE. REPLACE WITH SPECIFIED NM CABLE.

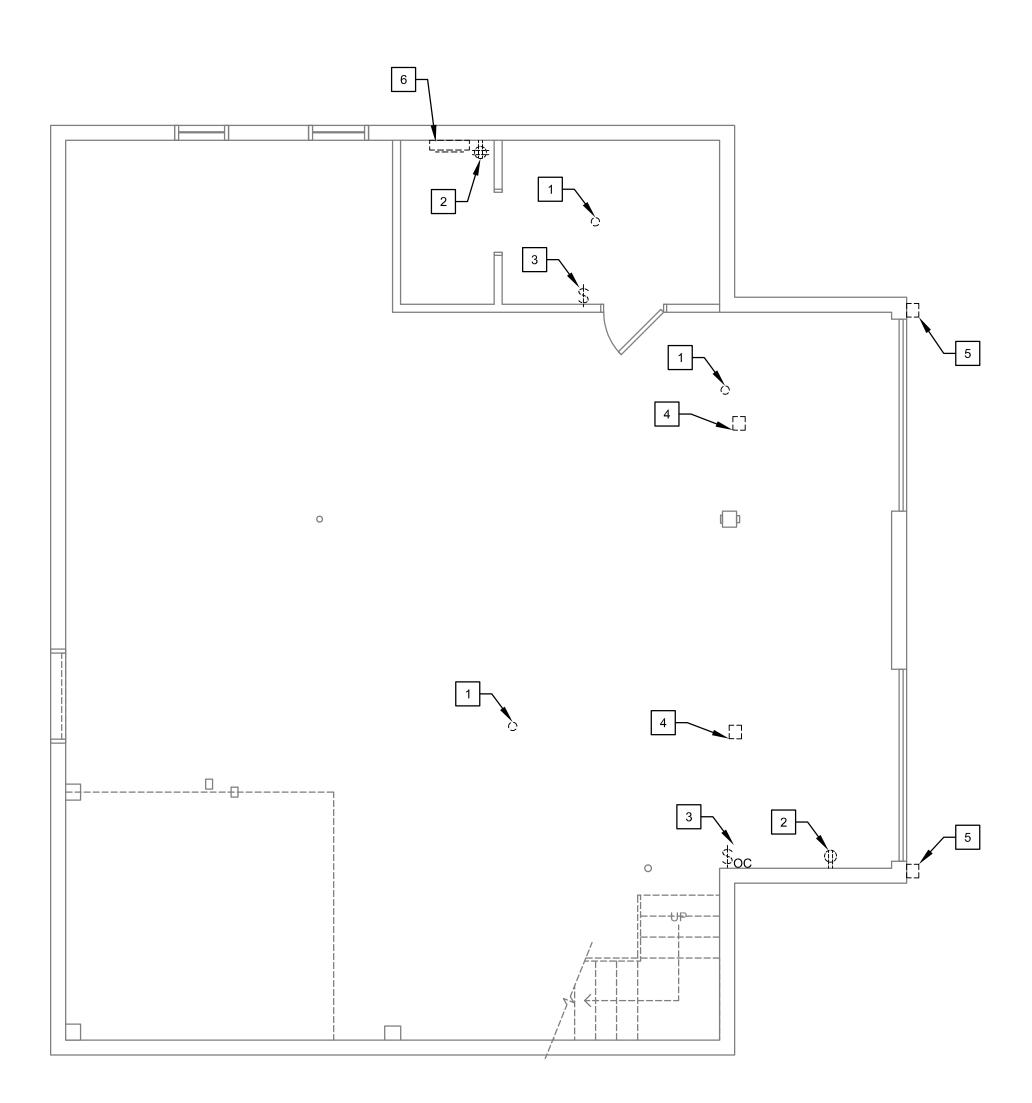




SCALE: 1/4" = 1'-0"

GENERAL DEMOLITION NOTE:

DISCONECT AND REMOVE ALL EXISTING ELECTRICAL DEVICES, LIGHT FIXTURES, WIRING ETC. IN THEIR ENTIRETY. SOME EXISTING DEVICES MAY NOT BE SHOWN.

KEYED DEMOLITION NOTES:

- 1. DISCONNECT AND REMOVE EXISTING PORCELAIN LAMPHOLDER. REMOVE ALL CONDUIT AND CABLE BACK TO SOURCE.
- 2. DISCONNECT AND REMOVE EXISTING RECEPTACLE AND WIRING. REMOVE ALL CONDUIT AND CABLE BACK TO SOURCE.
- 3. DISCONNECT AND REMOVE EXISTING LIGHT SWITCH AND WIRING. REMOVE ALL CONDUIT AND CABLE BACK TO SOURCE.
- 4. DISCONNECT AND REMOVE EXISTING GARAGE DOOR OPENER, ALL ASSOCIATED DEVICES, CONTROLS AND WIRING. REMOVE ALL CONDUIT AND CABLE BACK TO SOURCE.
- 5. DISCONNECT AND REMOVE EXISTING LIGHT FIXTURE AND WIRING. REMOVE ALL CONDUIT AND CABLE BACK TO SOURCE.
- 6. DISCONNECT AND REMOVE EXISTING LOAD CENTER. REMOVE ALL WIRING BACK TO SOURCE. EXISTING CONDUIT FROM BASEMENT MAY BE REUSED.

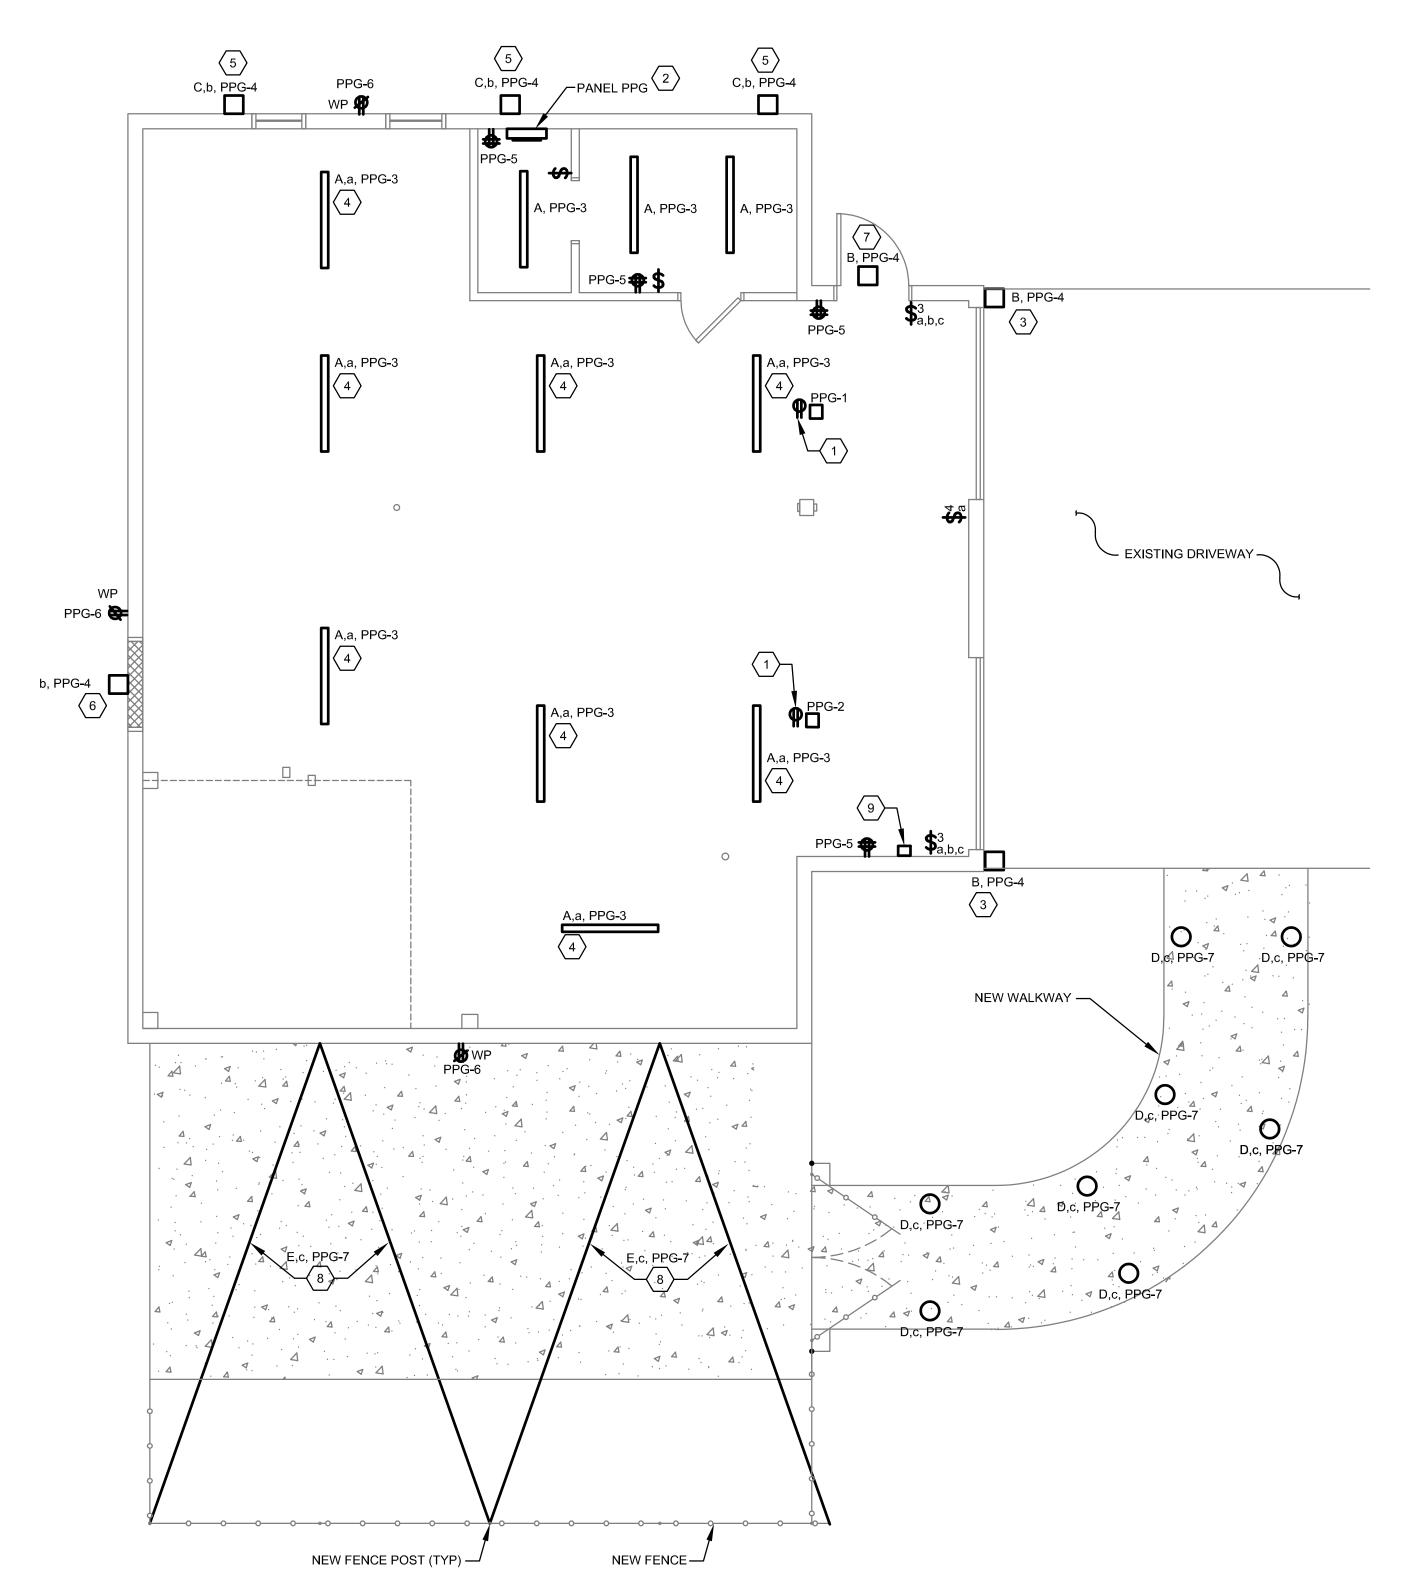




KEYED INSTALLATION NOTES: (#)

- PROVIDE RECEPTACLE FOR GARAGE DOOR OPENER. COORDINATE FINAL LOCATION WITH GARAGE DOOR SUPPLIER PRIOR TO INSTALLATION. PROVIDE INDIVIDUAL DOOR CONTROLLERS FOR EACH DOOR AT GARAGE, HOUSE AND 2 OWNER CARS.
- 2. PROVIDE 40A, 2-POLE CIRCUIT BREAKER IN EXISTING PANEL "SUB A" IN BASEMENT OF HOUSE. PROVIDE (3) #6 AWG AND (1) #10 GND IN 3/4" C FROM PANEL "SUB-A" TO NEW PANEL "PPG". EXISTING UNDERGROUND CONDUIT MAY BE RE-USED IF SUITABLE FOR USE.
- 3. MOUNT FIXTURE IN PLACE OF EXISTING LIGHT FIXTURE.
- 4. MOUNT FIXTURE TO UNDERSIDE OF JOIST.
- 5. MOUNT FIXTURE AT 14'-0" AFG.
- 6. PROVIDE POWER TO EXISTING LIGHT FIXTURE.
- 7. MOUNT FIXTURE 12" ABOVE DOOR.
- 8. TYPE "E" STRING LIGHT. HANG LIGHTS BETWEEN GARAGE AND FENCE POSTS. SEE LIGHT FIXTURE SCHEDULE AND DETAILS 3 AND 4, DRAWING E-700, FOR ADDITIONAL INFORMATION.
- 9. PROVIDE 12 VDC POWER TRANSFORMER FOR TYPE "D" LIGHT FIXTURES. MOUNT TRANSFORMER APPROX. 42" A.F.F.

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PROJECT NO. 051037 LANFORD REHAB PHASE II EXTERIOR

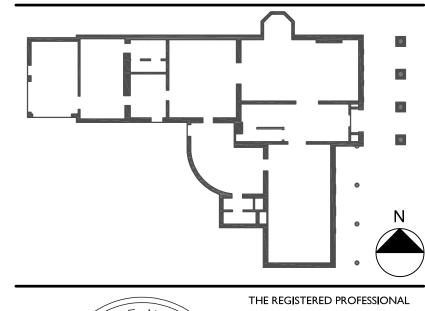194 CENTRAL AVENUE FREDONIA, NEW YORK 14063

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Drawing Title

ELECTRICAL GARAGE PLAN

Drawing Number

E-100

					F	PANE	L PPC	}				
VOLTA	GE: 120/	240	MAINS RATING: 6	60			A.I.C.RA	TING: 10	,000		LOCATION: GARAGE	
PHASE	: 1		M.C.B.: X				BKR SPA	ACE: 20			POWER SOURCE: PANEL "SUB-A	A"
WIRE:	3		M.L.O.:				MOUNTI	NG: SURI	FACE		FEEDER CIRCUIT: 3#6 AND #10 G	3ND
				A۱	1PS			AN	/IPS			
NO.	USE, LOC	ATION		Α	В	BKR	BKR	Α	В	USE, LOCATION		NO.
1	GARA	GE DOOR #1		0.0		20/1	20/1	0.0		GARAGE DOOR #	2	2
3	GARA	GE INTERIOR LIGHTING			0.0	20/1	20/1		0.0	GARAGE EXTERIO	OR LIGHTING	4
5	GARA	GE INTERIOR RECEPTA	CLES	0.0		20/1	20/1	0.0		GARAGE EXTERIO	OR RECEPTACLES	6
7	GARA	GE SOUTH EXTERIOR L	GHTING		0.0	20/1	20/1		0.0	SPARE		8
9	SPAR			0.0		20/1	20/1	0		SPARE		10
11	SPAR				0.0	20/1	20/1		0	SPARE		12
13	SPACE			0				0.0		SPACE		14
15	SPACE				0				0.0	SPACE		16
17	SPACE			0.0				0.0		SPACE		18
19	SPACE	<u> </u>			0.0				0.0	SPACE		20

PANEL PPG SCHEDULE


	LIGHTING FIXTURE SCHEDULE								
TYPE	DESCRIPTION	LENS	VOLTAGE	DRIVER	LAMPS	FIXTURE WATTAGE	BASIS OF DESIGN	EQUIVALENT MANUFACTURERS	COMMENTS
Α	4'-0" WHITE LED SHOP LIGHT STEEL FRAME AND JUNCTION BOX. ENERGY STAR QUALIFIED.	LED	120V	LED	LED 4000K 3200 LUMENS	36	COMMERCIAL ELECTRIC, CATALOG NUMBER 54103161	OR APPROVED EQUIVALENT PER ENGINEER AND ARCHITECT	
В	GARAGE WALL SCONCE - TEXTURED BLACK FINISH - DUSK TO DAWN OPERATION	GLASS	120V	INCANDESCENT	E26 3000K 1000 LUMENS	60	WESTINGHOUSE LIGHTING, CATALOG NUMBER 62045	OR APPROVED EQUIVALENT PER ENGINEER AND ARCHITECT	PROVIDE LED LAMP
С	GARAGE BARN LIGHT - MATTE BLACK FINISH	METALLIC	120V	INCANDESCENT	A19 3000K 1200 LUMENS	75	GENERATION LIGHTING, CATALOG NUMBER 8737401-12	OR APPROVED EQUIVALENT PER ENGINEER AND ARCHITECT	PROVIDE LED LAMP
D	RECESSED GROUND MOUNT LED FIXTURE - THERMOPLASTIC HOUSING, ALUMINUM TRIM - BRONZE COLOR - IP65 RATED	ACRYLIC	12 VDC	LED	LED 3000K	8	COOPER LUMIERE BOCA 650 SERIES, CATALOG NUMBER 650-1-8LED3010-12-BZ	OR APPROVED EQUIVALENT PER ENGINEER AND ARCHITECT	PROVIDE MANUFACTURER APPROVED 1 VDC POWER SUPPLY TRANSFORMER
E	120V EXTERIOR LED LIGHT STRING, MOUNTED LAMP-DOWN, NO-DROP TO 0.0625" DIA. GAL. STL. AIR CRAFT CABLE, WARM WHITE G45 FILAMENT LED LAMP, BLACK MEDIUM BASE SOCKET, ATTACH WITH CABLE TIES. DECORATIVE STRING LIGHTING LED LAMPS INCLUDED. WET LOCATION LISTED.	POLYCARBONATE LED LAMP	120V	INCANDESCENT	LED WARM WHITE, 39.8 LUMENS	1W PER LAMP	TMB ARCHITECTURAL MODEL FIREFESV1224VE2 - 12" SPACING	OR APPROVED EQUIVALENT PER ENGINEER AND ARCHITECT	PROVIDE LED LAMP

LIGHT FIXTURE SCHEDULE



<u>DETAIL NOTES:</u>
1. LAMP-DOWN APPLICATION ONLY.
2. MUST BE INSTALLED W/ AIRCRAFT CABLE AND REPLACEABLE
120V MEDIUM BASE LED LAMPS, ALSO, INCLUDED W/ STRING.

TYPICAL TYPE "E" LIGHT STRING ASSEMBLY DETAIL

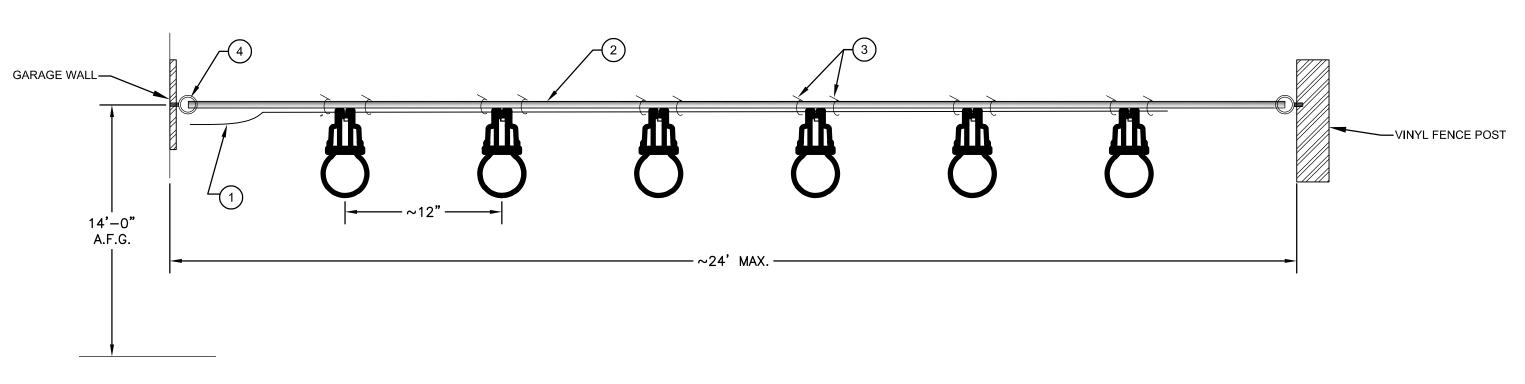


<u>DETAIL NOTES:</u>


1. HARD-WIRE INSIDE ELECTRICAL BOX USING OUTDOOR-RATED CONNECTORS. 2. ENSURE AIRCRAFT CABLE IS TAUT AND SECURED. 3. USE (2) CABLE TIES PER SOCKET, ONE ON EACH SIDE. 4. USE SURFACE MOUNTING PLATE AND EYEHOOK FOR ATTACHMENT TO EXTERIOR BUILDING SURFACES AND WOOD FENCE POSTS.

5. CONTRACTOR TO VERIFY SPAN DISTANCE AND STRING QUANTITIES IN FIELD.

LAMP DOWN APPLICATION DETAIL

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ELECTRICAL SCHEDULES AND DETAILS

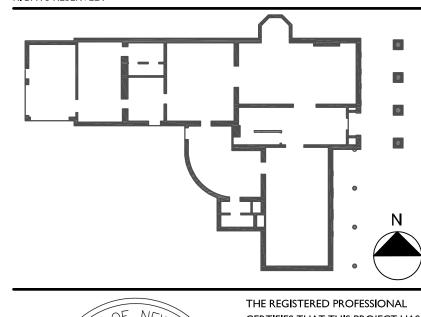Drawing Number

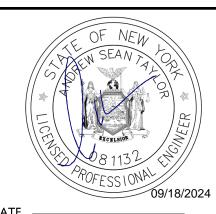E-700