

SHEET SEQUENCE NO.

GREGORY HALL PROJECT SITE-

CONTRACTOR PARKING

AVAILABLE-

DRAWING INDEX NO. SHEET TITLE COVER SHEET CODE DATA, WIND UPLIFT DESIGN CRITERIA, AND GENERAL NOTES KEY PLAN, CONSTRUCTION NOTES, AND REFERENCE PHOTOS BUILDING ELEVATIONS BUILDING ELEVATIONS BUILDING ELEVATIONS BUILDING ELEVATIONS TYPICAL MASONRY DETAILS RAMP - ENLARGED PLAN, ELEVATIONS, SECTION, REFERENCE PHOTOS

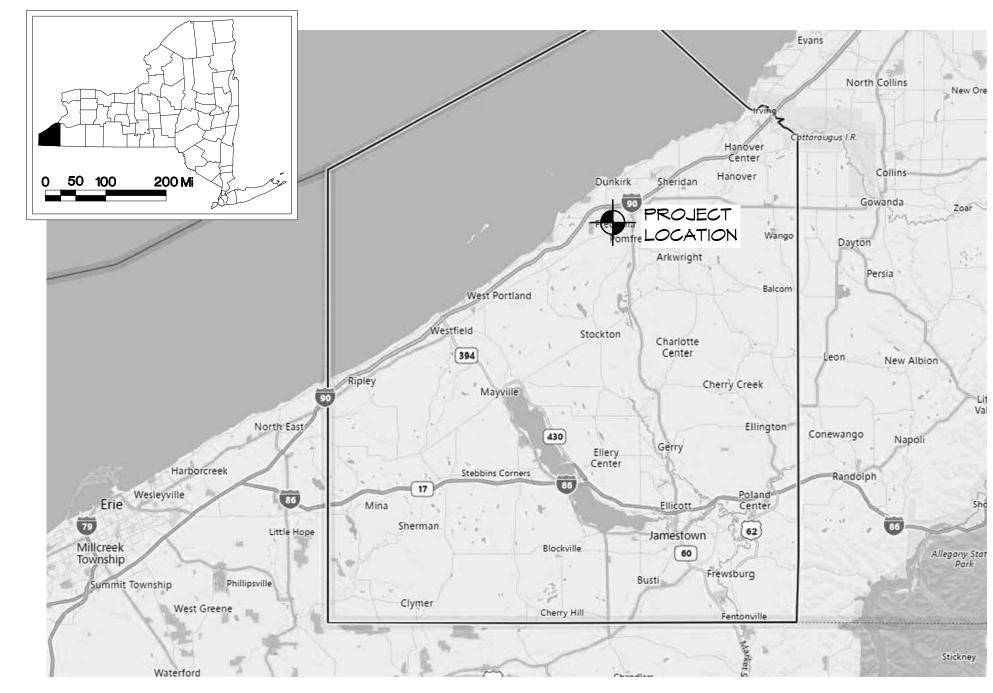
ENLARGED ENTRANCE ELEVATION, DETAILS AND REFERENCE PHOTOS

RAMP - SECTIONS AND DETAILS

SITE GENERAL NOTES:

1. CONTRACTOR PARKING:

- 1.1. CONTRACTOR PARKING IS AVAILABLE AS INDICATED ON SITE PLAN BELOW.
- 2. MATERIAL STAGING & LAYDOWN AREAS ARE INDICATED ON THE DRAWINGS. THE CONTRACTOR SHALL COORDINATE FINAL STAGING AREA, ACCESS, PARKING, DELIVERY & STORAGE WITH OWNER'S REPRESENTATIVE PRIOR TO MOBILIZATION.
- 2.1. CONTRACTOR TO PROVIDE A FLAGPERSON TO DIRECT TRAFFIC WHEN ACCEPTING MATERIAL DELIVERIES OR EQUIPMENT MOVEMENT TO PROVIDE SAFE PASSAGE TO CONSTRUCTION AREAS. TEMPORARY ROAD CLOSURES MUST BE COORDINATED IN ADVANCE. MAINTAIN ROAD ACCESS WIDTH IN ACCORDANCE WITH LOCAL AND STATE REGULATIONS BUT NOT LESS THAN
- 3. CONTRACTOR SHALL BARRICADE, IN THE FORM OF A 6'-O" HIGH CHAIN LINK FENCE, THE PERIMETER OF ALL STAGING AREAS TO PREVENT PUBLIC ACCESS. THE BARRICADE SHALL HAVE A LOCKABLE 12'-O" WIDE DOUBLE GATE.
- 3.1. PROVIDE TEMPORARY WAYFINDING AND CONSTRUCTION CAUTION SIGNAGE TO DIRECT PEDESTRIAN TRAFFIC AROUND BUILDING TO AVAILABLE ENTRANCES; SIGNAGE SIZE: 12"X 24", COROPLAST BOARD OR OTHER APPROVED MATERIAL, MOUNTED TO TEMPORARY CONSTRUCTION FENCE WITH HEAVY DUTY NYLON CABLE TIES THROUGH (4) EYELETS AT CORNERS. PROVIDE INTERIOR SIGNAGE AND THROUGHOUT THE BUILDING DIRECTING PEDESTRIAN TRAFFIC AS NEEDED BASED ON TEMPORARY STAGING TO ALTERNATE EXIT LOCATIONS.
- PROVIDE RUBBER PARKING WHEEL BLOCKS AT ALL ADJACENT PARKING SPACES ABUTTING THE FENCING TO PROTECT FROM IMPACT.
- 3.4. FENCE POSTS LOCATED IN GRASS AREAS MAY BE DRILLED. POSTS AND BASE OF FENCE ON IMPERVIOUS SURFACES TO BE BALLASTED WITH OUTRIGGERS ADEQUATELY DESIGNED TO WITHSTAND WIND LOADS FROM OVERTURNING THE FENCE. CALL UFPO DIG SAFELY TO SURVEY AND MARK AREA FOR UTILITIES.
- 4. SITE PLAN INFORMATION IS BASED ON RECORD INFORMATION PROVIDED. NOT ALL EXISTING UTILITIES, TREES, LANDSCAPING, SIDEMALKS, PAVEMENTS, EQUIPMENT, FIXTURES AND TOPOGRAPHIC INFORMATION MAY BE SHOWN. CONTRACTOR SHALL FIELD VERIFY AND FAMILIARIZE THEMSELVES WITH EXISTING CONDITIONS. REPAIR AND RESTORE ANY DAMAGE TO EXISTING CONSTRUCTION AND SITE WORK RESULTING FROM THE WORK OF THIS PROJECT INCLUDING BUT NOT LIMITED TO: GRASSED OR LANDSCAPED AREAS, CURBS, WALKWAYS, CATCH BASINS, PAVEMENT, ETC. CAUSED BY THE WORK OF THIS PROJECT. REPAIRS ARE TO MATCH ORIGINAL/ADJACENT SURFACES UNLESS NOTED OTHERWISE. CONTRACTOR TO TAKE PHOTOGRAPHS OF SITE PRIOR TO START OF WORK AND SUBMIT TO OWNER'S REPRESENTATIVE.
- 5. EXTERIOR EGRESS PATHS, WALKWAYS AND ENTRANCES SHALL REMAIN UNOBSTRUCTED AND PROTECTED. REFER TO CONSTRUCTION SAFEGUARD NOTES ON A-1. PROVIDE ALTERNATE CIRCULATION AS NEEDED TO ACCESS THE WORK.





215 Wyoming Street 1160-C Pittsford-Victor Rd

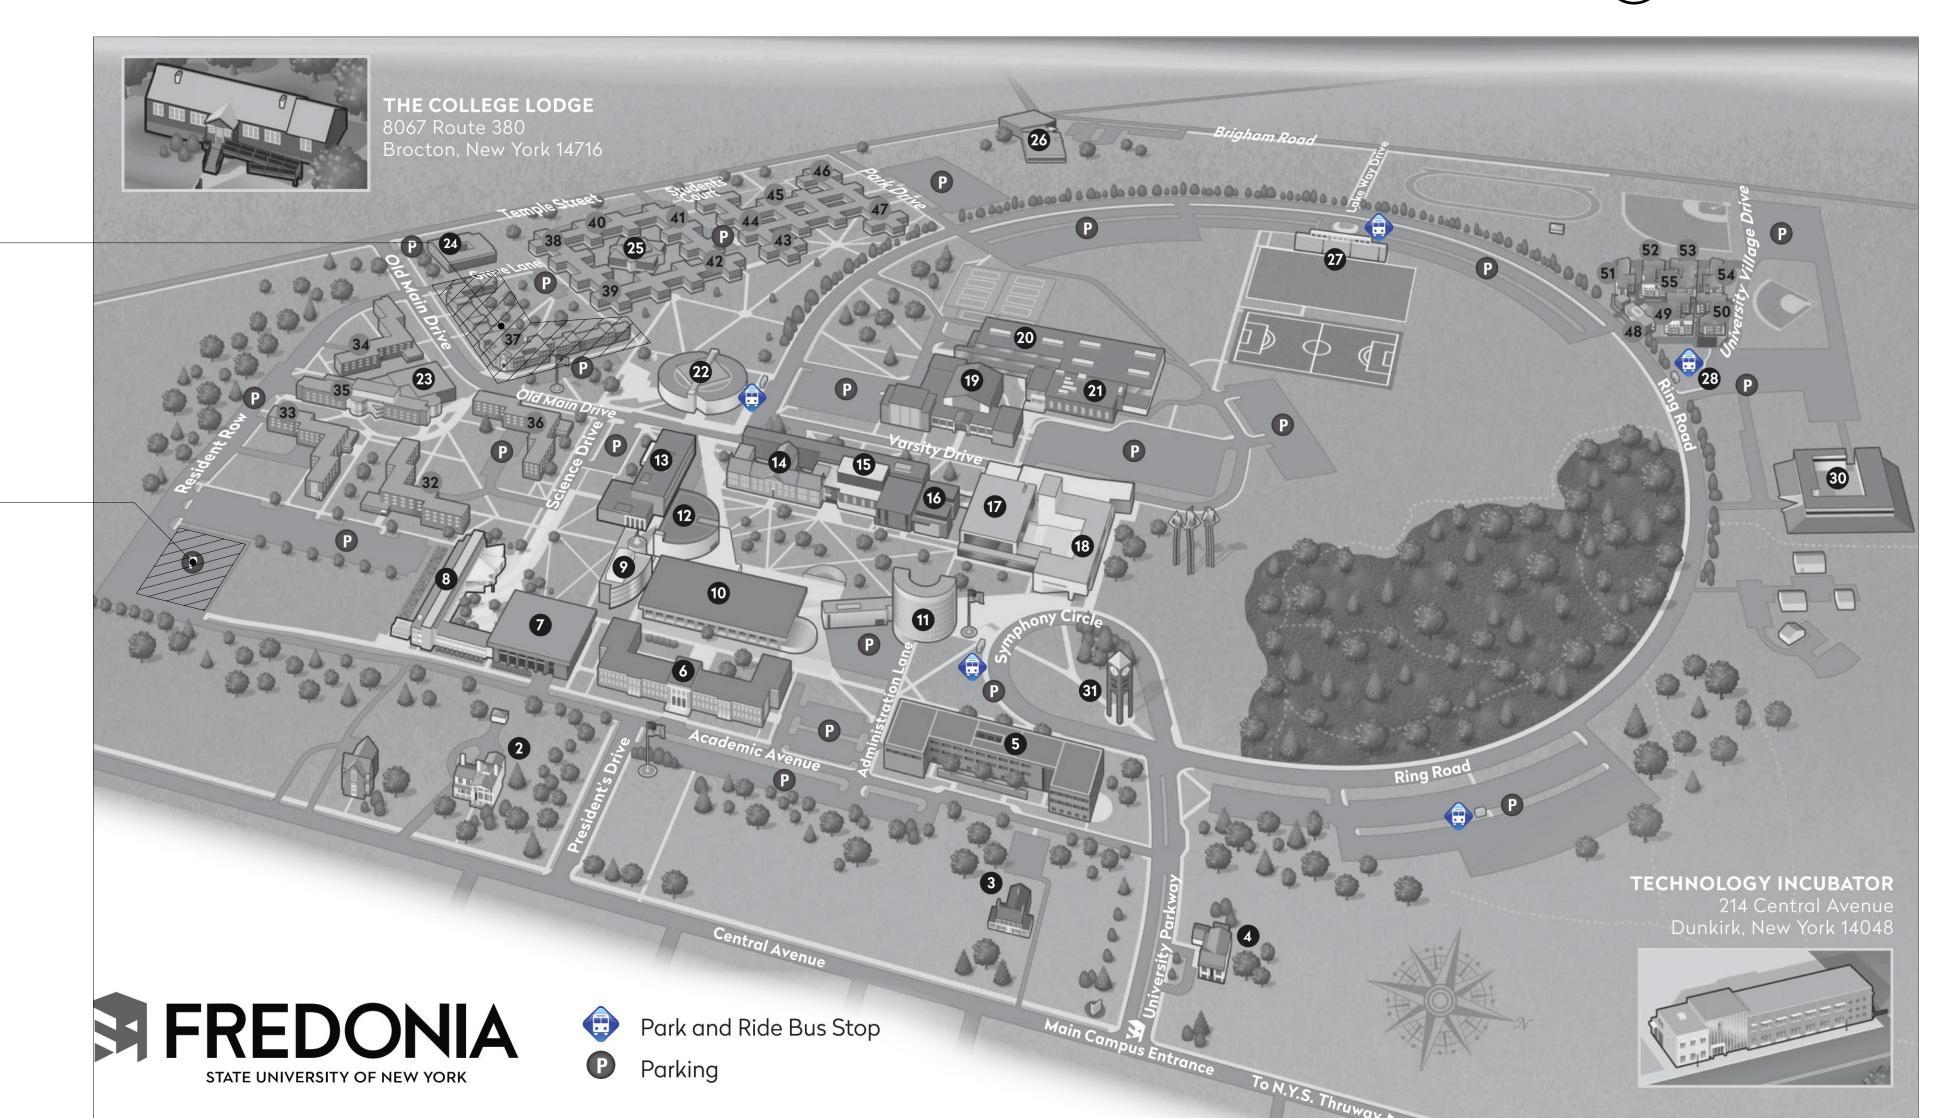
Syracuse, NY 13204 Pittsford, NY 14534

Tel (315) 488 - 0377 Tel (585) 200 - 5038 Fax (315) 487 - 5947 Fax (585) 487 - 9532 info@bellandspina.com www.bellandspina.com

PROJECT#: 378-21-002 BID DOCUMENTS SUBMISSION

08/15/2022


LOCATION MAP



SITE PLAN

These plans and specifications were prepared by Bell & Spina P.C. Architects / Planners, Syracuse, New York 13204, and to the best of this Office's knowledge, information and belief, said plans and specifications meet the requirements of the 2020 International Fire Code, Building Code, and Energy Conservation Construction Code of New York State. After visiting the site of the work and fully informing themselves as to all existing conditions and limitations, each bidder is required to notify the office of the Architect, in writing, prior to the bidding, of any existing conditions shown on the drawings that have been changed and would prevent the intended installation of new work.

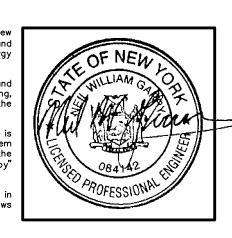It is a violation of the New York State Education Law, Article 145 Sec. 7209, for any person unless he is acting under the direction of a licensed professional Architect, Engineer or Land Surveyor to alter an item in any way. If an item bearing the seal of an Architect, Engineer or Land Surveyor is altered, the altering Architect, Engineer and/or Surveyor shall affix to the item his seal and the notation "altered by followed by his signature and the date of such alteration, and a specific description of the alteration. To the best of my knowledge, information, and belief, the construction documents for this project are in conformance with the Building Code of New York State and all other applicable Federal and State laws and regulations, all as currently amended.



SET NUMBER:

	280 CENTRAL AVENUE FREDONIA, NEW YORK 14063 CHAUTAUQUA COUNTY			
CODE REFERENCE	2020 NYS UNIFORM FIRE PREVENTION AND BUILDING CODE (INCORPORATING THE 2018 INTERNATIONAL CODES)			
ITEM (SECTION)	<u>EXISTING</u>	REQ.	PROPOSED	<u>REMARKS</u>
CLASSIFICATION OF WORK (EBCNYS CHAPTER 6)			ALTERATION LEVEL 1	
OCCUPANCY CLASSIFICATION & USE (BCNYS CHAPTER 3)	R-2		N/C	
TYPE OF CONSTRUCTION (BCNYS CHAPTER 6)	IIВ	N/C	N/C	
BUILDING HEIGHT (BCNYS 504.3)	N/C	N/C	N/C	
BUILDING AREA (BCNYS 506)	N/C	N/C	N/C	
NUMBER OF STORIES (BCNYS 504.4)	N/C	N/C	N/C	
MIXED USE AND OCCUPANCIES				
SEPARATED OCCUPANCIES (BCNYS 508.4)	N/C	N/C	N/C	
INCIDENTAL USES (BCNYS 509)	N/C	N/C	N/C	
ACCESSORY OCCUPANCIES (BCNYS 508.2)	N/C	N/C	N/C	
SPECIAL DETAILED REQUIRMENTS BASED ON OCCUPANCY & USE (BCNYS CHAPTER 4)	N/C	N/C	N/C	
MEANS OF EGRESS (BCNYS CHAPTER 10)	N/C	N/C	N/C	
ACCESSIBILITY (BCNYS CHAPTER 11)	N/C	N/C	N/C	
N/A - NOT APPLICABLE N/C	- NO CHANGE	N/R - N	NOT REQUIRED	N/P - NOT PROVIDED

BUILDING CODE SUMMARY DATA

BUILDING NAME AND LOCATION GREGORY HALL

JUDGEMENT, THESE PLANS AND/OR SPECIFICATIONS ARE IN COMPLIANCE WITH THE 2020 UNIFORM CO

BUILDING CODE SUMMARY DATA				
ITEM (SECTION)	EXISTING	REQ.	PROPOSED	REMARKS
TOTAL OCCUPANT LOAD (BCNYS 1004)	N/C	N/C	N/C	
STAIRMAY CAPACITY (BCNYS 1005)	N/C	N/C	N/C	
OTHER EGRESS COMPONENT CAPACITY (BCNYS 1005)	N/C	N/C	N/C	
EXIT ACCESS TRAVEL DISTANCE (BCNYS 1017)	N/C	N/C	N/C	
CORRIDOR WIDTH AND CAPACITY (BCNYS 1020.2)	N/C	N/C	N/C	
CORRIDOR FIRE RATING (BCNYS TBL 1020.1)	N/C	N/C	N/C	
NUMBER OF EXITS & EXIT ACCESS DOORWAYS (BCNYS 1006)	N/C	N/C	N/C	
ACCESSIBILITY (CHAPTER 11)	N/C	N/C	N/C	
N/A - NOT APPLICABLE N/O	C - NO CHANGE	N/R -	NOT REQUIRED	N/P - NOT PROVIDED

ECCNYS COMPLIANCE DATA					
COUNTY CLIMATE ZONE COMMERCIAL / RESIDENTIAL	CHAUTAUQUA 5A COMMERCIA				
COMPLIANCE METHOD (ECCNYS SECTION C401.2)	(ECCNYS CHAPTER 4)				
ENVELOPE SCOPE OF WORK	MASONRY REPAIR, SEALANT REPLACEMENT AND PARTIAL ROOF REPLACEMENT				
ITEM (SECTION)	<u>EXISTING</u>	REQ.	PROPOSED	<u>REMARKS</u>	
ROOF INSULATION					
INSULATION ABOVE ROOF DECK	N/C	N/C	N/C		
ATTIC INSULATION	N/C	N/C	N/C		

	REPLACEMENT			
ITEM (SECTION)	<u>EXISTING</u>	REQ.	PROPOSED	<u>REMARKS</u>
ROOF INSULATION				
INSULATION ABOVE ROOF DECK	N/C	N/C	N/C	
ATTIC INSULATION	N/C	N/C	N/C	
MALLS ABOVE GRADE	N/C	N/C	N/C	
MALLS BELOW GRADE	N/C	N/C	N/C	
SLAB ON GRADE				
FENESTRATION				
VERTICAL FENESTRATION (MAX30%)	N/C	N/C	N/C	
U-FACTOR (FIXED)	N/C	N/C	N/C	
U-FACTOR (OPERABLE)	N/C	N/C	N/C	
SHGC	N/C	N/C	N/C	
U-VALUE (SKYLIGHTS)	N/C	N/C	N/C	
AIR LEAKAGE	N/C	N/C	N/C	
VAPOR RETARDER	N/C	N/C	N/C	
AIR BARRIER	N/C	N/C	N/C	
N/A - NOT APPLICABLE N/C	- NO CHANGE	N/R -	NOT REQUIRED	N/P - NOT PROVIDED

STRUCTURAL DESIGN DATA:

- 1. RISK CATEGORY:
- 2. ROOF LIVE LOAD: 20 PSF
- 3. ROOF SNOW LOAD:
 A. GROUND SNOW LOAD PG 40 PSF
 B. FLAT-ROOF SNOW LOAD PF 31 PSF
 C. SNOW EXPOSURE FACTOR Ce 1.0
- D. SNOW LOAD IMPORTANCE FACTOR IS 1.1

 E. THERMAL FACTOR Ct 1.0

 F. SNOW DRIFT LOADING, SLIDING SNOW,

 AND UNBALANCED SNOW LOAD PER ASCE -7 --
- 4. MAXIMUM ROOF RAIN LOAD: R DOES NOT GOVERN
- 5. WIND LOAD:
 A. ULTIMATE DESIGN WIND SPEED VULT 120 MPH
- B. ALLOMABLE DESIGN SPEED VALL 93 MPH
 C. WIND EXPOSURE CATEGORY B
 D. INTERNAL PRESSURE COEFFICIENT 0.18 (±)
 E. COMPONENTS AND CLADDING SEE PLAN
- 6. EARTHQUAKE DESIGN DATA (EXISTING BUILDINGS):
 - A. SEISMIC IMPORTANCE FACTOR IE 1.25
 B. SITE CLASS (DEFAULT) D
 C. SPECTRAL RESPONSE COEFFICIENT Sds 0.162
 - D. SPECTRAL RESPONSE COEFFICIENT 5d1 0.084

 E. SEISMIC DESIGN CATEGORY 5DC B

 F. SEISMIC -FORCE-RESISTING SYSTEM EXISTING BUILDING

 G. BASE DESIGN SHEAR NOT APPLICABLE

CONSTRUCTION SAFEGUARDS NOTES:

H. ANALYSIS PROCEDURE

1. PEDESTRIANS AND EGRESS PATHWAYS SHALL REMAIN UNOBSTRUCTED AND PROTECTED DURING THE WORK. COMPLY WITH THE FOLLOWING MINIMUM REQUIREMENTS:

NOT APPLICABLE

- 1.1. OSHA OCCUPATIONAL SAFETY AND HEALTH ADMINISTRATION.
- 1.2. 2020 BUILDING CODE OF NYS, CHAPTER 33 SAFEGUARDS DURING CONSTRUCTION
- 1.3. 2020 EXISTING BUILDING CODE OF NYS, CHAPTER 15 CONSTRUCTION SAFEGUARDS.
 1.4. 2020 FIRE CODE OF NYS, CHAPTER 33 FIRE SAFETY DURING CONSTRUCTION AND DEMOLITION.
- 2. THE BUILDING WILL BE OCCUPIED DURING THE CONSTRUCTION PERIOD. PROVIDE OVERHEAD PROTECTION AT ALL INGRESS/ EGRESS DOORS (ENTRANCES, OVERHEAD DOORS AND EXIT DOORS) IN THE VICINITY OF THE WORK AREA AND MAINTAIN FOR THE DURATION OF THE WORK AS FOLLOWS:
- 2.1 PROVIDE APPROPRIATE OVERHEAD SCAFFOLDING/BRIDGING FOR OCCUPANTS ENTERING AND EXITING THE BUILDING TO PROTECT FROM FALLING DEBRIS DURING THE WORK. SUCH SCAFFOLDING MAY ALSO DOUBLE FOR CONTRACTOR ACCESS TO THE WORK. STORAGE OF MATERIALS ON SCAFFOLDING SHALL ONLY BE PERMITTED IF THE SYSTEM IS DESIGNED AND
- ENGINEERED FOR MATERIAL STORAGE.

 2.2 CONSTRUCT SYSTEM IN ACCORDANCE WITH NYS UNIFORM FIRE PREVENTION AND BUILDING CODE AND OSHA REGULATIONS.
- 2.3 WHERE SUBJECT TO IMPACT FROM VEHICLES OR EQUIPMENT, PROVIDE BARRIERS TO PROTECT
- THE SYSTEMS FROM IMPACT.

 2.4 POST TEMPORARY SIGNAGE ON THE PROTECTION COMPONENTS INDICATING OVERHEAD
- MASONRY RESTORATION WORK.
- 2.5 PROVIDE A MINIMUM 1 FOOTCANDLE (FC) TEMPORARY CONSTRUCTION LIGHTING AT DOOR LOCATIONS BELOW OVERHEAD PROTECTION SCAFFOLDING.
- 2.6 SUCH SYSTEMS SHALL BE PREPARED, DESIGNED AND STAMPED BY A NYS LICENSED PROFESSIONAL ENGINEER AND SUBMITTED FOR REVIEW AND APPROVAL. COORDINATE ALL WORK WITH THE OWNER. INCLUDE THE OVERHEAD PROTECTION SYSTEM AS PART OF THE SUBMITTED SAFETY PLAN.
- 2.7 REPAIR/ RESTORE SYSTEM ANCHORAGE OR ATTACHMENT POINTS ON THE BUILDING.
- 3. PROVIDE TEMPORARY CONSTRUCTION BARRIERS AT OTHER AREAS AROUND THE WORK AREA TO PROTECT PEDESTRIANS IN ACCORDANCE WITH THE FOLLOWING:

PROTECTION OF PEDESTRIANS				
HEIGHT OF CONSTRUCTION	DISTANCE OF CONSTRUCTION TO LOT LINE OR WALKWAY	TYPE OF PROTECTION REQUIRED		
	LESS THAN 5 FEET	BARRIER AND OVERHEAD PROTECTION		
MORE THAN 8 FEET	5 FEET OR MORE, BUT NOT MORE THAN ONE-FOURTH THE HEIGHT OF CONSTRUCTION	BARRIER AND OVERHEAD PROTECTION		
	5 FEET OR MORE, BUT BETWEEN ONE-FOURTH AND ONE-HALF THE HEIGHT OF CONSTRUCTION	BARRIER		
	5 FEET OR MORE, BUT EXCEEDING ONE-HALF THE HEIGHT OF CONSTRUCTION	NONE (FENCE)		

PROVIDE OVERHEAD PROTECTION AT ENTRANCE/ EXIT COMPLYING WITH BCNYS CHAPTER 33 SAFEGUARDS DURING CONSTRUCTION AND EBCNYS CHAPTER 15 CONSTRUCTION SAFEGUARDS.




215 Wyoming Street 1160-C Pittsford-Victor Rd Syracuse, NY 13204 Pittsford, NY 14534

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PROJECT NORTH



STERIOR MASONRY REPAIR

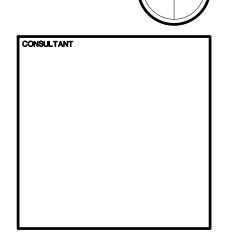SREGORY HALL

SO CENTRAL AVENUE

SEDONIA, NEW YORK 14063

378-21-002

The Contractor shall verify all dimensions and notify the Architect in writing of any discrepancies.

All drawings and specifications are the property of the Architect and shall be

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MARK DATE DESCRIPTION

PROJECT NUMBER

DRAWN CHECKED NWG

DATE SCALE

08/15/2022 AS NOTED

CODE DATA, STRUCTURAL DESIGN DATA, AND GENERAL NOTES







PHOTO - TYPICAL REENTRANT CORNER SCALE: N/A



3 PHOTO - TYPICAL BRICK DAMAGE @ CORNER SCALE: N/A

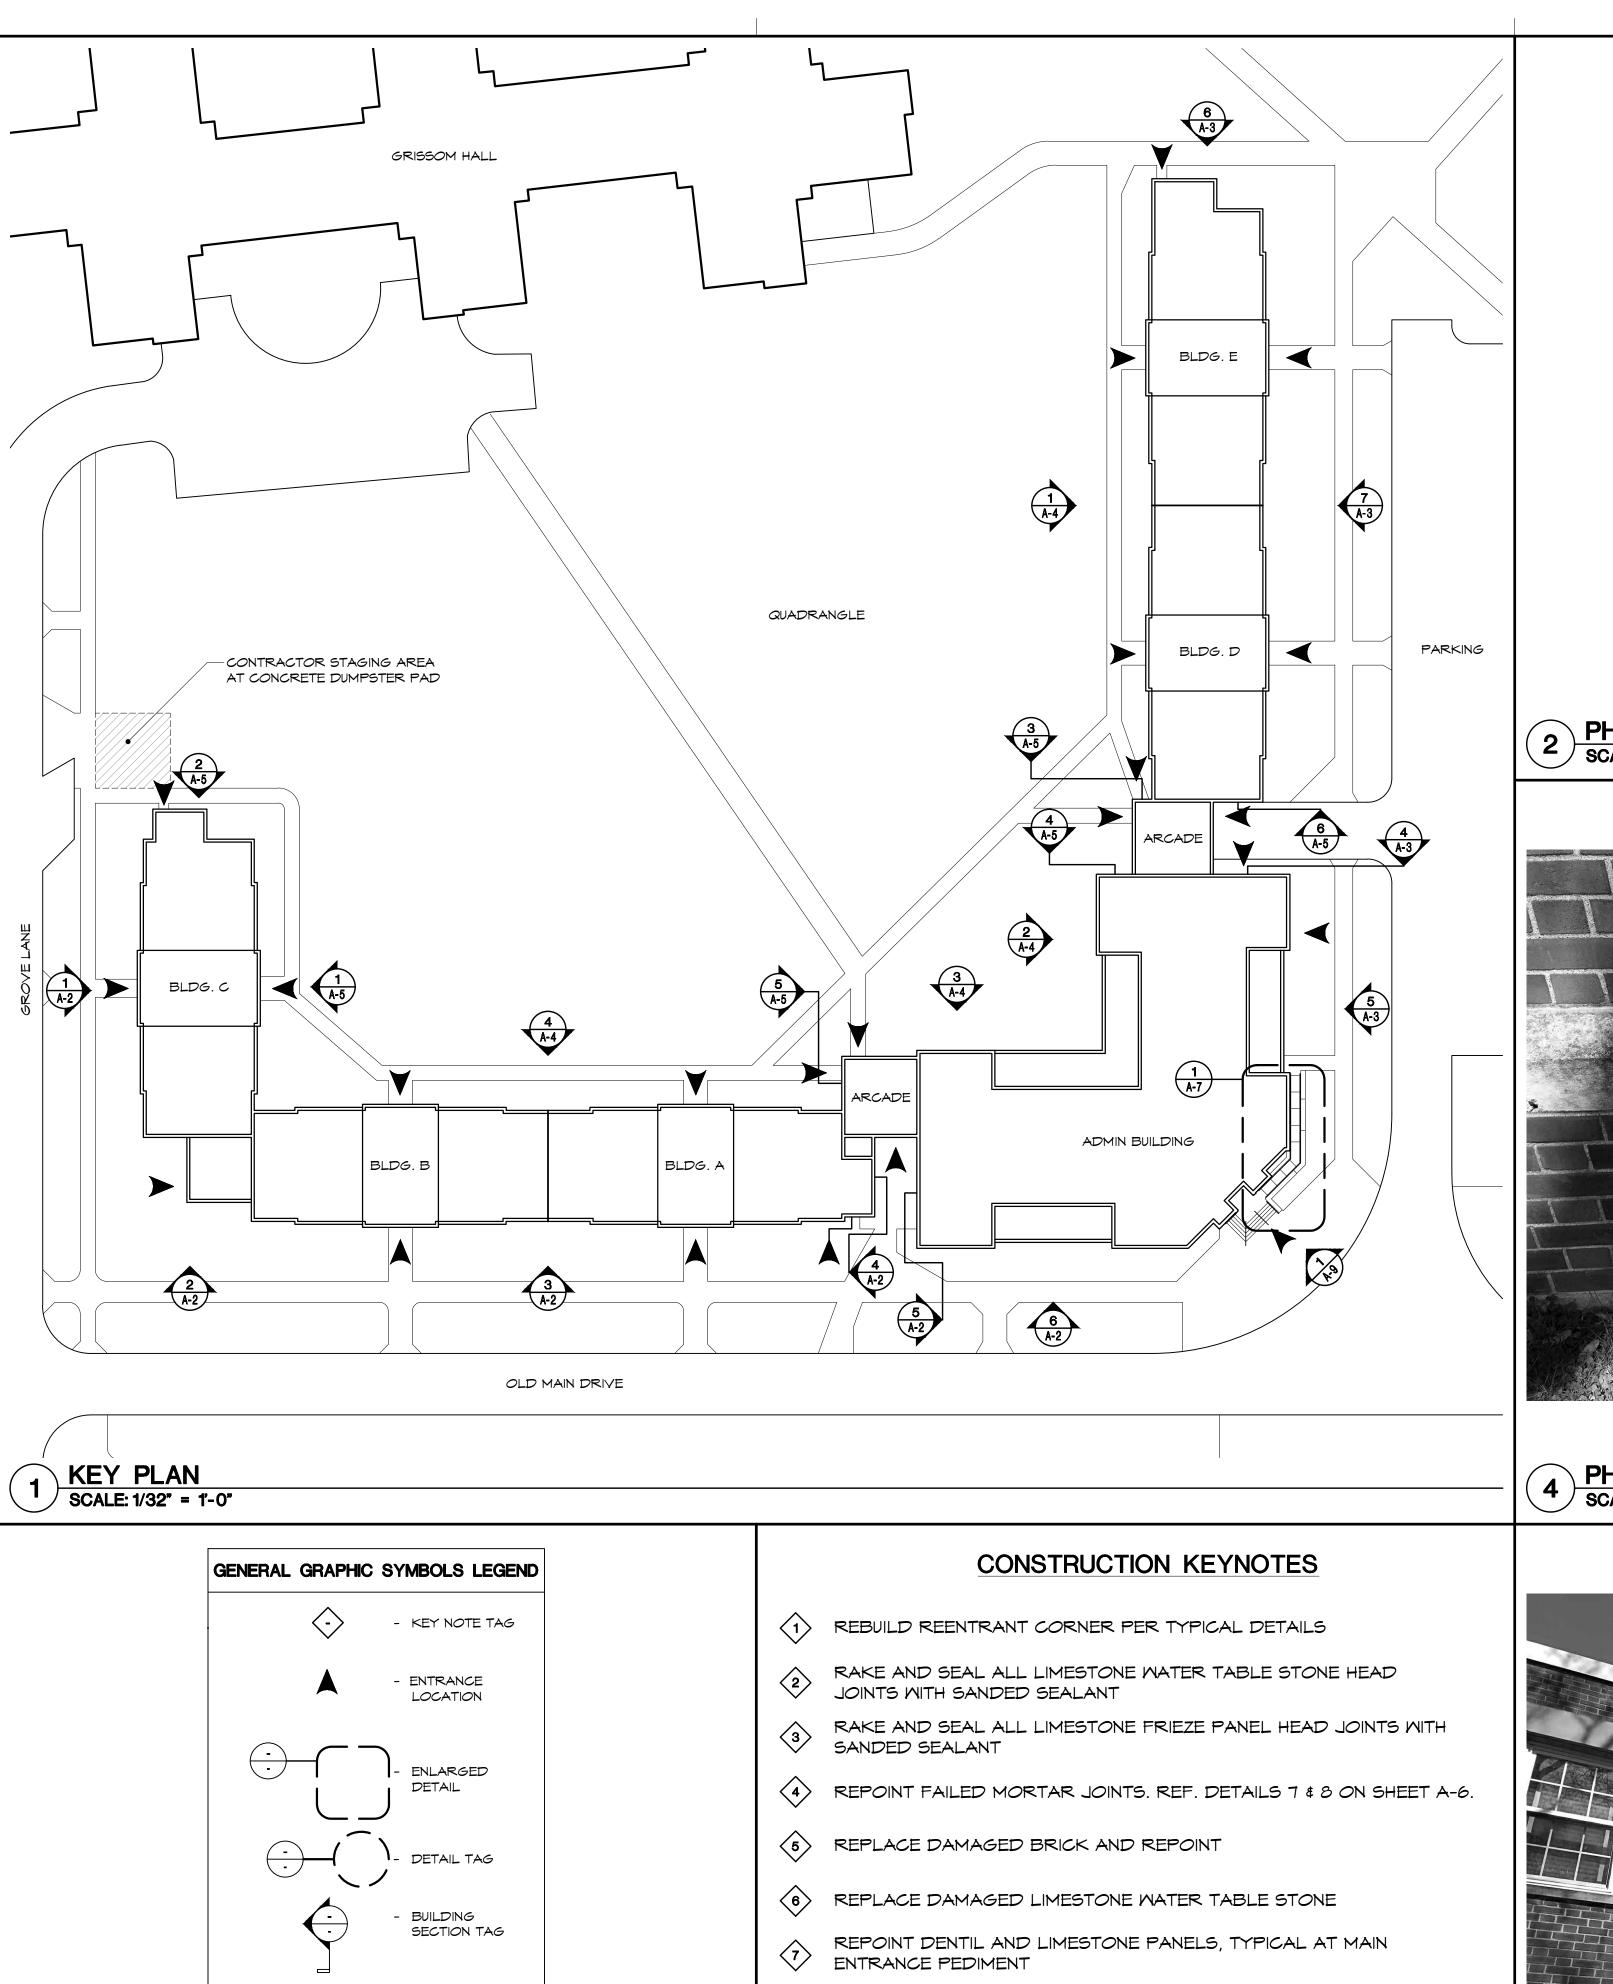

PHOTO - TYP. WATER TABLE STONE @ CORNER SCALE: N/A

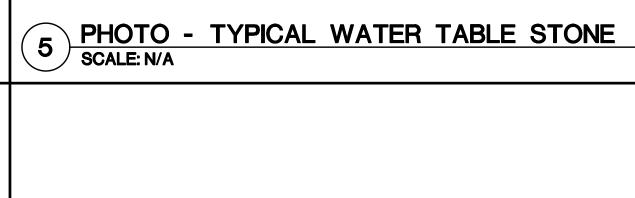

- 8 SHALLOW CONCRETE PATCH WITH REPAIR MORTAR
- 9 REPLACE SEALANT

- ELEVATION TAG

- PHOTO LOCATION

RAKE DORM ENTRANCE LIMESTONE PEDIMENT HEAD JOINTS. SEAL SKYWARD FACING JOINTS WITH SANDED SEALANT. REPOINT VERTICAL JOINTS WITH MORTAR. REF. PHOTOS 7 & 8 ON SHEET A-5.

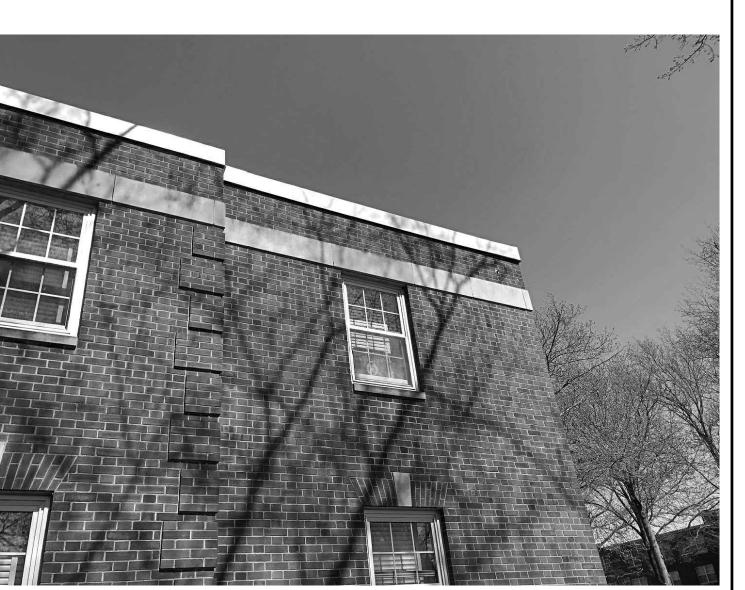


PHOTO - TYPICAL LIMESTONE FRIEZE PANELS
SCALE: N/A

NOT USED SCALE: N/A



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PROJECT NUMBER 378-21-002

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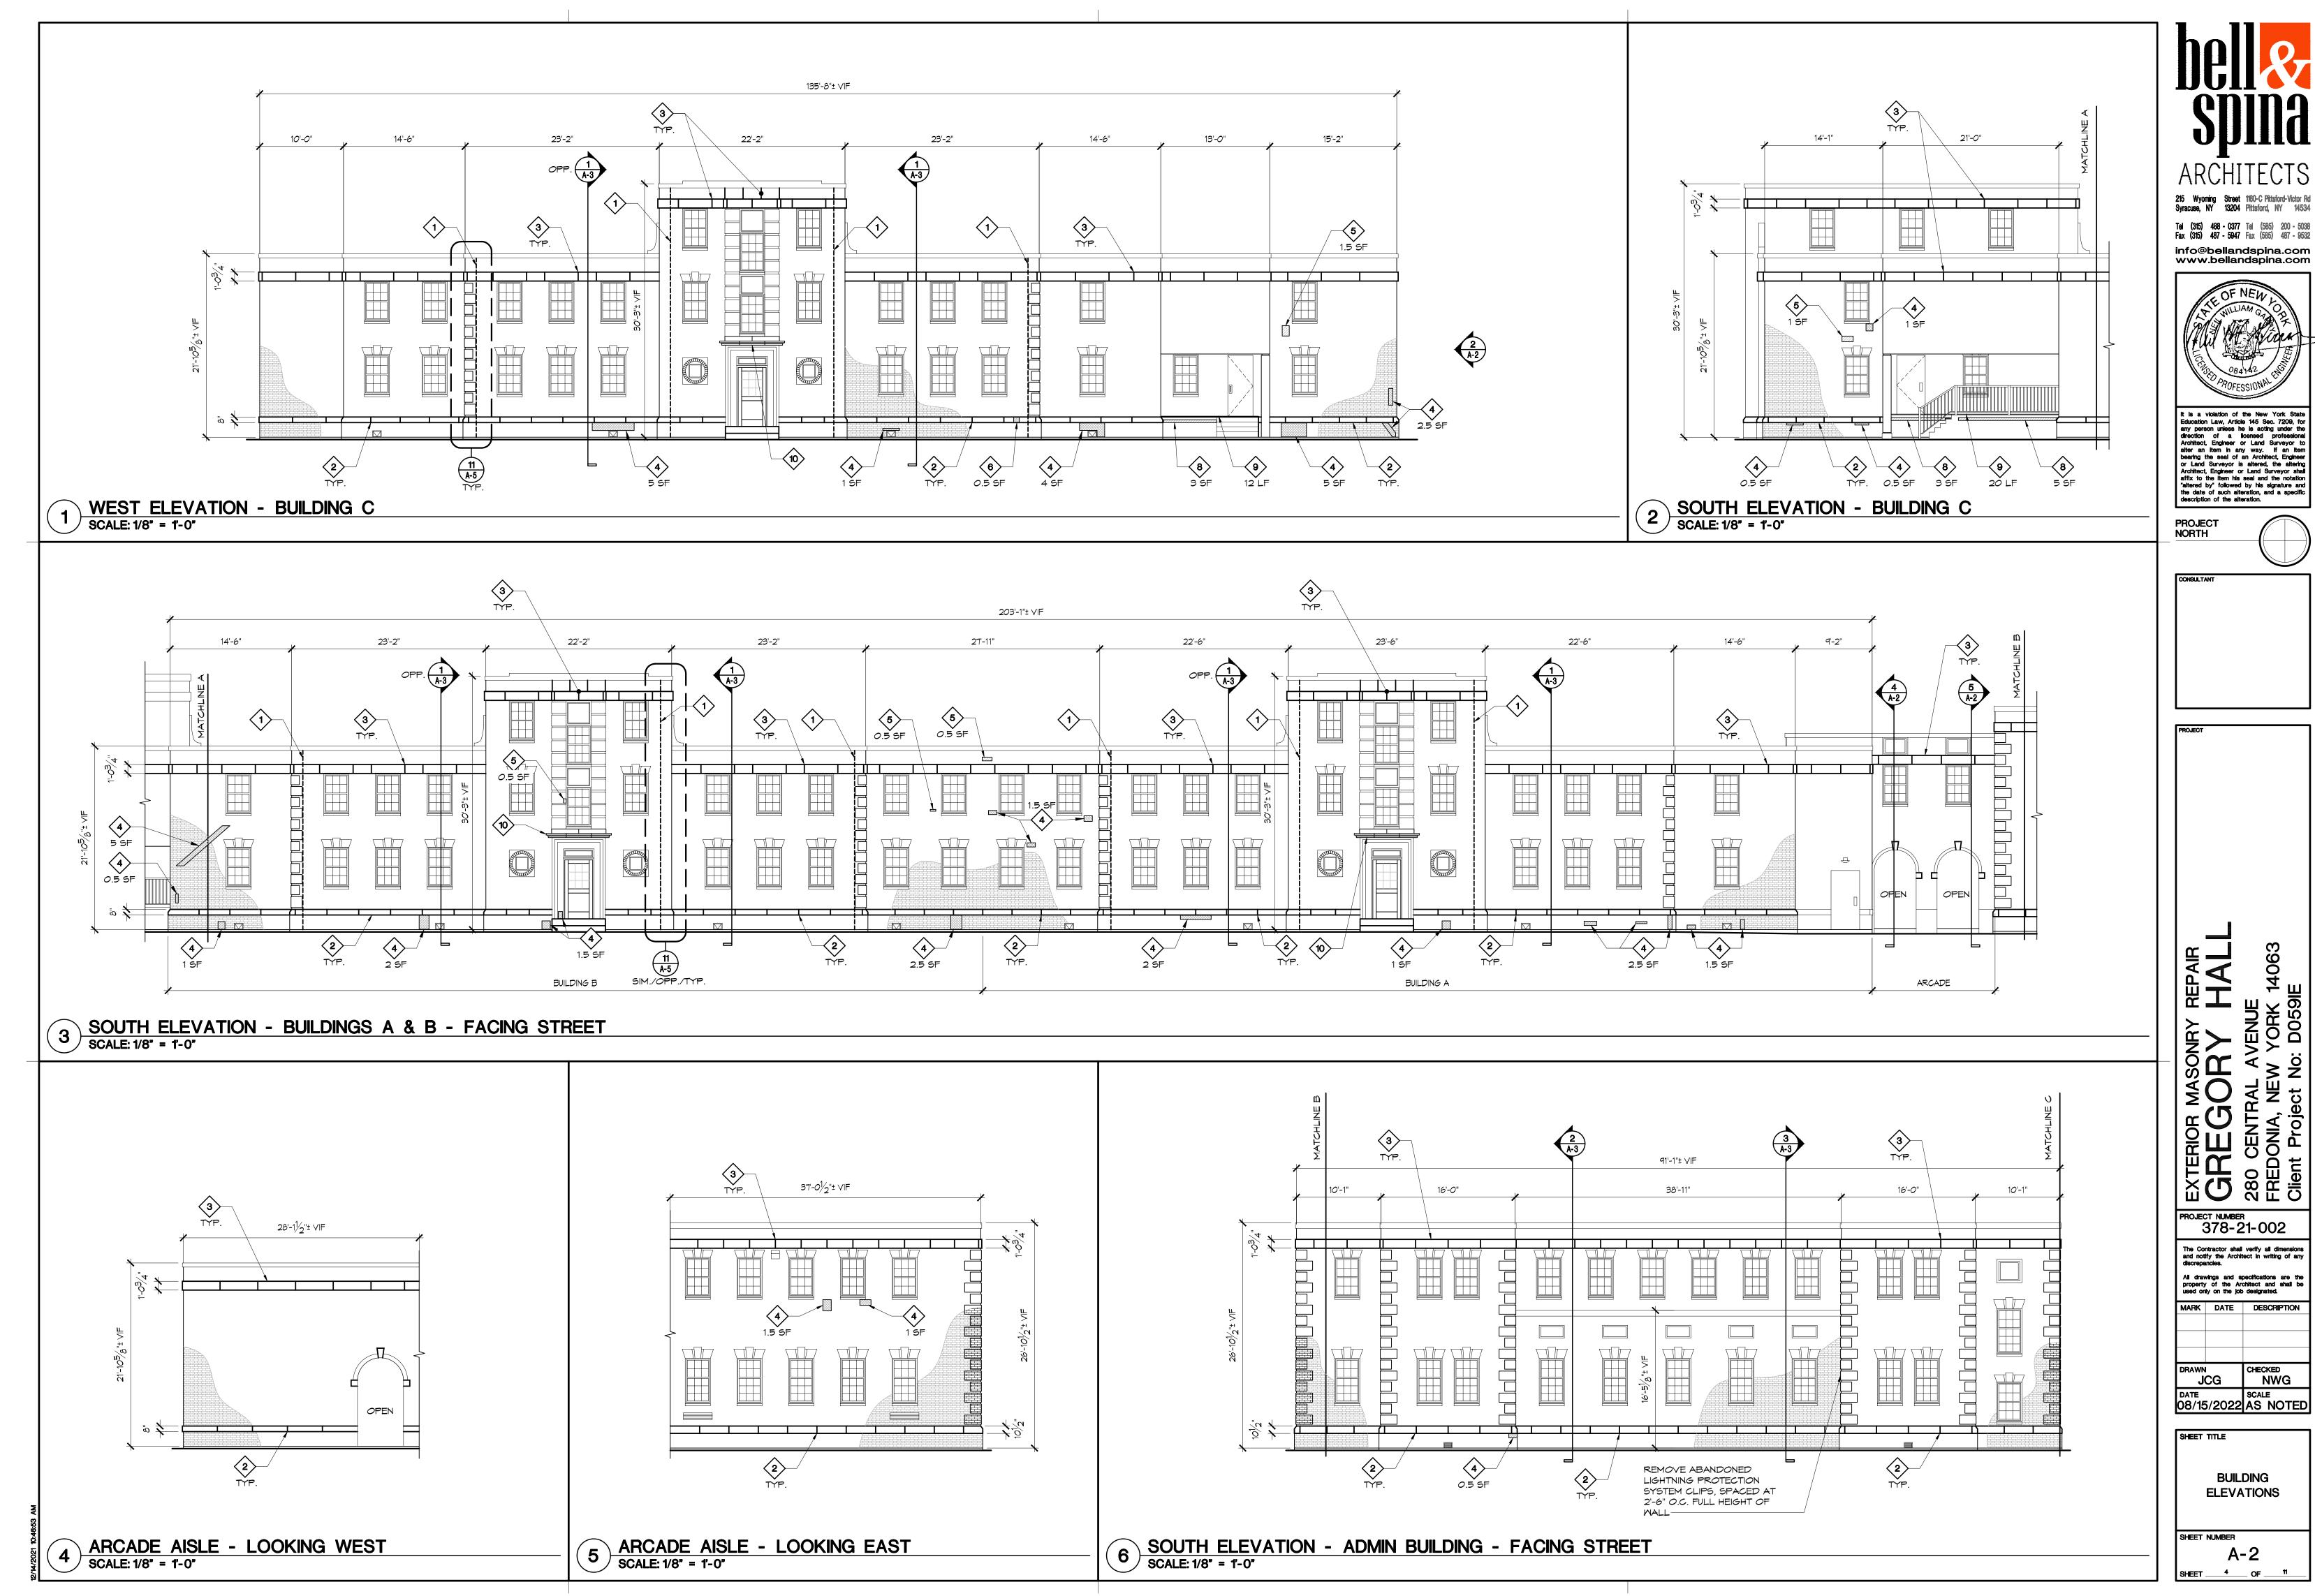
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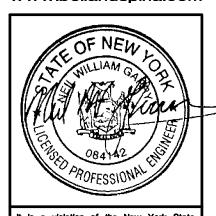
SHEET TITLE

KEY PLAN, CONSTRUCTION NOTES, AND REFERENCE PHOTOS

SHEET NUMBER A-1

SHEET _____3 ___ OF ____11





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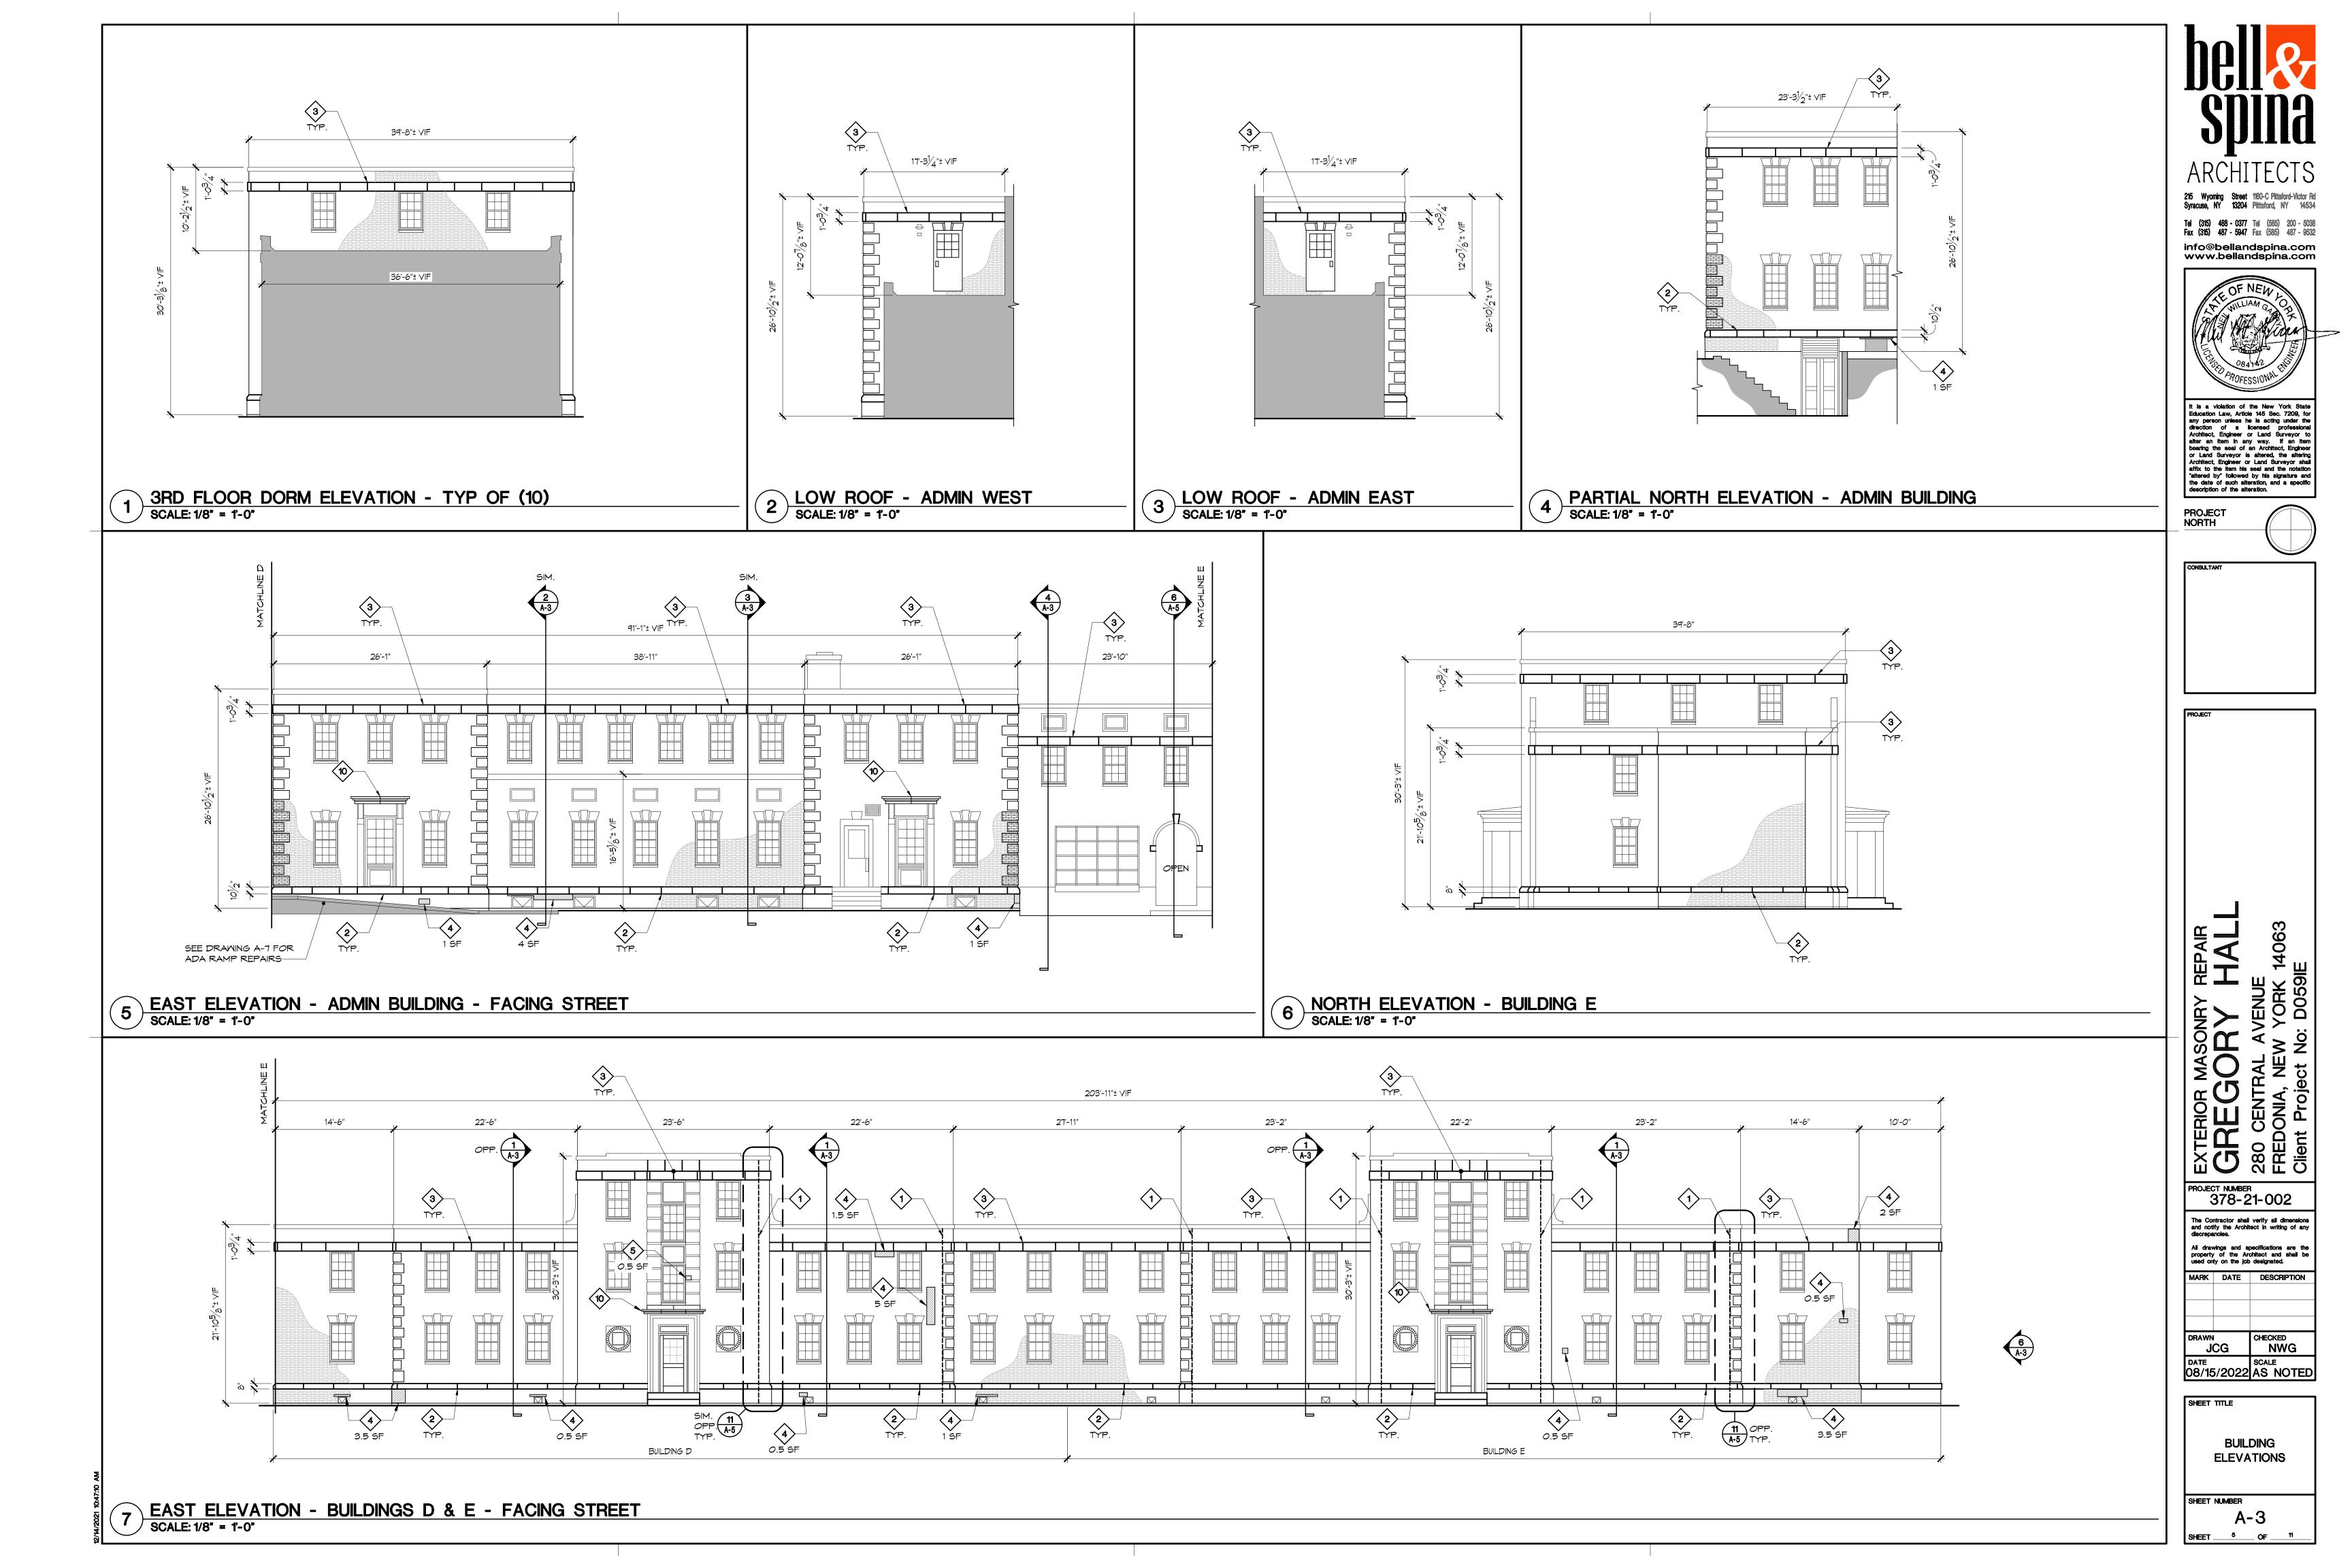
PROJECT NUMBER 378-21-002

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CHECKED NWG DATE SCALE O8/15/2022 AS NOTED

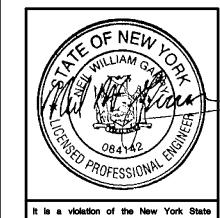
BUILDING **ELEVATIONS**

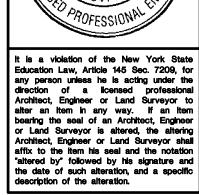
SHEET NUMBER A-2 SHEET _____4 OF ____11

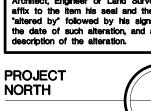


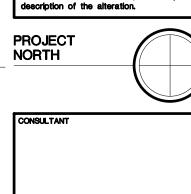


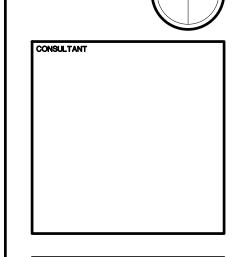
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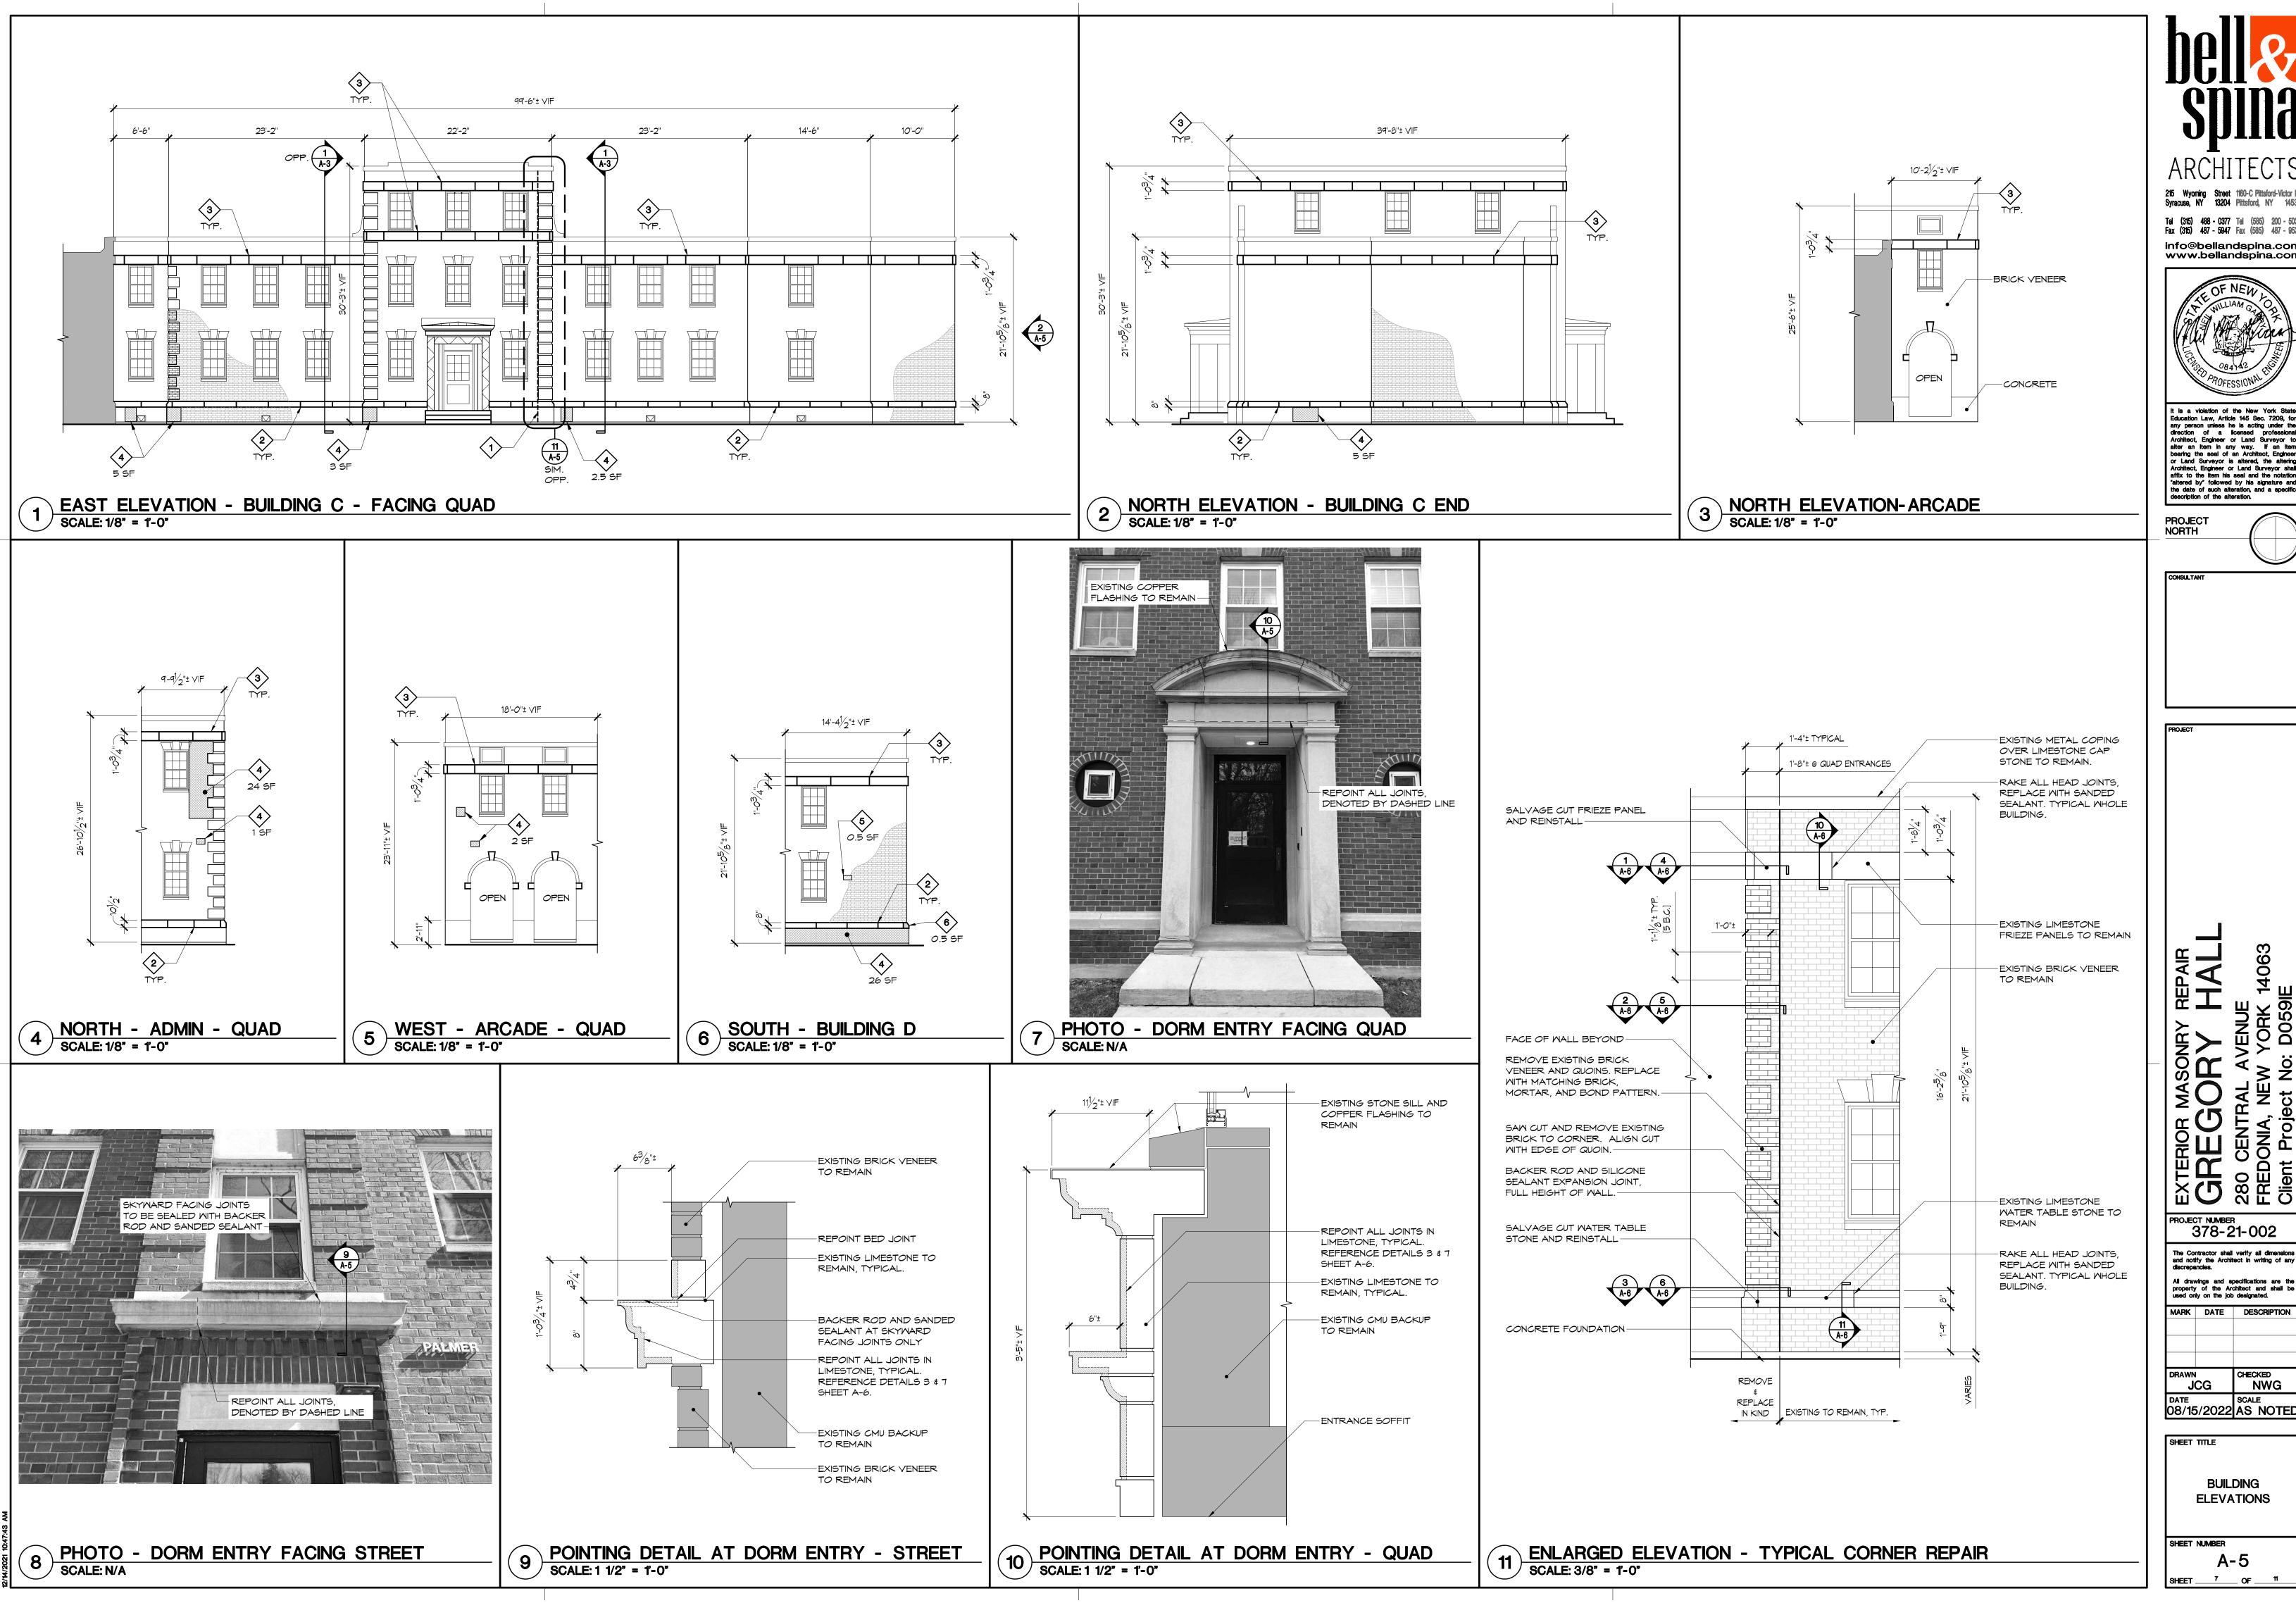
PROJECT NUMBER 378-21-002 The Contractor shall verify all dimensions and notify the Architect in writing of any All drawings and specifications are the property of the Architect and shall be used only on the job designated.

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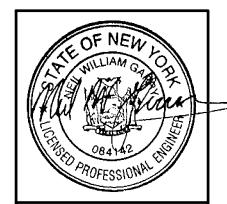
CHECKED NWG JCG DATE SCALE 08/15/2022 AS NOTED

BUILDING ELEVATIONS

SHEET NUMBER SHEET ______6 OF _____11



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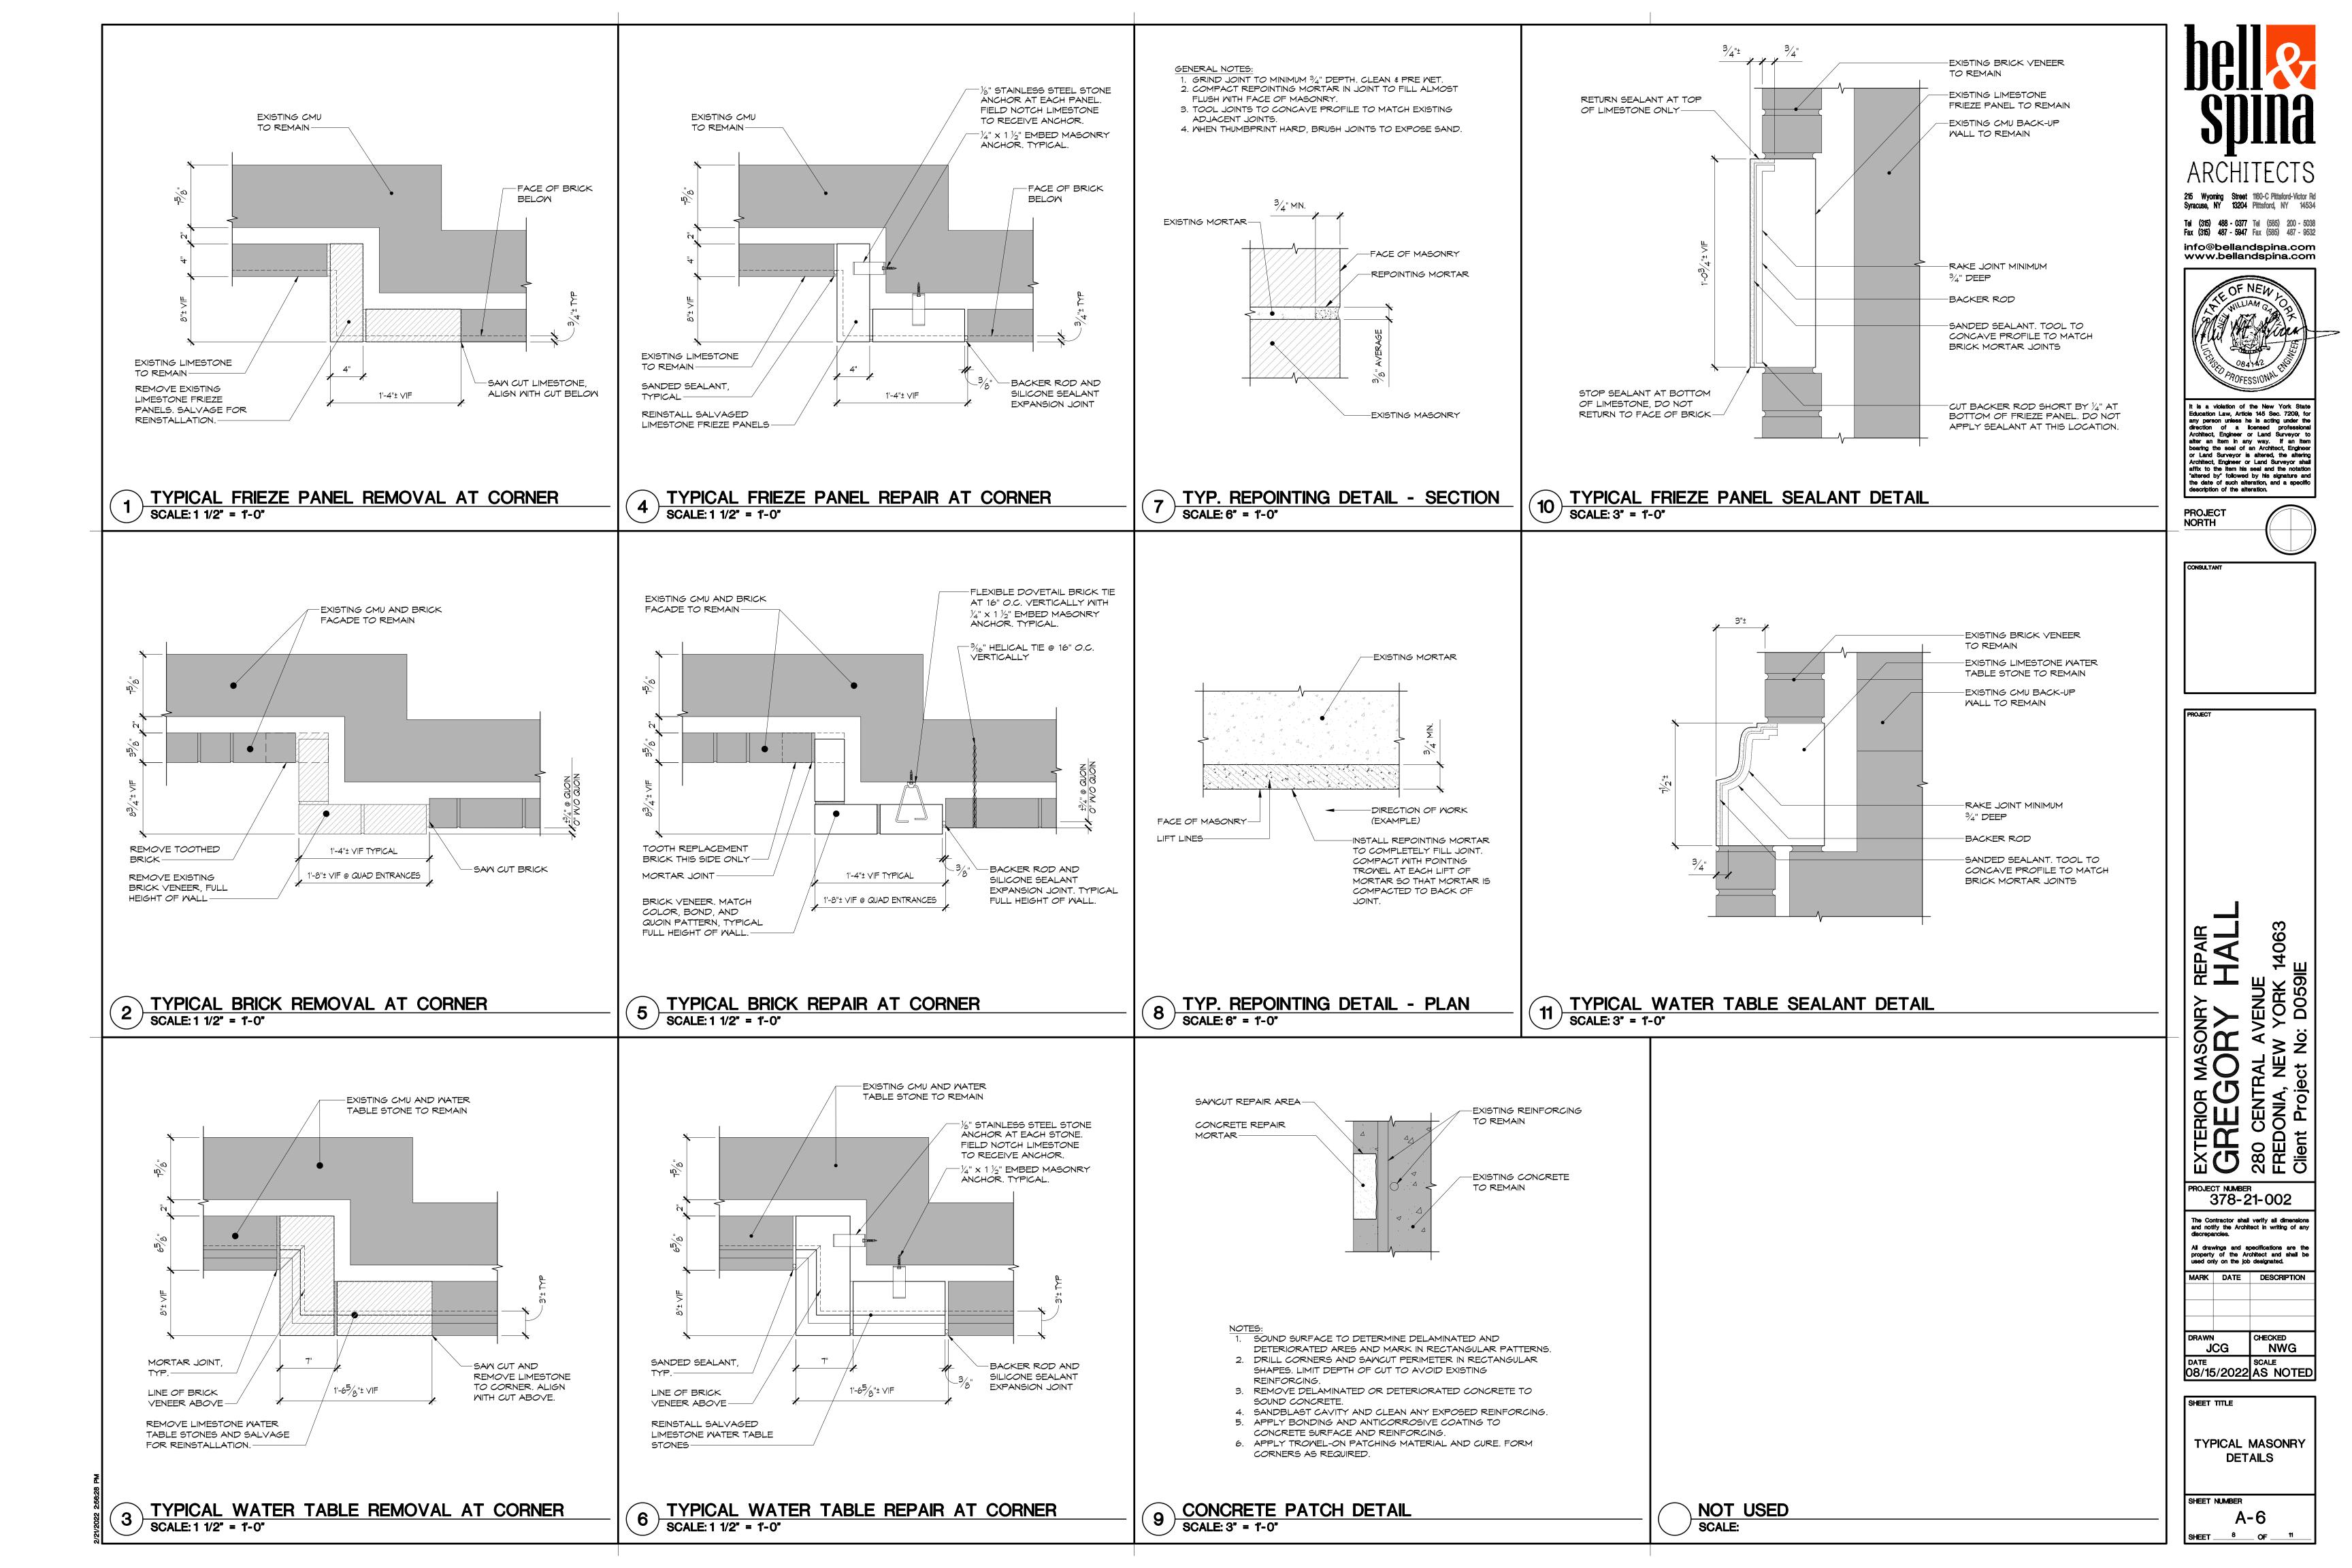
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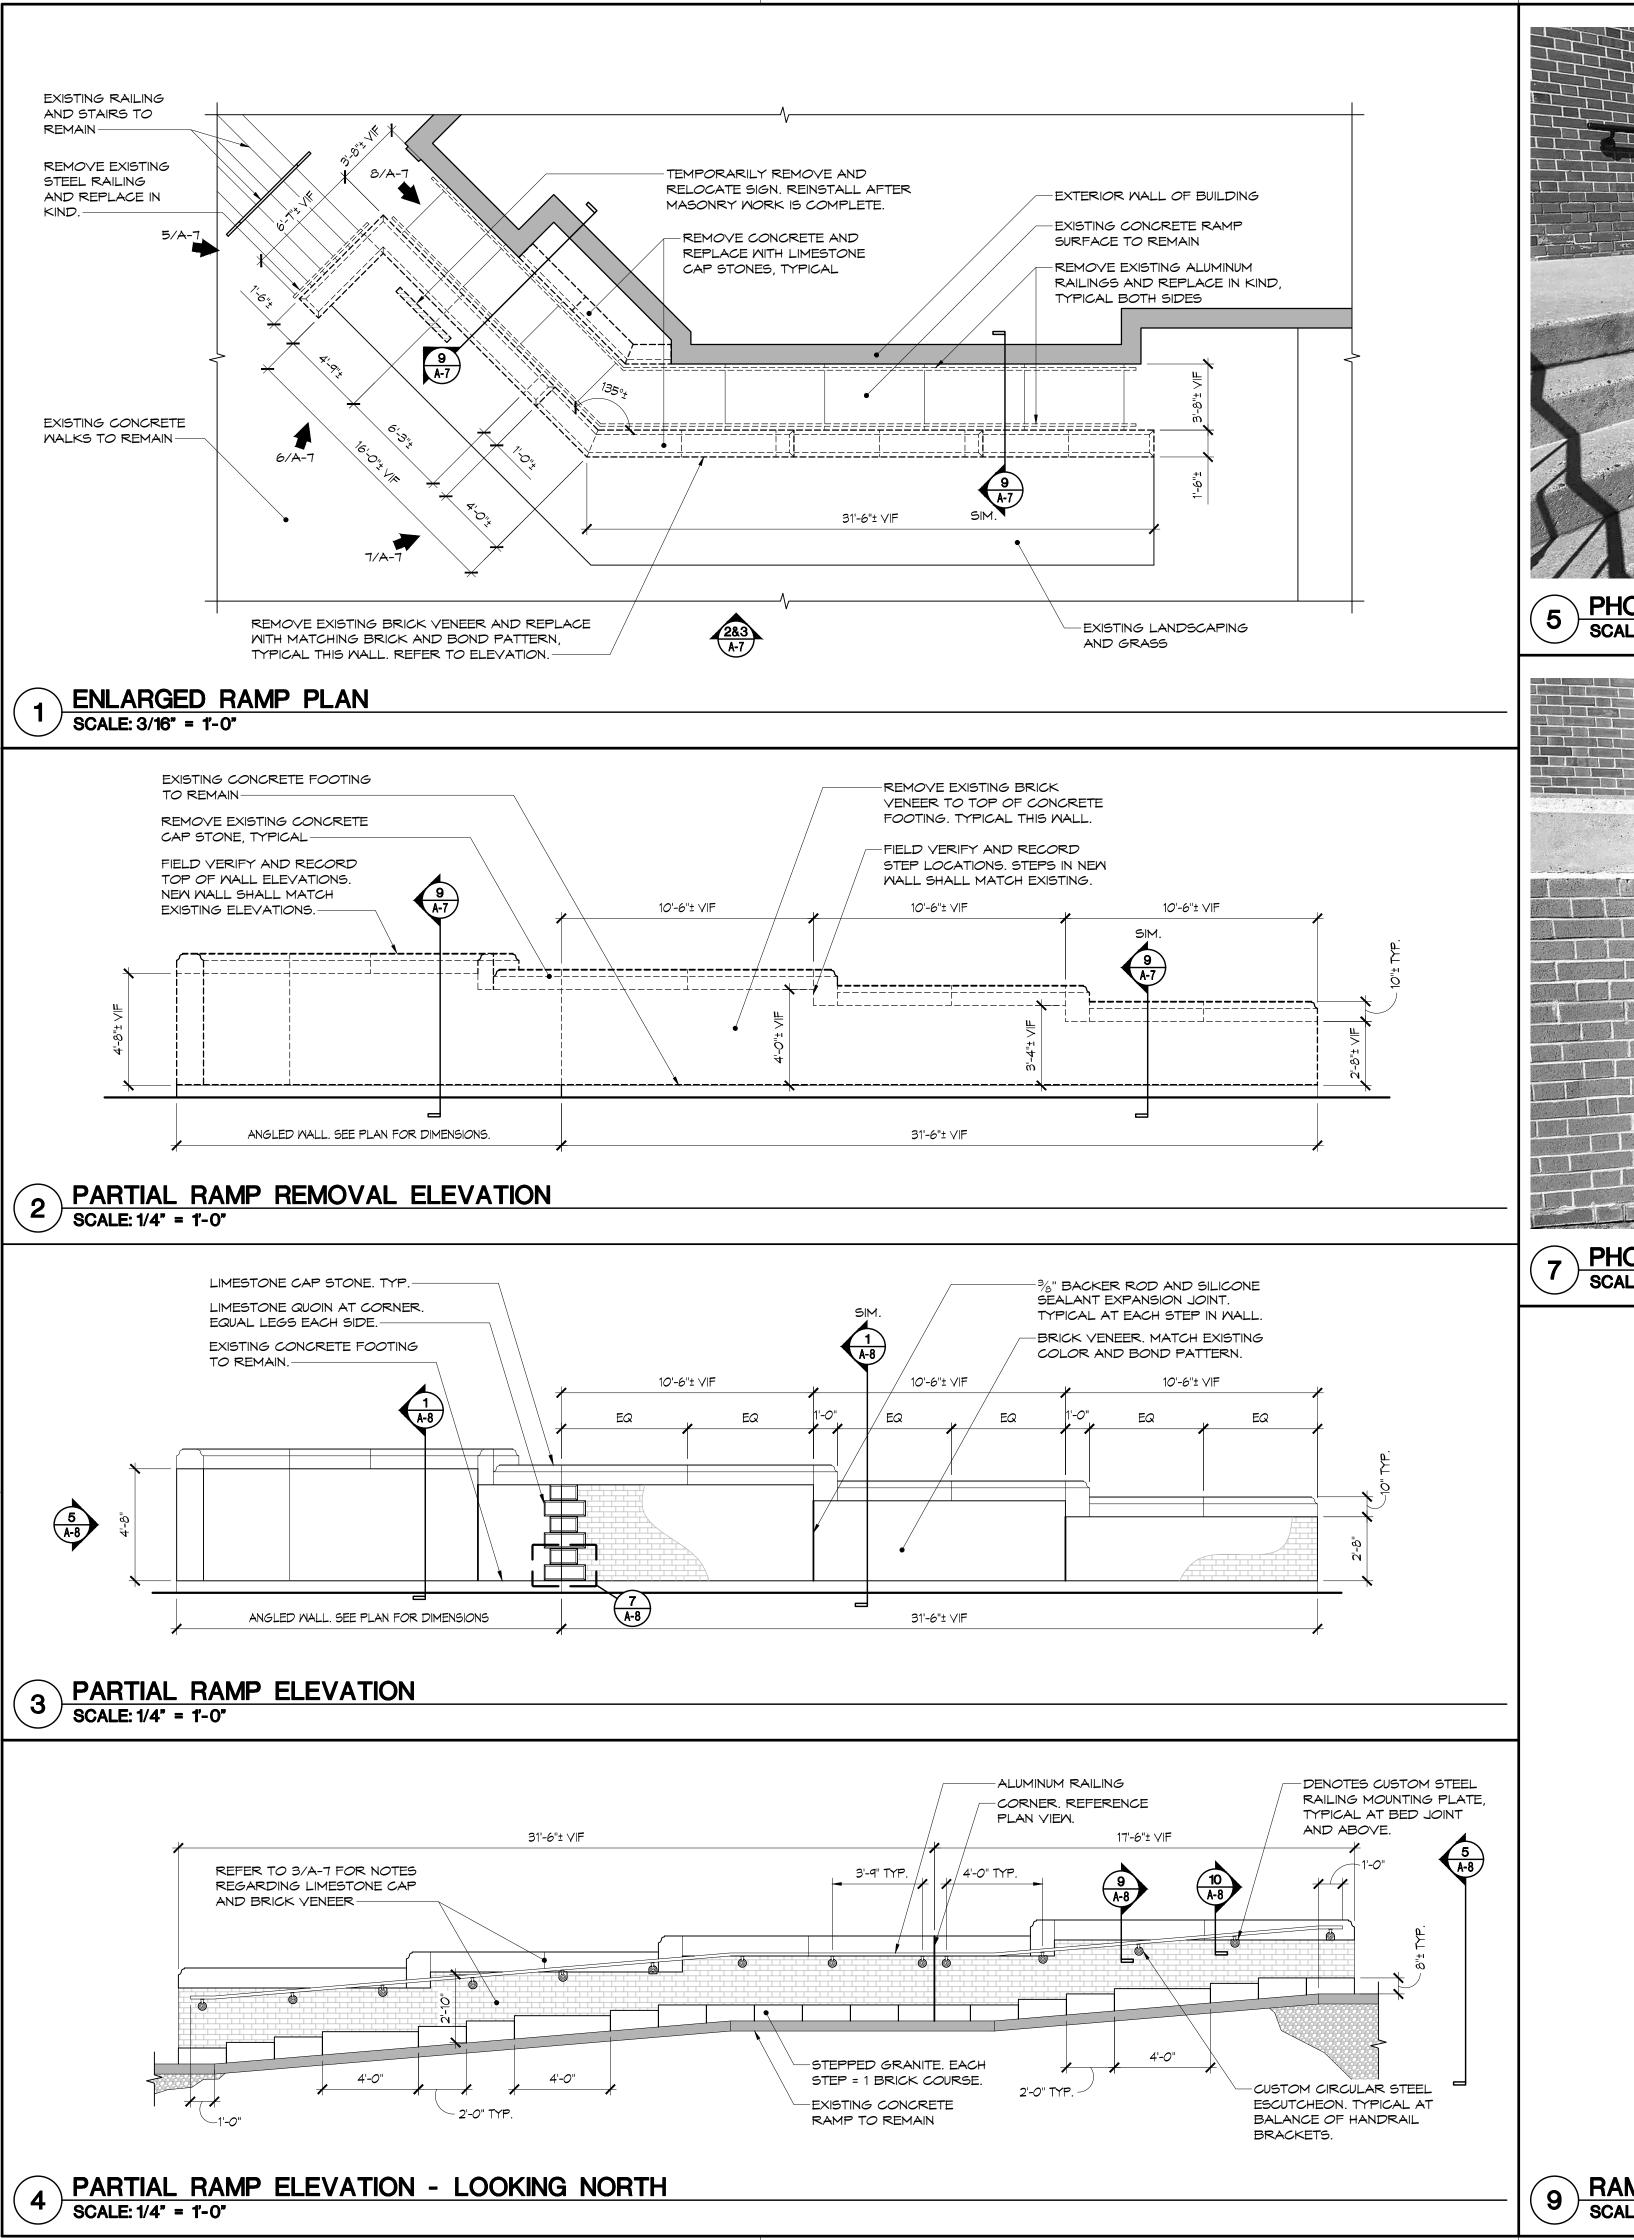
CHECKED NWG JCG SCALE

SHEET TITLE **BUILDING**

ELEVATIONS

SHEET NUMBER












6 PHOTO - RAMP 02 SCALE: N/A



PHOTO - RAMP 03 SCALE: N/A



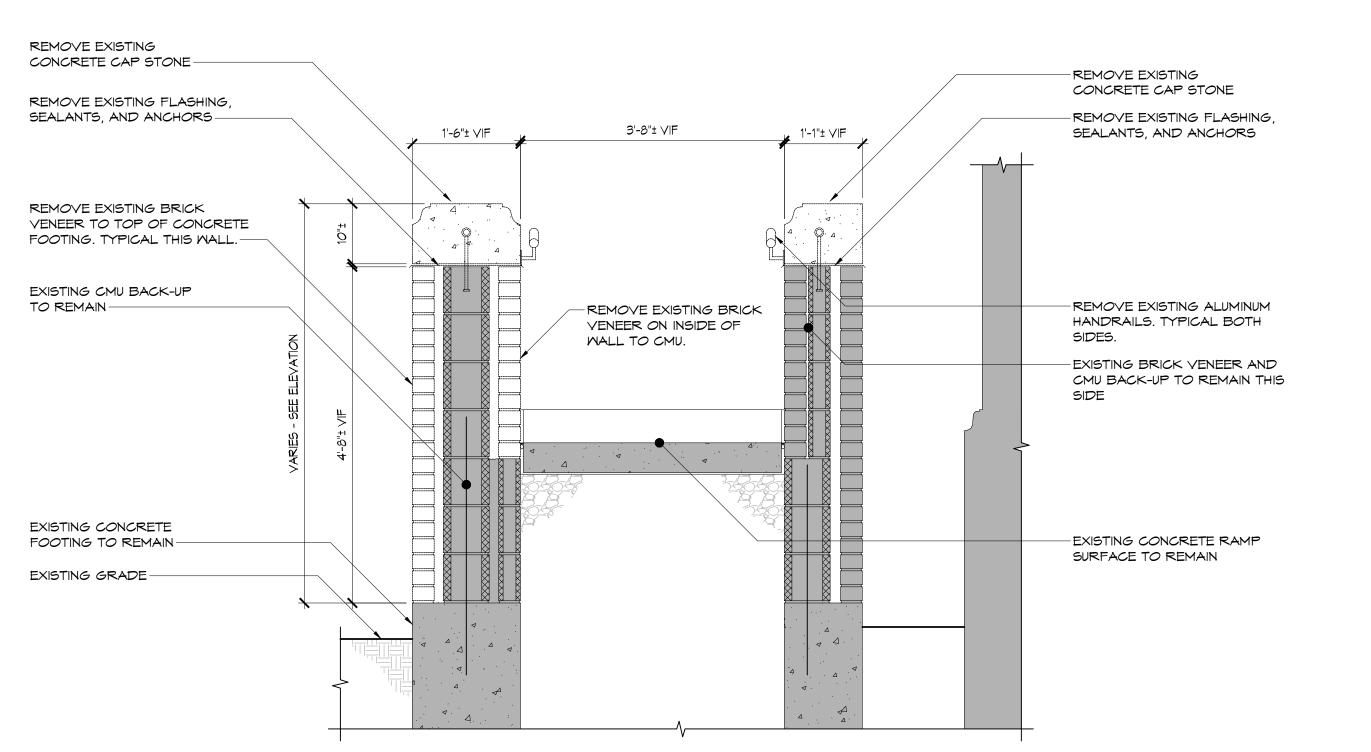8 PHOTO - RAMP 04 SCALE: N/A



RAMP REMOVAL SECTION SCALE: 3/4" = 1'-0"

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CHECKED NWG JCG

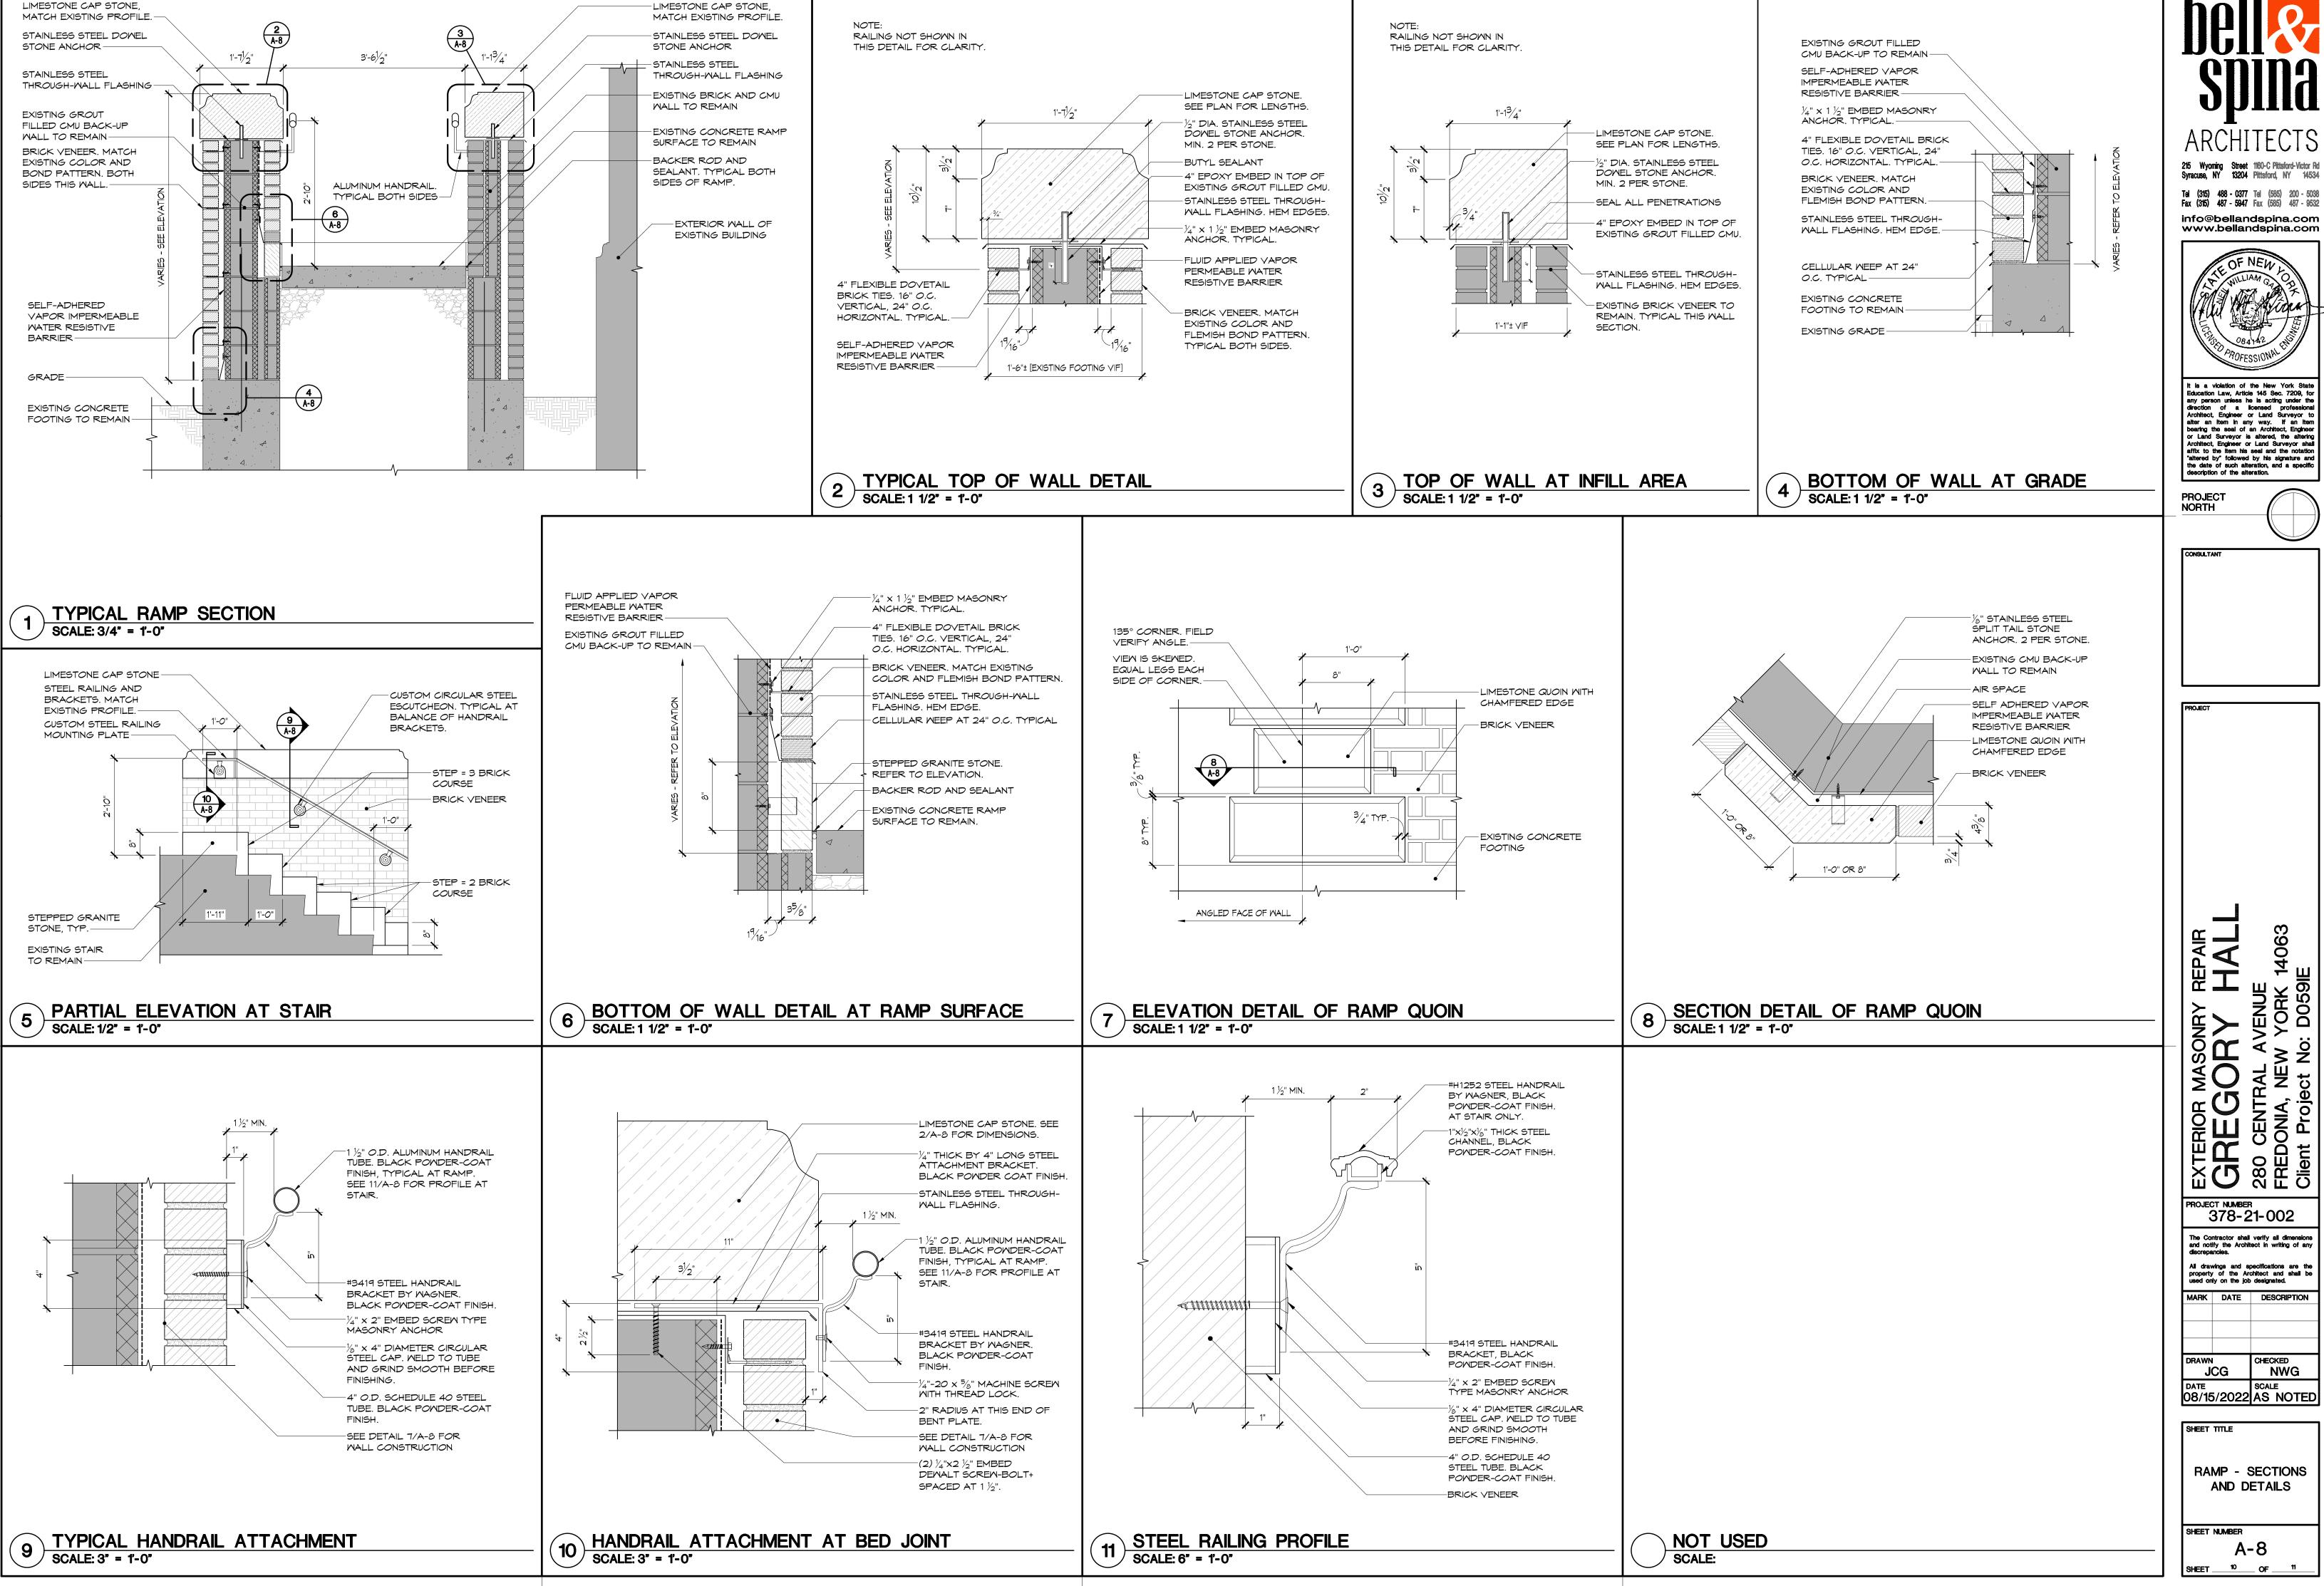
SCALE 08/15/2022 AS NOTED

SHEET TITLE

RAMP - ENLARGED PLAN, ELEVATIONS, SECTION, REFERENCE PHOTOS

SHEET NUMBER A-7

SHEET 9 OF 11





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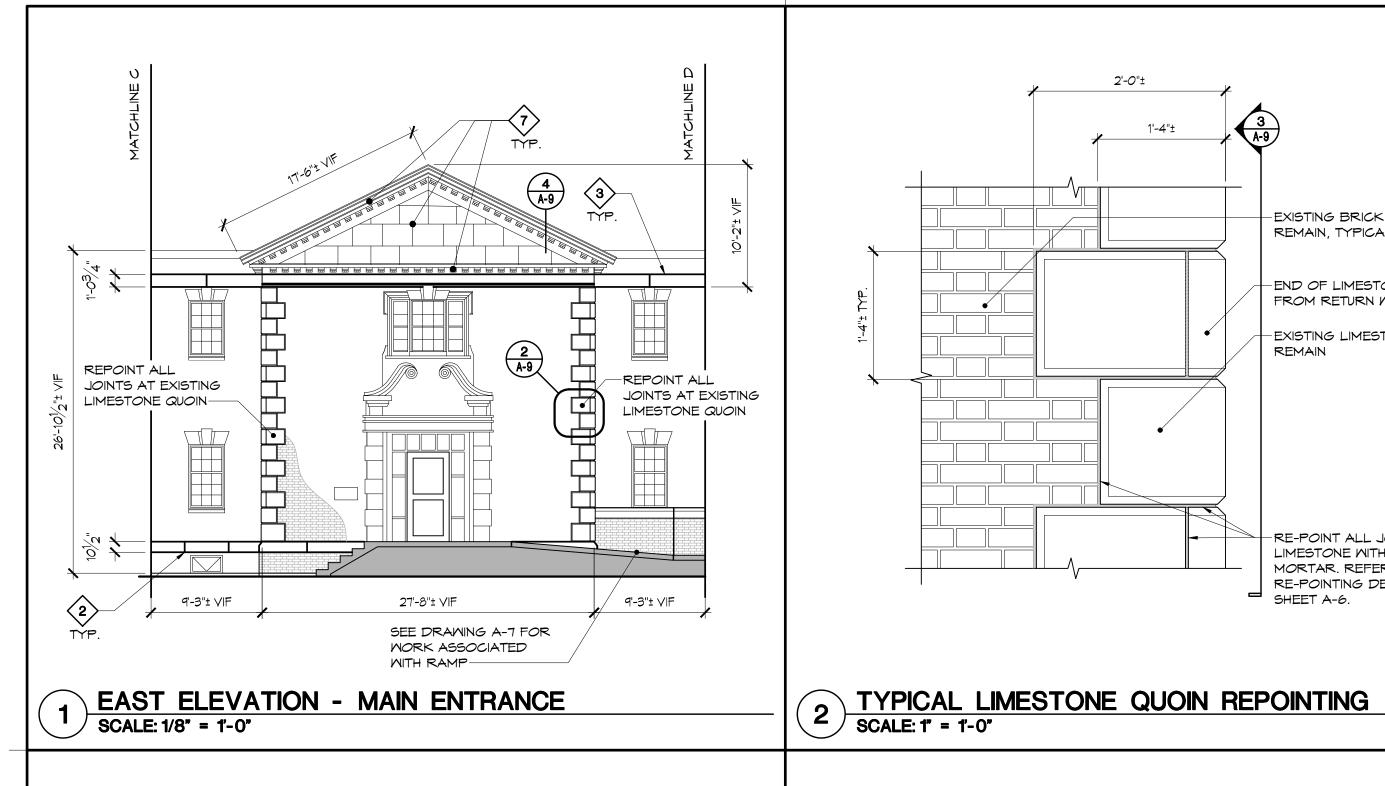
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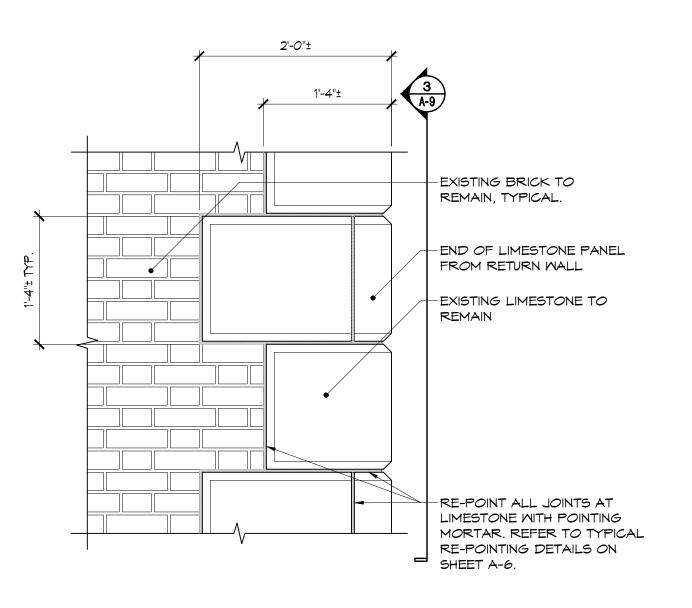
MARK DATE DESCRIPTION


NWG SCALE 08/15/2022 AS NOTE


RAMP - SECTIONS AND DETAILS

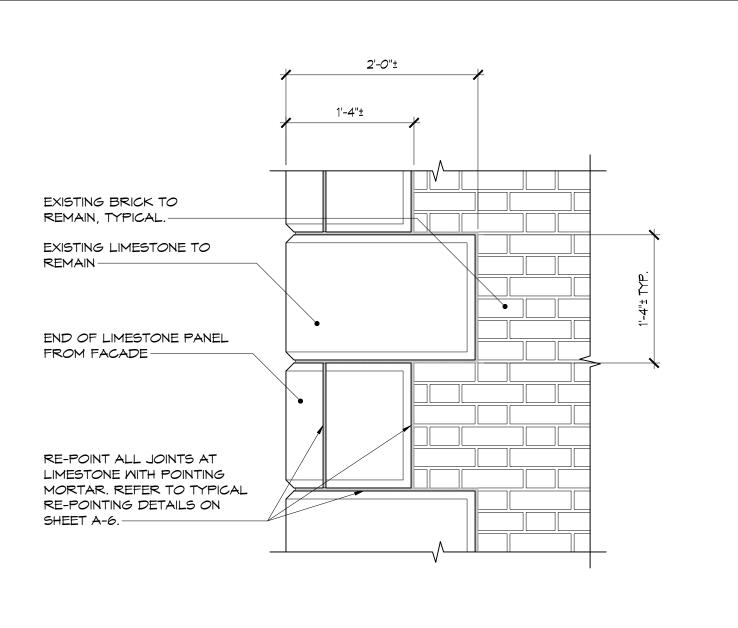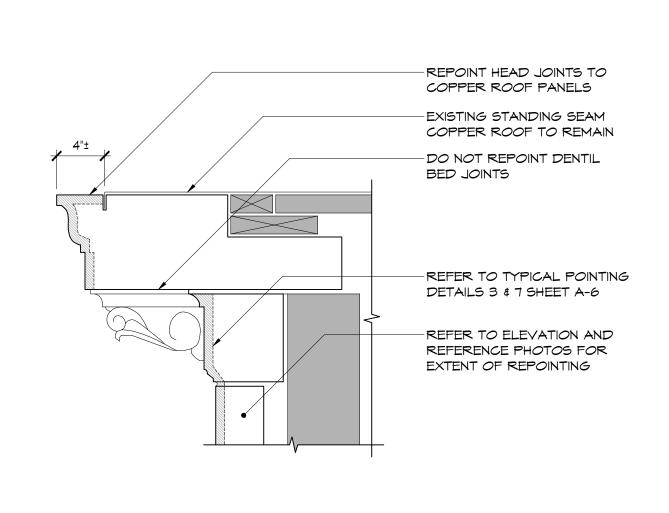SHEET NUMBER A-8









LIMESTONE REPOINTING AT RETURN WALL SCALE: 1" = 1'-0"

4 POINTING DETAIL AT CORNICE SCALE: 1 1/2" = 1'-0"



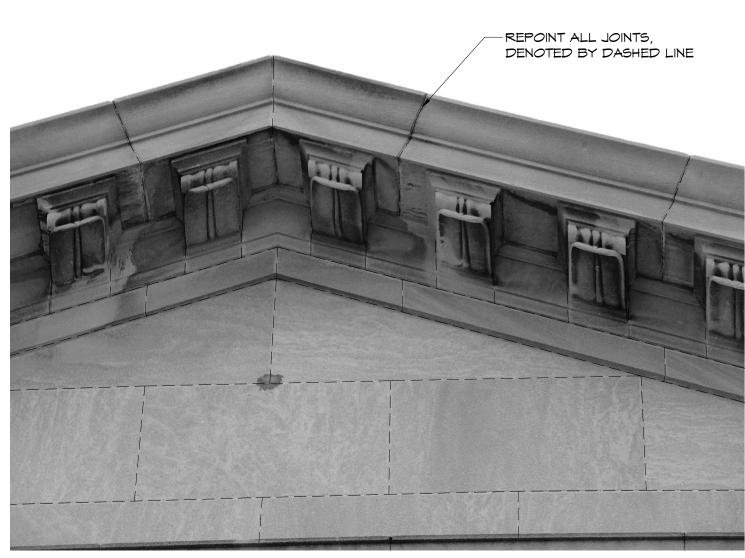







PHOTO - LIMESTONE DETAIL AT PEDIMENT 01 6 PHOTO SCALE: N/A

PHOTO - LIMESTONE DETAIL AT PEDIMENT 02 SCALE: N/A

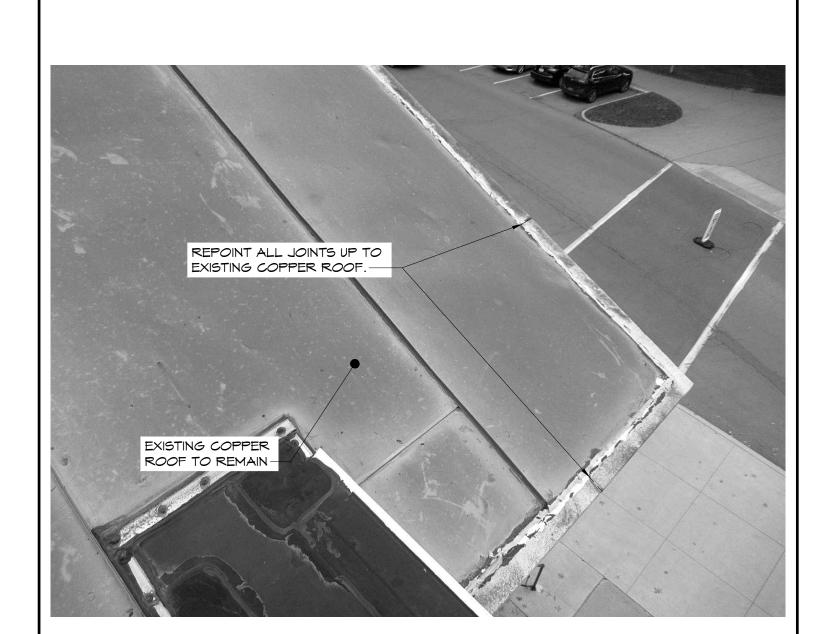8 PHOTO - LIMESTONE DETAIL AT PEDIMENT 03
SCALE: N/A



5 PHOTO - MAIN ENTRANCE PEDIMENT SCALE: N/A

9 PHOTO - CORNICE EDGE SCALE: N/A

NOT USED SCALE: N/A

PROJECT NUMBER 378-21-002 The Contractor shall verify all dimensions and notify the Architect in writing of any

info@bellandspina.com www.bellandspina.com

It is a violation of the New York State Education Law, Article 145 Sec. 7209, for any person unless he is acting under the direction of a licensed professional Architect, Engineer or Land Surveyor to alter an Item in any way. If an Item bearing the seal of an Architect, Engineer or Land Surveyor is altered, the altering Architect, Engineer or Land Surveyor shall affix to the Item his seal and the notation "altered by" followed by his signature and the date of such alteration, and a specific description of the alteration.

PROJECT NORTH

All drawings and specifications are the property of the Architect and shall be used only on the job designated. MARK DATE DESCRIPTION

CHECKED NWG

DATE SCALE O8/15/2022 AS NOTED SHEET TITLE

JCG

ENLARGED ENTRANCE | ELEVATION, DETAILS AND REFERENCE **PHOTOS**

SHEET NUMBER A-9 SHEET ______11 ___ OF _____11